
# URBANE CAFE 655 EAST BETTERAVIA RD, SANTA MARIA, CA 93454



## Coatsworth Architects, Inc. Irvine, California 9261 Phone: 949.833.193 Fax: 949.833.114

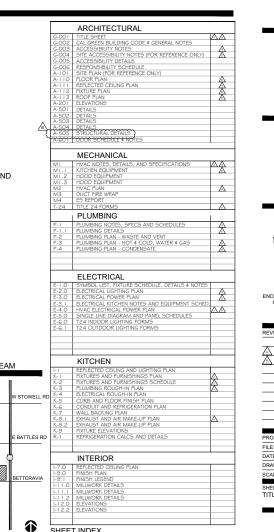

SHEET INDEX

#### PROJECT DATA APPLICABLE CODES/ CURRENT EDITIONS BUILDING MECHANICAL 2016 CALIFORNIA BUILDING CODE 2016 CALIFORNIA MECHANICAL CODE 2016 CALIFORNIA PLUMBING CODE ARCHITECT CARLILE COATSWORTH ARCHITECTS, INC. PLUMBING ELECTRICAL FIRE/LIFE SAFETY ACCESSIBILITY 2016 CALIFORNIA ELECTRICAL CODE ATTN: CHRIS PAXTON 2016 CALIFORNIA FIRE CODE 2495 CAMPUS DRIVE SAFETY 2016 CALIFORNIA FIRE CODE IBILITY 2016 CALIFORNIA BUILDING CODE, ADA 2016 CALIFORNIA EVERGY CODE 2016 CALIFORNIA GREEN BUILDING STANDARDS CODE SECOND FLOOR IRVINE, CA 92612 ENERGY PHONE: (949) 833-1930 FAX: (949) 833-1140 BUILDING CLASSIFICATION LEGAL DESCRIPTION LOT 14 128-078-013, 004 \$ 005 OCCUPANCY GROUP CONSTRUCTION TYPE V-B YES RPM ENGINEERS, INC SPRINKLERED NUMBER OF STORIES ATTN: RAYMOND PHILA 102 DISCOVERY IRVINE, CA 92618 PER APPROVED "ENOS ZONING RANCH" SPECIFIC PLAN PHONE: (949) 450-1229 (PD/F/CD-2) **KITCHEN DESIGN** BUILDING AREA COASTLINE DESIGN, INC. ATTN:BOB KUCHINSKI I I 3 E. 23RD STREET, 1,475 S.F. BUILDING ΤΟΤΑΙ 1,475 S.F. OCCUPANCY DINNING WAITING AREA 65 S.F. 13 OCCUPANTS 367 S.F. 25 OCCUPANTS 673 S.F. 4 OCCUPANTS 258 S.F. 1 OCCUPANTS 1/5 13 OCCUPANTS 1/15 SEATING AREA 4 OCCUPANTS 1 OCCUPANTS KITCHEN ACCESSORY + TOILET 1/300 TOTAL: 43 OCCUPANTS PATIO 474 S.F. 32 OCCUPANTS 1/15 EXIT WIDTH EXPEDITOR EBI CONSULTING EXIT WIDTI REQ'D SE/ # OF OCCUPANCY AREA PROVIDED OCCUPANT OCC 4 X 0.2 = 0.8 68" 673 SF 200 432 29 X 0.2 = 5.8 68" ACCESSORY 258 SE | X 0 2 = 02

TOTA TOTAL EXITS REQUIRED: TOTAL EXITS PROVIDED: MAXIMUM TRAVEL DISTANCE 75 FEET PER CBC 100G.2.1.

PARKING

SCOPE OF WORK

AREA TO BE LEVELED OR PATCHED

PARTITION / DOOR TO BE DEMOLISHED

EXISTING DEMISING OR PARTITION WALL TO REM

NEW PARTITION WALL

NEW RATED PARTITION

EINISH ELOOP LINE

TENANTS LEASE LINE

LINE OF SOFFIT OR

ROOM NAME 4 NUMBER

ELEVATION SHEET NUMBER

SECTION NUMBER

ELEVATION REFERENCE DWG. NO.

DETAIL NUMBER

COLUMN GRID MARK

PARTITION TYPE

CEILING HEIGHT

FINISH SCHEDULE MATERIAL FINISH / BREAK

DOOR SCHEDULE NUMBER

WINDOW SCHEDULE NUMBER

INISH DESIGNATION SEE

SHEET NUMBER

CENTER, LINE

REVISION

2

ROOM 001

1 A-201

1 A-301

(1) (A-401)

1 A-101

(A)

(001)

 $\langle \cdot \rangle$ 

 $\diamond$ 

10'-0"

<u>\_\_\_\_</u>

SYMBOLS LIST

PROPERTY LINE

DEFERRED SUBMITTALS

2. PROVIDING NEW NON BEARING WALLS/ PARTITIONS.

FIRE SPRINKLER SYSTEM MODIFICATIONS FIRE ALARM SYSTEM MODIFICATIONS

NEW: OLLING, SOLLING, AND KITCHEN DISCIPLINES.

PARKING THIS IS A TENANT IMPROVEMENT ONLY. SCOPE OF WORK DOES NOT CHANGE CURRENT/EXISTING APPROVED USE. THIS TENANT IMPROVEMENT STILL COMPLIES WITH THE EXISTING PARKING TALLY FER THE APPROVED CITY FLAN FOR "ENOS RANCHOS - BRADLEY WEST

KITCHEN 673 SF / 2 DINNING 432 SF / 3	0 = 15								
DINNING 432 SE / 3									
PATIO 474 SF / 3									
ACCESSORY 258 SF									
(18 MEN AND 18 V	VOMEN)								
PLUMBING MEN WOMEN	UNISEX								
FIXTURES REQ'D PROVIDED REQ'D PROVIDED REC	D PROVIDED								
WATER CLOSET I I I I 0	0								
LAVATORY I I I I 0	0								
URINAL I I O O O	0								
TUMBING FIXTURES CALCULATIONS PER 2016 C.P.C. TABLE 422.1 AND OCCUPANT LOAD PACTORS PER BBC, DSA-SS AND DSA-SSICC - TABLE A. PLEASE REFERT TO NOTE #3 TABLE 422.1 FOR SINGLE OCCUPANCY TOILET FACILITIES. PRO.IECT SLIMMARY									

HOOD EXTINGUISHING SYSTEMS TENANT SIGNAGE/AWNINGS

3 NEW: CEILING, SOFFIT, HOOD, KITCHEN, DUCTWORK, AND EXHAUST OWNER/DEVELOPER

URBANE CAFE ATTN: DANI MAYER 78 N. ASH ST. VENTURA, CA 93001

T.B.D.

PHONE: (714) 381-9548

GENERAL CONTRACTOR

STUDIO MYID ATTN: JONAS VAN VLIET 2926 UPAS STREET SAN DIEGO CA 92104 PHONE: (714) 915-7332

ATTN: TERRY WOMACK 6530 REFLECTION DRIVE #2381 SAN DIEGO, CA 92124 PHONE: (760) 707-9124 PROJECT DEVELOPMENT TEAM


PROJECT

## MECHANICAL, PLUMBING, AND ELECTRICAL ENGINEER

## COSTA MESA CA 92C27 PHONE: (949) 722-818

# INTERIOR DESIGN

VICINITY MAP

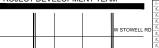

	PROJECT
_	FILE:
	DATE:
	DDAMALD

## G-OOI.DWG CP / TR DRAWN BY SCALE: AS NOTED

SHEET TITLE TITLE SHEET



FIRE DEPARTMENT NOTES

SPECIAL MECHANICAL / PLUMBING

ITY OF SANTA MARIA MUNICIPAL CODE, TITLE 9 BUILDING REGULATIONS SECTIONS 9-1.224 THRU 9-1.226 AMENDING C.B.C. SECTIONS 1705.19,1705.20, AND 1705.21. STATES

THAT SPECIAL INSPECTIONS ARE REQUIRED FOR THE FOLLOWING

APPROVED TESTING AGENCY OR QUALIFIED THIRD PARTY SPECIAL INSPECTOR. THIS CANNOT BE THE INSTALLING CONTRACTOR. THE SPECIAL INSPECTOR SHALL SUBMIT A FINAL SIGNED REPORT TO

THE BUILDING INSPECTOR PRIOR TO CITY ISSUANCE OF FINAL INSPECTION. REFER TO THE "SPECIAL MECHANICAL/ PLUMBING INSPECTIONS CERTIFICATE".

SMOKE DETECTORS WITH SMOKE DAMPERS AND H.V.A.C.

NOTE THAT THE G.C. WILL BE RESPONSIBLE TO HIRE AN

INSPECTIONS REQUIRED.

HUTOFF5. TWO LAYER FIRE WRAP SYSTEM

SPECIAL INSPECTION NOTES

AREAS

3 Urbane Cafe REVISIONS CLIENT

TENANT IMPROVEMENT
URBANE CAFE
S RANCHOS - BRADLEY WES 55 EAST BETTERAVIA RD.
SANTA MARIA, CA 93454

## CARPET SYSTEMS

# ALC CARPET INSTALLED IN THE BUILDING INTERIOR SHALL MEET THE TESTING MOP REDOLICT REQUIREMENTS OF ONE OF THE FOLLOWING: 1. CARPET MAD RUG INSTITUTES GREEN LABLE, PLUS PROGRAM 2. CALIFORNIA DEMARTINENT OF FUBLIC HEALTH STANDARD METHOD FOR THE TESTING MAD EVALUATION OF VOLATILE ORGANIC CHEMICAL EMISSIONS FROM INDOOR SOURCES USING ENVIRONMENTAL CHAMBERS, VERSION 1.1, FEBRUARY 2010 (ALSO KNOWN AS

- CIFICATION 01350) (ANSI 140 AT THE GOLD LEVEL OR HIGHER ENTIFIC CERTIFICATIONS SYSTEMS SUSTAINABLE CHOICE

## CARPET CUSHION

LL CARPET CUSHION INSTALLED IN THE BUILDING INTERIOR SHALL MEET THE EQUIREMENTS OF THE CARPET AND RUG INSTITUTE'S GREEN LABEL

#### CARPET ADHESIVE

## ALL CARPET ADHESIVE SHALL MEET THE REQUIREMENTS OF TABLE 5.504.4.1.

## RESILIENT FLOORING SYSTEMS

#### VERIFICATION OF COMPLIANCE

DOCUMENTATION SHALL BE PROVIDED VERIFYING THAT RESILIENT FLOORING MATERIALS MEET THE POLILITANT EMISSION LIMITS.

ARCHITECTURAL APPLICATIONS	CURRENT VOC LIM
INDOOR CARPET ADHESIVES	50
CARPET PAD ADHESIVES	50
OUTDOOR CARPET ADHESIVES	150
WOOD FLOORING ADHESIVE	100
RUBBER FLOOR ADHESIVES	60
SUBFLOOR ADHESIVES	50
CERAMIC TILE ADHESIVES	65
VCT AND ASPHALT TILE ADHESIVES	50
DRYWALL AND PANEL ADHESIVES	50
COVE BASE ADHESIVES	50
MULTIPURPOSE CONSTRUCTION ADHESIVES	70
STRUCTURAL GLAZING ADHESIVES	100
SINGLE-PLY ROOF MEMBRANE ADHESIVES	250
OTHER ADHESIVE NOT SPECIFICALLY LISTED	50
SPECIALTY APPLICATIONS	
PVC WELDING	510
CPVC WELDING	490
AB5 WELDING	325
PLASTIC CEMENT WELDING	250
ADHESIVE PRIMER FOR PLASTIC	550
CONTACT ADHESIVE	80
SPECIAL PURPOSE CONTACT ADHESIVE	250
STRUCTURAL WOOD MEMBER ADHESIVE	140
TOP AND TRIM ADHESIVE	250
SUBSTRATE SPECIFIC APPLICATIONS	
METAL TO METAL	30
PLASTIC FOAMS	50
POROUS MATERIAL (EXCEPT WOOD)	50
WCOD	30
FIBERGLASS	80

## TABLE 5.504.4.1 ADHESIVE VOC LIMIT

WALL AND FLOOR-CEILING ASSEMBLIES SEPARATING TENANT SPACES AND TENANT SPACES AND PUBLIC SPACES SHALL HAVE AN STC OF AT LEAST 40

## INTERIOR SOUND TRANSMISSION

- NERAL CONTRACTOR TO DEVELOP A WRITTEN PLAN OF PROCEDURES FOR STING AND ADJUSTING SYSTEMS. STEMS TO BE INCLUDED ARE: HVAC SYSTEMS AND CONTROLS INDOOR AND OUTDOOR LIGHTING AND CONTROLS

- WATER HEATING SYSTEMS RENEWABLE ENERGY SYSTEMS
- WATER REUSE SYSTEMS
- PERFORM TESTING AND ADJUSTING PROCEDURES IN ACCORDANCE WITH INDUSTRY PRACTICES AND APPLICABLE STANDARDS ON EACH SYSTEM.
- IN ADDITION TO TESTING AND ADJUSTING A NEW SPACE CONDITIONING SYSTEM, THE SYSTEM MUST BE BAUARCED IN ACCORDANCE WITH PROCEDURES DEFINED BY APPROVED MANONAU, STANADROS, AFTER COMPLETION OF TESTING, ADJUSTING, AND BAUARCING, A FINAL REPORT OF TESTING SIGNED BY THE TESTING AGENCY MUST BE COMPLETED.
- AN OPERATION AND MAINTENANCE MANUAL WITH OPERATING AND MAINTENANCE INSTRUCTIONS AND COPIES OF WARRANTIES FOR EACH SYSTEM IN THE BUILDING MUST BE PROVIDED TO THE BUILDING OWNER.
- ALL INSPECTION REPORTS AND CERTIFICATION THAT THE OPERATION AND MAINTENANCE MANUAL HAS BEEN PROVIDED FOR THE BUILDING OWNER MUST BE SUBMITTED TO THE BUILDING DIVISION PRIOR TO CERTIFICATE OF OCCUPANCY.

## COMMISSIONING

## ADHESIVES, SEALANTS AND CAULKS

ADHESIVES, SEALANTS AND CAULKS USED ON TI REQUIREMENTS OF THE FOLLOWING STANDARDS

ADDRESSES, JACEST DANIMARDS: ADDRESSES, JACEST DANIMARDS: SEAUTS: SEAUTE DEDNIG: PRANCES, SMESHVE FRMESS, SEAUTS: SEAUTERDINGS DANIE AND CALLSS SHALL COMPT WITH LOCAL OR REGIONAL AND FOUNDERS DANIES SHALL COMPT WITH LOCAL DISTINGT FRUE WHERE APPLICABLE, OR SCHOLDER 11 GA VOC LIDETS, IS STROMM IN NEEDS 5.01.42, SMESH VIEW DISTINGT PRANCESS SHALL AND SCHOLLES, SMESH VIEW DISTINGT PRANCESS SHALL AND SCHOLLESS SHALL AND SCHOLLESS SHALL AND SCHOLLESS SHALL AND SCHOLLESS AND SCHOLLESS AND SHALL AND SCHOLLESS AND SHALL AND SCHOLLESS AND SCHOLLESS

# ARROSOL ADHESIVES, AND SMALLER UNIT SIZES OF ADHESIVES, AND SEALANT OR CAULKING COMPOUNDS (NL UNITS OF PRODUCT, LESS PACAGAIGN, WHICH DO NOT WIGHT MORE THAN UNITS OF PRODUCT, LESS TATUMERO CONSIST OF MORE THAN USE OTHER REQUIREMENTS, INCLUDIOR PROHIBITIONS OF USE OF CERTAIN TOXIC COMPONIDS, OF CAUFORIA COMPONIDATION, THE ISSUE COMPONIDS, OF CAUFORIA CODE OF REQUIREMENTS, INCLUDIOR COMPONIDATION, THE ISSUE COMPONIDS, OF CAUFORIA CODE OF REQUIREMENTS.

SEALANTS	CURRENT VOC LIMIT
ARCHITECTURAL	250
MARINE DECK	760
NONMEMBRANE ROOF	300
ROADWAY	250
SINGLE-PLY ROOF MEMBRANE	450
OTHER	420
SEALANT PRIMERS	
ARCHITECTURAL NONPOROUS	250

NONPOROUS POROUS	250 775					
MODIFIED BITUMINOUS	500					
MARINE DECK	760					
OTHER	750					
*LESS WATER AND LESS EXEMPT COMPOUNDS IN GRAMS PER LITER						

## TABLE 5.504.4.2 SEALANT VOC LIMIT

## COMPOSITE WOOD PRODUCTS

HARDWOOD FWWOOD, PARTICLEBOARD AND MEDIUA DENEMY FBERBOARD COMPOSITE WOOD PRODUCTS USED ON THE INTEROR OR EXTERIOR OR THE BUILDING SHALL MEET THE REQUEREMENTS FOR FORMADEHYDE AS SPECIFIED IN MEDS JAR TOXOS. CONTROL MESAURE FOR COMPOSITE WOOD (17 COR 93 12 O ET 5EC), BY OR BEFORE THE DATES SPECIFIED IN THOSE SECTIONS, AS SHOWN IN TABLE 5.504.4.5

## DOCUMENTATION

- VERPEATION OF COMPLIANCE WITH THE SECTION SHALL BE PROVIDED AS REQUESTED BY THE ENFORCING ACENCY. DOCUMENTATION SHALL INCLUDE AT LEST DIG OF THE FOLLOWING. MODUCT CERTIFICATIONS AND SECTION DIS MODUCT CERTIFICATIONS AND SECTION SHALL INCLUDE MODUCT CERTIFICATIONS AND SECTIONS AND SECTIONS MODUCT SECTIONS AND SECTIONS AND SECTIONS MODUCT SECTIONS AND SECTIONS AND SECTIONS AND SECTIONS AND SECTIONS MODUCT SECTIONS AND SECTIONS MODUCT SECTIONS AND SEC
- EXTERIOR GRADE PRODUCTS MARKED AS MEETING THE PS-1 OR PS-2 STANDARDS OF THE ENGINEERED WOOD ASSOCIATION, THE AUSTRALINA ASINZS 2269 OR EUROPEAN 636 35 STANDA 5. OTHER METHODS ACCEPTABLE TO THE ENFORCING AGENCY

PRODUCT	CURRENT LIMIT
HARDWOOD PLYWOOD VENEER CORE	0.05
HARDWOOD PLYWOOD COMPOSITE CORE	0.05
PARTICLE BOARD	0.09
MEDIUM DENSITY FIBERBOARD	0.11
THIN MEDIUM DENSITY FIBERBOARD	0.13
MAXIMUM FORMALDEHYDE EMISSIONS IN PARTS PER MILLI	

## TABLE 5.504.4.5 FORMALDEHYDE LIMITS

### PAINTS AND COATINGS

## AEROSOL PAINTS AND COATINGS

RECOUL PANTS AND COATINGS SHALL WET THE PANIE LINTS FOR RCC IN SECTION 945220433 AND OTHER RECURRENTS, INCLUDING PROVINTICION SECTION 9452204201 AND 08(20) CAUROPHIL ACCOUNTS, INCLUDING PROVINTICIONS, THE SECTIONS 9452204201 AND 08(20) CAUROPHIL ACCOUNTS, INTER 17, COMMENCING WITH SECTION 94520, AND IN AREAS UNDER THE UBSOCIFICION OF THE BAY AREA CAURTY MANAGEMENT DETRICT ADDITIONALLY AUBSOCIFICION OF DETRICT ADDITIONALLY MAIN ACCEMENT DETRICT ADDITIONALLY COMPLY WITH THE PERCENT VOC BY WEIGHT OF PRODUCT LIMITS OF REGULATION 8 RULE 49.

### VERIFICATION

VERIFICATION OF COMPLIANCE WITH THIS SECTION SHALL BE PROVIDED AT THE REQUEST OF THE ENFORCING AGENCY. DOCUMENTATION MAY INCLUDE, BUT IS NOT JUMITED TO THE FOLLOWING: 1. MANUFACTURERS PRODUCT SPECIFICATION 2. FIELD VERIFICATION OF ON-SITE PRODUCT CONTAINERS

## FILTERS

IN MECHANICALLY VENTILATED BUILDINGS, PROVIDE REGULARLY OCCUPIED AREAS OF THE BUILDING WITH ARE RUTATION MEDIA FOR OUTSIDE AND VALUE MERFOL. OF THE BUILDING WITH ARE RUTATION MEDIA FOR OUTSIDE AND VALUE MERFOL. OF A MERY & FILTERS SHALL BE INSTALLED PROFIL OCCUPANCY, AND RECOMMENDATIONS FOR MAINTENANCE WITH RUTERS OF THE SAME VALUE SHALL BE NOLED IN THE OFERATION AND

TEMPORARY VENTILATION

THE FEBAUARENT HAVE SYSTEM SHALL ONLY BE USED DURING CONSTRUCTION IF IECESSARY TO COMDITION THE BULLIONS WITHIN THE INSTRUMENTS. IF IEVESSARY USED DURING CONSTRUCTION, USE RETURN ARE RUTERS WITH A MANUMAL FEFCIDION REPORTS IN VALUE MENTS OF 6, BASED ON ARENE 52, 21-390, 2 M AVERAGE FEROTION VALUE MEMORY THE FIRST ON COMDITION. THE ANALYSIS AND AND AND FEROTIN DIAL ON COMPANY.

COVERING OF DUCT OPENINGS AND

EQUIPMENT DURING CONSTRUCTION

AT THE TIME OF ROUGH HESTALATION AND DURING STORAGE ON THE CONSTRUCTION STEL UNIT, IPAL STATLE OF THE HEATING, CODUING AND VENTUATION EQUIPMENT, ALL DUCT AND OTHER RELATED AR DISTRIBUTION COMPORENT OFENNOS SHALL BE COVERED WITH TARE, FLASTIC, SHEET METAL OR OTHER METHODS ACCEPTABLE TO THE BROKENICA ACENCY TO SMOTIL AND ADDUCT OF DUST, MARE AND DEBROKENICA ACENCY TO SMOTIL.

PROTECTION OF MECHANICAL

## EXCEPTION

A MERV- I FILTER SHALL BE ALLOWED FOR RETURN AIR ONLY OR RETURN WITH PREFILTERED OUTSIDE AIR. IF THE FILTER IS OF A REUSABLE. WITH REFLICTED OUTSIDE AIR, IF THE FLICE, IS OF A REDAMLE, VONDESPOSABLE TYPE, AND THE FAN ENERGY USE OF THAT AIR DELIVERY SYSTEM IS 0.4 W/CPM OR LESS AT DESIGN AIRFLOW.

#### CHLOROFLUOROCARBONS (CFCS)

INSTALL HVAC, REFRIGERATION AND FIRE SUPPRESSION DO NOT CONTAIN CECS.

HALONS

## INSTALL HVAC, REFRIGERATION AND FIRE SUPPRESSION EQUIPMENT THAT POLLUTANT CONTROL

COATING CATEGORY	CURRENT VOC LIM		
FLAT COATINGS			
NONFLAT COATINGS	100		
NONFLAT HIGH GLOSS COATINGS	150		
SPECIALTY COATINGS			
ALUMINUM ROOF COATING5	400		
BASEMENT SPECIALTY COATINGS	400		
BITUMINOUS ROOF COATING	50		
BITUMINOUS ROOF PRIMERS	350		
BOND BREAKERS	350		
CONCRETE CURING COMPOUNDS	350		
CONCRETE / MASONRY SEALERS	100		
DRIVEWAY SEALERS	50		
DRY FOG COATING5	150		
FAUX FINISHING COATINGS	350		
FIRE RESISTIVE COATINGS	350		
FLOOR COATING5	100		
FORM-RELEASE COMPOUNDS	250		
GRAPHIC ARTS COATINGS (SIGN PAINTS)	500		
HIGH-TEMPERATURE COATINGS	420		
INDUSTRIAL MAINTENANCE COATINGS	250		
LOW SOLIDS COATINGS (1.)	120		
MAGNESITE CEMENT COATINGS	450		
MASTIC TEXTURE COATINGS	100		
METALLIC PIGMENTED COATINGS	500		
MULTICOLOR COATING5	250		
PRETREATMENT WASH PRIMERS	420		
PRIMERS, SEALERS AND UNDERCOATERS	100		
REACTIVE PENETRATING SEALERS	350		
RECYCLED COATINGS	250		
ROOF COATINGS	50		
RUST PREVENTATIVE COATINGS	250		
SHELLACS:			
CLEAR OPAQUE	730		
SPECIALTY PRIMERS, SEALERS AND	550		
UNDERCOATERS	100		
STAINS	250		
STONE CONSOLIDANTS	450		
SWIMMING POOL COATINGS	340		
TRAFFIC MARKING COATINGS	100		
TUB AND TILE REFINISH COATINGS	420		
WATERPROOFING MEMBRANES	250		
WOOD COATINGS	275		
WOOD PRESERVATIVES	350		
ZINC-RICH PRIMERS	340		

COMPOUNDS

## TABLE 5.504.4.3 VOC CONTENT LIMITS FOR ARCHITECTURAL COATINGS

## GENERAL NOTES

"ARCHITECT" AS USED IN THESE DOCUMENTS REFERS TO: CARULE COATSWORTH ARCHITECTS, INC. 2495 CAMPUS DRIVE 2ND FLOOR IRVINE, CALIFORNIA 92612 PHONE: (949) 833-1930

- THE 'GENERAL CONDITIONS OF THE CONTRACT FOR CONSTRUCTION A201 EDITION OF THE AMERICAN INSTITUTE OF ARCHITECTS' ARE HEREBY MADE A THESE CONTRACT DOCUMENTS TO THE SAME ENTENT AS IF BOUND HEREIN. DE A PART OF
- THE INTENT OF THESE DRAWINGS AND SPECIFICATIONS IS TO INCLUDE LABOR, MATERIALS AND SERVICES RECESSARY FOR COMPLETION OF ALL WORK, SHOWA, PRESCRIBED, OR REASONABLY IMPLIED BUT NOT JUNITED TO THAT EXPLICITLY IN THE CONTRACT DOCUMENTS.
- ALL WORK SHALL CONFORM TO ALL APPLICABLE BUILDING CODES, ORDINANCES AND REGULATIONS AS ADOPTED BY LOCAL AUTHORITIES. HAVING JURISDICTION.
- INSTALLALL MANUFACTURED (TENS), MATERIALS AND EQUIPMENT IN STRICT ACCORDANCE WITH THE MANUFACTURERS SECONDATIONS ON A COMPLIAN WITH ALL APPLICABLE CODES AND REQUIREMENTS OF ALL LOCAL, STATE AND FEDERAL ANTORPRISE.
- 6. DIMENSIONS ON DRAWINGS ARE SHOWN TO CENTER LINE OF COLUMNS AN FACE OF CONCRETE OR FACE OF STUD AT WALLS AND PARTITIONS UNLESS
- DO NOT SCALE DRAWINGS, DIMENSIONS GOVERN. LARGE SCALE DETAILS GOVERN OVER SMALL SCALE DETAILS.
- ALL WORK NOTED "N.I.C." OR "NOT IN CONTRACT" IS TO BE ACCOMPLISHED BY A CONTRACTOR OTHER THAN THE GENERAL CONTRACTOR AND IS NOT TO BE PART OF THE CONSTRUCTION AGREEMENT. THE GENERAL CONTRACTOR SHALL COORDINATE WITH "OTHER" CONTRACTORS AS REQUIRED.
- "ALIGN" AS USED IN THESE DOCUMENTS SHALL MEAN TO ACCURATELY LOCATE I FACES OF THE SAME PLANE. WHERE GYPSUM BOARD LAYERS DIFFER. STUDS A TO BE OFFSET TO PERMIT A CONTINUOUS SMOOTH FINISH LINE IN ALL CORRIDORS OR WHERE SUCH CONDITIONS OCCUR.
- 10. STRUCTURAL RECTINGLE. LECTROL. FLUBBING, ONL ADD LANDSAFE DRAWING SAF SHIPPLEMERIA TO THE ARCHITECTURAL REWINDS THE CONTRACTOR SHILL REVER ALL PLANS AND DRAWINGS. IN THE VERIT OF CONTRACTOR SHILL REVER ALL PLANS AND DRAWINGS. IN THE VERIT OF CONTRACTOR SHILL REVER ALL PLANS AND DRAWINGS. IN THE VERIT OF CONTRACTOR SHILL REVER ALL PLANS AND DRAWINGS. IN THE VERIT OF CONTRACTOR SHILL REVER ALL PLANS AND DRAWINGS. IN THE VERIT OF CONTRACTOR SHILL REVER ALL PLANS AND DRAWINGS. IN THE VERIT OF SHILL REVER ALL PLANS AND DRAWING AND THE CONTRACTOR SHILL REVER SHILL REVERT AND ADDRESS AND ADDRESS AND ADDRESS AND ADDRESS CONTRACTOR SHIP PRIVACE.
- DIMENSIONS, DETAILS, NOTES, AND/OR SYMBOLS THAT APPLY TO ONE UNIT, APPLY TO ALL UNITS IN LIKE SITUATIONS UNLESS OTHERWISE NOTED.
- ALL VERTICAL DIMENSIONS SHOWN TO FLOOR ARE TO THE CONCRETE SLAB OR CONCRETE FLOOR FILL, UNLESS OTHERWISE NOTED.
- DETAILS NOTED AS "TYPICAL" SHALL APPLY IN ALL LIKE CONDITIONS LINLESS SPECIFICALLY SHOWN OR NOTED OTHERWISE, WHERE NO SPECIFIC DETAIL IS SHOWN, THE FRAMING OR CONSTRUCTION SHALL BE DENTICAL OR SHALLAR TO THAT INDICATED FOR LIKE CASES OF CONSTRUCTION OF THE PROJECT.
- 14. WHENEVER AN ARTICLE, DEVICE, OR PIECE OF EQUIPMENT IS SHOWN, INDICATED, OR REFERRED TO ON THE DRAWINGS OR THESE NOTES IN THE SINGULAR NUMBER, SUCH REFERENCES APPLY TO AS MANY SUCH ARTICLES AS ARE REQUIRED TO COMPLETE THE INSTALLATION.
- 15. THE GENERAL CONTRACTOR AND ALL SUBCONTRACTORS SHALL VERIFY ALL DIMENSIONS AND CONDITIONS ON THE JOB SITE PRIOR TO BEGINNING CONSTRUCTION AND SHALL REPORT ANY DISCREPANCIES OR UNIDENTIFIED CONDITIONS TO THE ARCHITECT FOR RESOLUTION BEFORE ANY WORK IS DEGUN.
- 16. THE CONTRACTOR SHALL BE RESPONSIBLE FOR MEANS, METHODS, TECHNIQUES AND PROCEDURES EMPLOYED IN THE PERFORMANCE OF WORK IN, ON, OR ABOUT THE JOB SITE; THE CONTRACTOR SHALL COORDINATE AND VERIPY ALL WORK PERFORMED BY SUBCONTRACTORS.
- TREDURATE IS SUBJECT TO VIEW AND SUBJECT TO ALL CALL AND ALL AND ALL CALL AND ALL AND
- 18. THE STRUCTURE IS DESIGNED AS A STABLE UNIT AFTER ALL COMPONENTS ARE IN PLACE. THE CONTRACTOR SHALL PROVIDE ALL SHORING AND BRACING NECESSARY TO ENSURE THE STABILITY OF ANY AND ALL PARTS OF THE BUILDING DURING CONSTRUCTION.
- UNLESS SPECIFICALLY SHOWN OR NOTED ON THE DRAWINGS, NO STRUCTL MEMBER SHALL BE CUT NOTCHED, BORED OR OTHERWISE MODIFIED WITH PERMISSION OF THE ARCHITECT.
- 20. WHETHER OR NOT DETAILED ON THE DRAWINGS, THE SUB-CONTRACTORS SHALL PROVIDE AND INSTALL ALL STIFFENES, BRACING, BACK-UP FLATES AND SUPPORTING BRACIETS REQUIRED FOR THE INSTALLATION OF ALL WALL MOUNTED OR SUSFEMBED MECHANICAL, ELECTRICAL OR MISCELLANEOUS EQUIPMENT, INCLUIDING FINANCIDA LECTRICAL, OR MISCELLANEOUS EQUIPMENT, INCLUIDING FINANCIDA USAGED STOR TELEFONGE AND ELECTRICAL EQUIPMENT
- 21. THE CONTRACTOR SHALL BE RESPONSIBLE FOR OBTAINING ALL REQUIRED BUILD PERMITS. THE CONTRACTOR SHALL ALSO BE RESPONSIBLE FOR APPROVAL AND PERMITS FOR ALL DEGIONAULD SYSTEMS, AND THAT THE SYSTEMS MEET ALL APPLICABLE CODE REQUIREMENTS
- 22. NEITHER THE ARCHITECTS REVIEW NOR APPROVAL OF SHOP DRAWINGS SHAL RELEVE THE SUB-CONTRACTOR FROM RESPONSIBILITY FOR DEVIATIONS FINO DRAWINGS OF SPECIFICATIONS NUESS HE HAS CALLED THE ARCHITECTS AT IN WRITING TO SUCH DEVIATION AT THE TIME OF SUBMISSION NOR SHALL RELEVE IN OF RESPONSIBILITY FOR DRIROR CAN SY CORT IN THE SHOP DRA NUMERICAL STREAM OF SUBMISSION AND STREAM OF SUBMISSION NOR SHALL CTS ATTENTION
- 23. INSTALATION OF GLASS SHALL CONFORM TO FEDERAL SPECIFICATION 16.CFR. 1202 MID ALL LICAL CODES AND ORDINANCES. GLASS SUBJECT TO HUMAN IMPACT SHALL COMPANY WITH LIS. CONSUMER FROCURED SAFETY STAMARDS. CRETIFICATE SHALL ACCOMPANY PRODUCT STATING DATE AND PLACE OF MANUFACTURE.
- 24. SUB-CONTRACTORS TO INVESTIGATE LOCATIONS OF EXPERISION SUFFICE. SUB-TO THE CIVIL DRAIMINGS FOR LOCATIONS OF EXISTING UTILITY LINES. LOCATIONS OF ALL UTILITES SHOWN ARE APPROXIMATE AND THE CONTRACTOR SHALL DERECES EXTERNE CAUTION IN DECANTION AND TRENCHING TO AVOID INTERCEPTING EXISTING FINING OR CONDUCTS.
- 25. SUB-CONTRACTORS SHALL BE RESPONSIBLE FOR ALL CUTTING, FITTING AND PATCHING AS REQUIRED TO COMPLETE THE WORK. ALL PATCHED SURFACES SHALL MATCH ADJACENT EXISTING AND/OR NEWLY CONSTRUCTED SURFACES.
- 26. DOOR LOCATIONS NOT ESTABLISHED BY DIMENSION SHALL BE CENTERED IN WALL OR 4\* FROM FACE OF TO FINISH JAMB WHERE FEASIBLE, UNLESS OTHERWISE
- 27. CONTRACTOR SHALL BE RESPONSIBLE FOR THE GENERAL CLEANING OF A JOB AFTER ITS COMPLETION. CLEANING SHALL INCLIDE INTERIOR OF THE BUILDING AND PATH OF TRAVIL, TO THE JOB STIK AND SHALL INCLIDE THE PARKING LOT, ELEVATORS, STAIRS, LOBBLES AND CORRIDORS.

## GENERAL NOTES

26. CONTRACTOR SHALL BE RESPONSIBLE AND SHALL PROVIDE ALL BLOCKING AND BRACING IN WALLS AND CEILING FOR ALL MILLWORK, SHELVING, WALL WEIGHT, ETC AS REQUIRED FOR SUPPORT.

### STAIRS, EXITS AND OCCUPANT LOADS REQUIRED EXIT DOORS:

- SHALL BE OPEN ABLE FROM INSIDE WITHOUT USE OF KEY OR ANY SPECIAL KNOWLEDGE OR EFFORT, (THIS NEED NOT APPLY TO EXTENDER EXT DOORS IN GROUP B OCCUPHNCY WITH AN DALACENT SIGN STATING THIS DOOR TO REMAIN UNLOCECE DIVINIO BUSINESS HOURS' AND WITH A LOCKING DEVISE READLY DISTINGUISHABLE AS LOCKED.)
- ALL EXIT DOORS MUST OPEN ON A LANDING NOT MORE THAN 1/2" BELOW THRESHOLD PER BUILDING CODE. CHAINGE IN LEVEL BETWEEN 1/4" AND 1/ SHALL BE BEVELED WITH A SLOPE NO GREATER THAN 1/2. CHAINGE IN LEV GREATER THAN 1/2" SHALL BE ACCOMPLISHED BY MENAS OF A RAMP. I.B.

Carlile

Coatsworth

2495 Campus L Second F

Irvine, California 92612 Phone: 949.833.1930 Fax: 949.833.1140 www.ccarchitects.com

Architects, Inc.

3

Urbane Cafe

TENANT IMPROVEMENT

URBANE CAFE

ENOS RANCHOS - BRADLEY WEST

655 EAST BETTERAVIA RD. SANTA MARIA, CA 93454

CLIENT/ LL/ CITY SUBMITTAL 03 MAY, 2017

G-002.DWG

AS NOTED

CALIFORNIA GREEN BUILDING

CODE & GENERAL NOTES

**G-002** 

ING SYSTEM . ILS NATIONAL CAO

CP

HEALTH DEPT. RESUE

BUILDING DEPT. RESUBM

REVISIONS

PROJECT

DRAWN BY:

SHEET TITLE

FILE:

DATE:

SCALE:

- I.C. ALL EXIT DOORS SHALL SWING IN THE DIRECTION OF EXIT TRAVEL WHEN SERVING MORE THAN 50 OCCUPANTS PER BUILDING CODE.
- PANIC HARDWARE SHALL BE PROVIDED ON EXIT DOORS SERVING ROOM CORRIDORS, OR STAIRWAYS HANDLING AN OCCUPANT LOAD OF 50 OR MORE PERSONS.
- I.E. DOORS SHALL BE NOT LESS THAN 3'-0' W x 6'-8' H WITH NO SINGLE LEAF EXCEEDING 4'-0' IN WIDTH.
- DOORS AND DOORWAYS: THE FLOOR ADJACENT TO DOORWAY SHALL BE LEVEL FOR A DISTANCE OF FIVE FEET FROM THE DOOR IN THE DIRECTION OF DOOR SWING AND SHALL EXTEND NOT LESS THAN ONE FOOT BEYOND EACH SIDE OF THE DOOR.
- ILLUMINATED EXIT SIGNS SHALL BE PROVIDED WHERE REQUIRED BY, AND IN ACCORDANCE WITH, APPLICABLE LAWS.
- ALL REQUIRED EXITS AND BLIND CORRIDOR TURNS SHALL HAVE EXIT SIGNS. EXIT SIGNS SHALL HAVE LETTERS WITH A PRINCIPAL STROKE NOT LESS THAN 34" WIDE AND & HIGH. 5. CORRIDORS SHALL BE FIRE-RESISTANCE RATED IN ACCORDANCE WITH TABLE

MECHANICAL, PLUMBING AND ELECTRICAL PROVIDE ACCESS DOORS OR PANELS IN CEILING AND WALL CONSTRUCTION AS REQUIRED BY INSTALLATION OF MECHANICAL, FIRE SPRINKLER, PLUMBING AND ELECTRICAL WORK IN ADDITION TO THOSE SHOWN ON THE DRAWINGS.

SUB-CONTRACTORS SHALL VERIFY SIZE AND LOCATIONS OF ALL MECHANICAL EQUIPMENT PLATFORMS AND BASES AS WELL AS POWER, WATER AND/OR DRMIN INSTALLATIONS WITH EQUIPMENT ANALINACTURES PROR TO PROCEEDING WITH WORK, CHANGES TO ACCOMMODATE FIELD CONDITIONS OR CONTRACTORS SUBSTITUTIONS SHALL BE MADE WITHOUT ADDITIONAL CHARGE TO OWNER.

MECHANICAL AND ELECTRICAL CONTRACTORS SHALL VERIFY SIZE, SHAPE AND LOCATIONS OF HOUSEKEEPING PADS FOR THEIR EQUIPMENT. ANY FIELD CHANGES SHALL BE MADE WITHOUT ADDITIONAL CHARGE TO THE OWNER.

AIR LEAKAGE AT EXTERIOR DOORS SHALL BE UMITED BY THE FOLLOWING:

DOOPS REQUIRING VERTICAL TRACK CLIDES SHALL LISE & CONTIN

ALL DOORS SHALL BE PROVIDED WITH A SEAL, ASTRAGAL OR BAFFLE AT THE

DOOR JAMBS MOUNTED ON EITHER THE INSIDE OR OUTSIDE OF AN EXTERIOR WALL SHALL LAP THE ADJACENT WALL CONSTRUCTION A MINIMUM OF ONE INCH.

MOUNTING ANGLE, SEALED IN ACCORDANCE WITH ITEM 1.G LISTED BELOW DOORS MOUNTED BETWEEN THE JAMBS SHALL HAVE A CONTINUOUS SEAL OR BAFFLE AT EACH JAMB.

MEETING RAILS OF SECTIONAL DOORS AND MEETING STILES OR RAILS OF BI-PARTING DOOR SHALL BE PROVIDED WITH A SEAL, ASTRAGAL OR BAFFLE

SWINGING AND REVOLVING DOORS SHALL BE WEATHER STRIPPED AT THE HEAD, SILL AND JAMB.

I.G. OPEN EXTERIOR JOINTS APOUND WINDOW AND DOOR FRAMES, BETWEEN WALL AND FOUNDATIONS, PENETRATIONS OF UTULTY SERVICES THROUGH WALL, FLOORS AND ALL OTHER OPENINGS IN THE EXTERIOR ENVELOPES SHALL BE SEALED, CAULKED, GASKETED OR WEATHER STRIPPED TO LIMIT AIR.

OPEN EXTERIOR JOINTS AROUND WINDOW AND DOOR FRAMES, JOINTS BETWEEN WALLS AND FOUNDATIONS, JOINTS BETWEEN WALL AND ROOF, JOINTS BETWEEN WALL PARELS, JOINTS AT FEWERTATIONS OF UTILITIES THROUGH THE EVICLOPE SHALL BE SEALED, CAULKED OR WEATHER-STRIPPED TO LIMIT AIR LEAKAGE.

2. ALL RATED DOORS SHALL HAVE GASKETS AT HEAD AND JAMB. 3. ALL FIXED WINDOWS SHALL BE SEALED TO LIMIT AIR INFILTRATION.

ENERGY NOTES

1.E.

### SIGNS & IDENTIFICATION

E: FORNIA'S STANDARDS FOR SKINAGE ARE MORE STRINGENT AND ARE HICANTLY LARGER AND WIDER THAN FEDERAL LAW, AMERICANS WITH BILITIES ACT (ADA) SECTION 703.

- ALL BUILDING ENTRANCES THAT ARE ACCESSIBLE TO AND USABLE BY PERSONS WITH DEABULITES AND AT EVERY MAJOR JUNCTION ALONG OR LEADING TO AN ACCESSIBLE RUTLE OF TRAVEL SALL BE IDENTIFIED WITH A SIGN DEVANING THE ACCESSIBLE RUTLE OF TRAVEL SALL BE IDENTIFIED WITH A SIGN DEVANING HEAD AND A SIGNAL AND A SIGNAL BUILDING AND A SIGNAL AND SIGNAL ARE RUTLED TO BE VISIBLE TO FERSIONS ALONG APPROACHING FEDERTIRM WINS.
- WHEN SIGHS IDENTIFY FERMANENT FOOMS AND SPACES OF A BUILDING OR SIT RAGED LETTERS SHALL BE FOOVED AND SHALL BE IN COMPONANCE WITH SECTION 115, 702, SINGE SHALL BE RIGHLED ON THE WALL ADMCENT TO THE REAL OF THE RIGHLED AND SHALL BE FOODS SINGE SHALL BE FLOCED MARKET ADMORTH WALL PREFEASUR ON THE RIGHT. MOUNTING SHALL BE LOCATED IN ANI. 10% X 10% NMMAM CLEAR FLOOR SPACE CONTRHE LOCATED IN ANI. 10% X 10% NMMAM CLEAR FLOOR SPACE CONTRHE INCLUE CHARGETERS.
- 3. MEANS OF EGRESS, IDENTIFICATION, GRAPHICS ILLUMINATION, POWER SOURCE AND TACTILE EXIT SIGNAGE SHALL COMPLY WITH SECTIONS 1011.1 THROUGH 1011.7
- 4. WHEN RAISED CHARACTERS OR SYMBOLS ARE USED, THEY SHALL CONFORM TO THE FOLLOWING Α.
  - в.
  - G: LETTERS AND NUMBERS ON SIGNS SHALL BE RAISED 1/3.2° MINIMUM AND SHALL BE SANG SERV UPPERCASE BALLE: RAISED CHARGETERS OR STANLED SHALL BE A MINIMUM OF SIRV THOM HOM, OF SON BODS SHALL BE A MINIMUM OF SIRV THOM HOM, OF GROTOGRAWS) SHALL BE ACCOMPANED С. BY THE VERBAL DESCRIPTION PLACED DIRECTLY BELOW THE PICTOGRAM. THE OUTSIDE DIMENSION OF THE PICTOGRAM FIELD SHALL BE A MINIMUM OF G" IN HEIGHT.
- PROPORTIONS. CHARACTERS ON SIGNS SHALL BE SELECTED FROM FONTS THE WIDTH OF THE UPPERCASE LETTER 'O' IS GO PERCENT MINIMUM AND I PERCENT MAXIMUM OF THE HEIGHT OF THE UPPERCASE LETTER "T"
- G. FINISH AND CONTRAST. CHARACTERS, SYMBOLS AND THEIR BACKGROUND SHALL HAVE A NON-GUARE FINISH. CHARACTERS AND SYMBOLS SHALL CONTRAST WITH THEIR BACKGROUND, ETHER LIGHT CHARACTERS ON A DARK BACKGROUND OR DARK CHARACTERS ON A LIGHT BACKGROUND.
- 7. CHARACTER HEIGHT, CHARACTERS AND NUMBERS ON SIGNS SHALL BE SIZE ACCORDING TO THE VIEWING DISTANCE FROM WHICH THEY AREA TO BE ZEAD. ACCORDING TO THE VIEWING DISTANCE FROM WHICH THEY AREA TO BE READ. THE MINIMUM HEIGHT IS MEASURED USING AN UPPER CASE TY. CHARACTERS SHALL BU UPPER CASE. FOR SIGNS SUPERDED OR REOLECTION ADVOIT THE FINISH FLOOR THE MINIMUM CHARACTER HEIGHT SHALL BE IN COMPLIANCE WITH TABLE 19, 703, 55
- 1 IB-703.5.5. BRAILE: CONTRACTED GRADE 2 BRAILE SHALL BE USED WHEREVER BRAILE IS BRAILE: CONTRACTED GRADE 2 BRAILE SHALL BE 1/10° ON CENTER IN THE SAME CELL AND 3/10° ON CENTER IN ADJACENT CELLS. DOTS SHALL BE RAVED A MINIMUM OF 1/40° ABOVE THE BACKGROUND. STAIRWAYS

## 1. STAIRWAYS SHALL HAVE HANDRAILS ON EACH SIDE.

- 2. TOP OF HANDRAILS SHALL BE 34 TO 38 INCHES ABOVE THE NOSING OF THE TREADS.
- HANDRAILS SHALL EXTEND A MINIMUM OF 12 INCHES BEYOND THE TOP NOSING AND 12 INCHES, PLUS THE TREAD WIDTH, BEYOND THE BOTTOM NOSING.
- 4. HANDRAILS PROJECTING FROM A WALL SHALL HAVE A SPACE OF 11/2 INCHES MINIMUM BETWEEN THE WALL AND THE HANDRAIL.
- THE HANDGRIP PORTION OF HANDRAILS SHALL BE NOT LESS THAN 1 1/4 INCHES NOR MORE THAN 2 INCHES IN CROSS-SECTIONAL NOMINAL DIMENSION OR THE SHAPE SHALL PROVIDE AN EQUIVALENT GRIPPING SURFACE. THE HANDGRIP SHARE SHALL PROVIDE AN EQUIVALENT GRIPPING SURFACE. THE HANDGRP PORTION OF HANDRAILS SHALL HAVE A SMOOTH SURFACE WITH NO SHARP CORRERS, GRIPPING SURFACES (TOP OR SIDES) SHALL BE LINITTERRUPTED BY NEWEL POSTS, OTHER CONSTRUCTION ELEMENTS OR OBSTRUCTIONS, ANY WALL OR OTHER SURFACE ADJACENT TO THE HANDRAIL SHALL BE FREE OF SHARP OR ABRAVIE ELEMENTS, EDGES SHALL HAVE A MINIMUM ROLLOS OF 1/87.
- C. TACTUE STARLENGL BOBILINGCHION SUGS THAT COMPRY WITH 1 IB-700 SHML BELOCKTE STARCH ROOK IERU LANDICH AN LENCOSED STARLAWS IN BUILDINGS TWO OK MORE STORES IN HIGHT TO DRHITY THE FLOOR LIVEL. AT DY DISCHARGE LEVEL, THE SIGNIFING FLOOR LIVEL AT LOCATED TO THE LETT OF THE IDENIFIYING FLOOR LIVEL. ITS LOCATED TO THE LETT OF THE IDENIFIYING FLOOR LIVEL. ITS OF THE STARLE BETHE SHALL WE AS THE HEIGHT OF THE RADED DAVAETERS.
- THE UPPER APPROACH AND THE LOWER TREAD OF EACH STAIR SHALL BE MARKED BY A STRIP OF CLEARLY CONTRASTING COLOR 2-4 INCHES WIDE FRACED PARALLEL TO AND NOT MORE THAN I INCH FROM THE NOEO OF THE STEP OR LANDING TO ALERT THE VISUALLY MEARED. THE STRIP SHALL BE OF MATERIAL THAT IS AT LEAST AS JUPY RESISTANT AS THE OTHER TREAD OF THE STRIP.
- 8. WHERE STARWAYS OCCURS OF A BULDRUG. THE UPPER APPROACH AND ALL TREADS SHALL BE MARKED BY A STIRP OF CLEARLY CONTROLTING PROVIDE NOSCO FITE STORE OF LANDING TO ALET THE VISUALLY MAR FROM THE NOSCO FITE STORE OF LANDING TO ALET THE VISUALLY MAR THE STRP SHALL BE OF A MATERIAL THAT IS AT LEAST AS UPP RESISTING OTHER TREADS OF THE STARE. A HAVITED STRE SHALL BE ACCEPTABLE. ANT AS THE
- ALL TREAD SURFACES SHALL BE SUP RESISTANT. WEATHER-EXPOSED STARS AND THEIR APPROACHES SHALL BE DESIGNED SO THAT WATER WILL NOT ACCUMULATE ON THE WAKING SURFACES. TREADS SHALL HAVE A SMOOTH ACLUMED OR CHAMFERED EMOSED EDGES, AND NO ARRUPT EDGES AT THE NOSING (LOWER FRONT EDGE).
- NOSING SHALL NOT PROJECT MORE THAN 1 1/4 INCH PAST THE FACE OF THE RISER BELOW.

ON ANY GIVEN FLIGHT OF STARES, ALL STEPS SHALL HAVE UNIFORM RISER HEIGHT AND UNIFORM TREAD WOTHS CONSISTENT WITH SECTION II IB-SOL 2. STARE TREADS SHALL BE NO LISS THAN I I INCHS DERY, MASARED FLOR RISER TO ROBER, RISERS SHALL BE VERTICAL OR SUCCESS TROL THE UNDERSIDE OF THE NOSING SHALL HAVE AN ANGLE NOT NOBE THAN 3D DEGREES FROM THE VERTICAL.

## NOTIFICATION APPLIANCES FOR THE HEARING IMPAIRED

- IF EMERGENCY WARNING SYSTEMS ARE REQUIRED, THEY SHALL ACTIVATE A MEANS OF WARNING THE HEARING IMPAIRED.
- APPROVED NOTIFICATION APPLIANCES FOR THE HEARING IMPAIRED SHALL BE INSTALLED IN ACCORDANCE WITH THE PROVISIONS OF NFPA 72 IN THE
- A: RESTROOMS B: CORRIDORS C: MULTIPURPOSE ROOMS D: OCCUPATIONAL SHOPS E: OCCUPED ROOMS WHERE AMBIENT NOISE IMPARIS HERMING OF THE FIRE ALARM F: LOBBLES G: MEETING ROOMS H: CLASSROOMS I: MY OTHER AREA FOR COMMON USE
- STROBE SIGNALING DEVICES REQUIRED FOR THE HEARING IMPAIRED SHALL BE
- ACCESSIBILITY NOTES

## CONTROLS & OPERATING MECHANISMS

- CONTROLS AND OPERATING MECHANISMS REQUIRED TO BE ACCOMPLY WITH THE REQUIREMENTS OF SECTION (118-205. COMPLY WITH THE REQUIREMENTS OF SECTION (18-205) B CLEAR RLOOK SPACE COMPLYING WITH SECTION (18-205) THAT ALLOWS A F OR PARALLEL APPROACH BY A FERSON USING A WHEELTAME SHALL BE PROV CONTROLS, DISPUSERS, RECEITALES, AND OTHER OFENALE EQUIPMENT.
- Currin Rudz, Judiniceles, Rectar IACLES, MD OTHER OPERABLE EXJIMANT. The HIGHEST OPERABLE PART OR ALL CONTROLS. DEPENSESS, RECENTLES, MD OTHER OPERABLE EXJILINARUT SHALL BE PLACED WITHIN 48' OF THE ROOK BUT NOT LOWR: THAN 15': ELECTRICAL AND COMMUNICATION SYSTEM RECEPTACIALES ON WALLS SHALL BE MCUNTED NO LESS THAN 15' ABOVE THE FLOOR MEASURED FROM THE DOTTION OF BOX CR HOUSING.
- CONTROLS AND OPERATING MECHANISMS SHALL BE OPERABLE WITH ONE HAND ANI SHALL OF ERALING MECHANISMS SHALL BE OPERABLE WITH ONE HAND AN. SHALL NOT REQUIRE TIGHT GRASPING, PINCHING, OR TWISTING OF THE WRIST. THE FORCE REQUIRED TO ACTIVATE CONTROLS SHALL BE NO GREATER THAN 5 POUNDS OF FORCE.
- VENDING MACHINES SHALL BE INSTALLED IN COMPLIANCE WITH SECTION 1126B
- FAUCET CONTROLS AND OPERATING MECHANISMS SHALL BE OPERABLE WITH ONE HAND AND SHALL NOT REQUIRE TIGHT GRASPING, PINCHING, OR TWISTING OF THE WRIST. THE FORCE REQUIRED TO ACTIVATE CONTROLS SHALL BE NO GREATER THAN 5 LB. LEVER-OPERATED, RUSH-TYPE, AND ELECTRONICALLY CONTROLLED TRAN 5 LB. LEVENOT EARLEY, FUSTIFITE, AND ELECTRONIC COSING VI MECHANISMS ARE EXAMPLES OF ACCEPTABLE DESIGNS. SELF-LOSING VI ARE ALLOWED IF THE FAUCET REMAINS OPEN FOR AT LEAST TO SECONDS

## SITE DEVELOPMENT

- GRADE AND DEVELOP SITE SO THAT ALL PRIMARY BUILDING. ENTRANCES ARE ACCESSIBLE TO PERSONS WITH DISABILITIES FROM BOTH THE PUBLIC WAY AND FROM ACCESSIBLE PARKING. SPACE(5) PROVIDED.
- STE DEVELOPMENT AND GRADING SHALL BE DESIGNED TO PROVIDE ACCESS TO ALL ENTRANCES AND DETERIOR GROUND FLOOR EVITS, AND ACCESS TO NORMAL PATHS OF TRAVEL, MD WHERE NECESSARY TO PROVIDE ACCESS, SHALL INCORPORATE PEDESTRIAN RAMPS, CUEB RAMPS, ETC.
- WHEN MORE THAN ONE BUILDING OR FACILITY IS LOCATED ON A SITE, ACCESSIBLE ROUTES OF TRAVEL SHALL BE PROVIDED BETWEEN BUILDINGS AND ACCESSIBLE SITE FACILITIES.
  - THE ACCESSIBLE ROUTE OF TRAVEL SHALL BE THE MOST PRACTICAL DIRECT FACILITIES AND THE ACCESSIBLE BUILDING ENTRANCES, ACCESSIBLE SITE FACILITIES AND THE ACCESSIBLE ENTRANCE TO THE SITE.

## PARKING

- REFER TO THE SITE PLAN FOR ACCESSIBLE PARKING LAYOUT.
- CAR AND VAN PARKING SPACES SHALL BE 2.1.G INCHES LONG MINIMUM. CAR PARKING SPACES SHALL BE 108 INCHES WIDE MINIMUM AND VAN PARKING SPAC SHALL BE 144 INCHES WIDE MINIMUM, SHALL BE MARKED TO DEFINE THE WIDTH, SHALL HAVE AN ADJACENT ACCESS ASILE COMPLYING WITH SECTION 1 IB-502.3
- EXCEPTION: VAN PARKING SPACES SHALL BE PERMITTED TO BE I OB INCHES WIDE MINIMUM WHERE THE ACCESS AISLE IS 96 INCHES WIDE MINIMUM.

- WIDE NIMINUM WHERE THE ACCESS AREE ID 96 INCHES WIDE MININUM. ACCESS AREES DRAWL ADDION IN ACCESS AREE. ACCESS AREES DRAWLING ARE REPRENTED TO SHARE A COMMON ACCESS AREE. ACCESS AREES DRAWLING ARE SHALE ACCESS AREES DRAWLING AREAS AND A AND AISLES LOCATED ON THE PASSENGER SIDE OF THE PARKING SPACES
- SURFACE SLOPES OF ACCESSIBLE PARKING SPACES AND ACCESS AISLES SHALL NOT EXCEED 1:48
- ALL ENTRANCES TO AND VERTICAL CLEARANCES WITHIN PARKING STRUCTURES SHALL HAVE A MINIMUM CLEARANCE OF 8-2" WHERE REQUIRED FOR ACCESSIBILITY TO ACCESSIBLE PARKING SPACES.
- ACCESSIBLE SPACES SHALL BE SO LOCATED THAT PERSONS WITH DISABILITIES ARE NOT COMPELLED TO WHEEL OR WALK BEHIND PARKED CARS OTHER THAN THEIR OWN. PEDESTRIAN WAYS WHICH ARE ACCESSIBLE TO PERSONS WITH DISABILITIES SHALL BE PROVIDED FROM EACH DISABLED PARKING SPACE TO RELATED FACILITIES, INCLUDING CURB CUT COR RAMPS AS NEEDED.
- 8. IN EACH PARKING AREA, A BUMPER OR CURB SHALL BE PROVIDED AND LOCATED TO PREVENT ENCROACHMENT OF CARS OVER THE REQUIRED WIDTH OF WALKWAYS
- 9. ACCESSIBLE PARKING SPACES SHALL BE LOCATED AS NEAR AS PRACTICAL
- WHEN ACCESSIBLE PARKING IS LOCATED SUCH THAT THE PATH OF TRAVEL FROM THE ACCESSIBLE PARKING SPACE(S) TO A BUILDING OR. FACILITY REQUIRES A PRESON WITH DEADLITY TO TRAVEL NITO THE "PUBLIC WAY, THE BITHE PATH OF TRAVEL, INCLUDING THAT FORTION IN THE PUBLIC WAY, SHALL CONFORM TO ALL APPLICABLE CODE REQUIREMENT.
- EACH PARKING SPACE RESERVED FOR PERSONS WITH DISABILITIES SHALL BE DENTIFIED BY A REFLECTORED SIGN FERMINIENT VTOSTED IMMEDIATELY ADJACENT TO AND VIOLE FROM LEGY TATUL OR SPACE. CONSISTING OF A BACKGRTONIC DIN VIOLE FROM LEGY TATUL OR SPACE. CONSISTING OF A BACKGRTONIC DIN SIGN WITH ADDA STATUL OR SPACE. THE VIOLE TO SPACE TRISHED GADE. SIGNS WIT ALSO DE CONTREDO ON THE WARKING SPACE TRISHED GADE. SIGNS WIT ALSO DE CONTREDO ON THE WARKING SPACE TRISHED GADE. SIGNS WIT ALSO DE CONTREDO ON THE WARKING SPACE TRISHED GADE. SIGNS WIT ALSO DE CONTREDO ON THE WARKING SPACE TRISHED GADE. SIGNS WIT ALSO DE CONTREDO ON THE WARKING SPACE TRISHED GADE. SIGNS WIT ALSO DE CONTREDO ON THE WARKING SPACE TRISHED GADE. SIGNS WIT ALSO DE CONTREDO ON THE WARKING SPACE TRISHED GADE. SIGNS WIT ALSO DE CONTREDO ON THE WARKING SPACE TRISHED GADE. SIGNS WIT ALSO DE CONTREDO ON THE WARKING SPACE TRISHED GADE. SIGNS WIT ALSO DE CONTREDO ON THE WARKING SPACE TRISHED GADE. SIGNS WITH ALSO DE CONTREDO ON THE WARKING SPACE TRISHED GADE. SIGNS WITH ALSO DE CONTREDO ON THE WARKING SPACE TRISHED GADE. SIGNS WITH ALSO DE CONTREDO ON THE WARKING SPACE TRISHED GADE. SIGNS WITH ALSO DE CONTREDO ON THE WARKING SPACE TRISHED GADE. SIGNS WITH ALSO DE CONTREDO ON THE WARKING SPACE TRISHED GADE. SIGNS WITH ALSO DE CONTREDO ON THE WARKING SPACE TRISHED GADE. SIGNS WITH ALSO DE CONTREDO ON THE WARKING SPACE TRISHED GADE. SIGNS WITH ALSO DE CONTREDO ON THE WARKING SPACE TRISHED GADE. SIGNS WITH ALSO DE CONTREDO ON THE WARKING SPACE TRISHED GADE. SIGNS WITH ALSO DE CONTREDO ON THE WARKING SPACE TRISHED GADE. SIGNS WITH ALSO DE CONTREDO ON THE WARKING SPACE TRISHED GADE. SIGNS WITH ALSO DE CONTREDO ON THE WARKING SPACE TRISHED GADE. SIGNS WITH ALSO DE CONTREDO ON THE WARKING SPACE TRISHED GADE. SIGNS WITH ALSO DE CONTREDO ON THE WARKING SPACE TRISHED GADE SIGNS WITH ALSO DE CONTREDO ON THE WARKING SPACE TRISHED GADE SIGNS WITH ALSO DE CONTREDO ON THE WARKING DE SIGNS WITH ALSO DE CONTREDO ON THE WARKING DE SIGNS WITH ALSO DE SIGNS WITH ALSO DE SIGNS WITH ALS
- AN ADDITIONAL SIGN SHALL ALSO BE POSTED, IN A CONSPICUOUS PLACE, AT EACH ENTRANCE TO OFF-STREET PARKING FACILITIES, OR, IMMEDIATELY ADJACENT TO AND VISIBLE FROM EACH STALL ON SPACE. THE SIGN SHALL NOT BE LESS THAN 17' x 22' IN SIZE WITH LETTERING NOT LESS THAN I'' IN HEIGHT, WHICH CLEARLY AND CONSPICUOUSY STATES THE FOLLOWING IN HEIGHT,
- BLANK SPACES ARE TO BE FILLED IN WITH APPROPRIATE INFORMATION AS A PERMANENT PART OF THE SIGN.

## WALKS AND SIDEWALKS

- WALKS AND SIDEWALKS SUBJECT TO THESE REGULATIONS SHALL HAVE A CONTINUOUS COMMON SURFACE, NOT INTERRUPTED BY STEPS OR BY ABRUPT CHANGES IN LEVEL EXCEEDING 1/2 INCH, AND SHALL BE A MINIML OF 48-INCHES IN WIDTH.
- 2. SURFACES WITH A SLOPE OF LESS THAN & PERCENT GRADIENT SHALL BE AT LEAST AS SUP-RESISTANT AS THAT DESCRIBED AS A MEDIUM. SALTED FINISH SURFACES WITH A SLOPE OF & PERCENT GRADIENT OR GREATER. SHALL BE SUP-RESISTANT
- WHEN THE SLOPE IN THE DIRECTION OF TRAVEL OF ANY WALK. EXCEEDS I UNIT VERTICAL TO 20 UNITS HORIZONTAL (5% GRADIENT), IT SHALL COMPLY WITH THE PROVISIONS FOR PEDESTRIAN RAMPS.
- 5. SURFACE CROSS SLOPES SHALL NOT EXCEED 1/4-INCH PER FOOT

- WALKS, SIDEWALKS AND PEDESTRIAN WAYS SHALL BE FREE OF GRATINGS WHENEVER POSSIBLE. FOR GRATINGS LOCATED IN THE SURFACE OF ANY OF THESE AREAS, GRID OPENINGS IN GRATINGS SHALL BE LIMITED TO 1/2-INCH IN THE DIRECTION OF TRAFFIC FLOW.
- THE DIRECTION OF TRAFFIC FLW. BARUPT CHANGES IN LEVEL ADORG ANY ACCESSIBLE ROUTE SHALL NOT EXCEED 1/2-work, where CHANGES IN LEVEL DO OCCUR, THEY SHALL BE BEVELED WITH H SLOPE NO GREATER THAN I UNIT VERTICAL TO 2 UNITS HORIZONTAL (50% GRAE BUCEPT THAT LEVEL CHANGES NOT EXCEEDING 1/4-INCH MAY BE VERTICAL. WHEN CHANGES IN LEVELS GREATER THAN 1/2-INCH ARE NECESSARY, THEY SHALL COMPLY WITH THE REQUIREMENTS FOR CURB RAMPS.
- WALKS SHALL BE PROVIDED WITH A LEVEL AREA NOT LESS THAN GO-INCHES × GO-INCHES AT A DOOR OR GATE THAT SWINGS TOWARD THE WALK, AND NOT LESS THAN 48-INCHES WIDE BY 44-INCHES DEEP AT A DOOR OR GATE THAT SWINGS AWAY FROM THE WALK. SUCH WALKS SHALL EXTEND 24-INCH TO THE SIDE OF THE STRIKE EDGE OF A DOOR OR GATE THAT SWINGS TOWARD THE WALK.
- ALL WALKS WITH CONTINUOUS GRADIENTS SHALL HAVE LEVEL AREAS AT LEAST 5 FEET IN LENGTH AT INTERVALS OF AT LEAST EVERY 400 FEET. IF A WALK CROSSES OR ADJOINS A VEHICULAR WAY, AND THE WALKING SURFACES
- ARE NOT SEPARATED BY CURBS, RAUNGS OR OTHER ELEMENTS BETWEEN THE PEDESTRIAN AREAS AND THE VEHICULAR AREAS, THE BOUNDARY BETWEEN THE A SHALL BE DEFINED BY A CONTINUOUS DETECTABLE WARNING WHICH IS 367 WIDE AREAS

## RAMPS

- ANY PATH OF TRAVEL SHALL BE CONSIDERED A RAMP IF ITS SLOPE IS GREATER THAN I FT. RISE IN 20 FT. OF HORIZONTAL RUN.
- PEDESTRIAN RAMPS SHALL BE A MINIMUM 48-INCHES CLEAR WIDTH BUT NOT LESS THAN THE WIDTH REQUIRED FOR STAIRWAYS AND EXITS.
- PEDESTRIAN RAMPS SERVING ENTRANCES TO BUILDINGS WHERE THE RAMP IS THE ONLY ENT DISCHARGE PATH OR SERVES AN OCCUPANT LOAD OF 300 OR MORE SHALL HAVE A MINIMUM CLEAR WIDTH OF GO-INCHES.
- THE MAXIMUM SLOPE OF A RAMP THAT SERVES ANY EXIT WAY, PROVIDES ACCESS FOR PERSONS WITH PHYSICAL DISABILITIES OR IS IN THE PATH OF TRAVEL SHALL BE I FOOT RISE IN 12 FEET OF HORIZONTAL RUN.
- 5 THE CROSS SLOPE OF RAMP SURFACES SHALL BE NO GREATER THAN 1-JIN VERTICAL TO 50-UNT5 HORIZONTAL (2% SLOPE). THE LANDINGS SHALL BE LEVEL WITH A MAXIMUM SLOPE IN ANY DIRECTION NOT TO EXCEED 2%.
- TOP LANDINGS SHALL NOT BE LESS THAN GO-INCHES WIDE AND SHALL HAVE A LENGTH OF NOT LESS THAN GO-INCHES IN THE DIRECTION RAMP RUN.
- DOORS IN ANY POSITION SHALL NOT REDUCE THE MINIMUM DIMENSION OF THE RAMP LANDING TO LESS THAN 42-INCHES AND SHALL NOT REDUCE THE REQUIRED WIDTH BY MORE THAN 3 INCHES WHEN FULLY OPEN.
- THE WIDTH OF THE LANDING SHALL EXTEND 24-INCHES PAST THE STRIKE EDGE OF ANY DOOR OR GATE FOR EXTERIOR RAMPS AND 1.8-INCHES PAST THE STRIKE EDGE FOR INTERIOR RAMPS.
  - INTERMEDIATE AND BOTTOM LANDINGS AT A CHANGE OF DIRECTION IN EXCESS OF 30 DEGREES SHALL HAVE A DIMENSION IN THE DIRECTION OF RAMP RUN ON NOT LESS THAN 72-INCHES TO ACCOMMODATE THE HANDRAL EXTENSION.
- AT BOTTOM AND INTERMEDIATE LANDINGS, THE WIDTH SHALL BE AT LEAST THE SAME AS REQUIRED FOR THE RAMPS.
- OTHER INTERMEDIATE LANDINGS SHALL HAVE A DIMENSION IN THE DIRECTION OF RAMP RUN OF NOT LESS THAN GO INCHES.
- HANDRAILS ARE REQUIRED ON RAMPS THAT PROVIDE ACCESS IF THE SLOPE EXCEEDS 1 FOOT RISE IN 20 FEET OF HORIZONTAL RUN.
- DALEDS 11 DOT NOT IN BOTTEL OF INFORMATION NOT. HANDRAIS SHALL BE FLACED OF INFORMATION NAME, SAME, SHALL BE CONTINUOUS THE FULL ENGTH OF THE RAMP, SHALL BE SAHINCHES TO 38-INCH ABOVET THE RAMP SURFACE, STALL EXTEND A MINUMU OF I FOOT BEYOND THE TOP AND BOTTOM OF THE RAMP, AND THE ENDS SHALL BE RETURNED. 14. 38-INCHES
- HANDRAILS PROJECTING FROM A WALL SHALL HAVE A SPACE OF NOT LESS THAN 1-1/2 INCH BETWEEN THE WALL AND THE HANDRAIL.
- THE GRIP PORTION OF THE HANDRAIL SHALL BE NOT LESS THAN 1-1/4 INCHES NOR THE SHALL STATUST OF THE PANDRAIL SHALL BE NOT LESS THAN 1-1/41 NCHH MORE THAN 2-INCHES IN CROSS SECTIONAL DIMENSION OR THE SHAPE SH PROVIDE AN EQUIVALENT GRIPPING SURFACE AND ALL SURFACES SHALL BE SMOOTH WITH NO SHARP CORNERS.
- THE SURFACE OF RAMPS SHALL BE ROUGHENED OR BE SLIP RESISTANT MATERIALS. WHERE THE RAMP SURFACE IS NOT BOUNDED BY A WALL OR FENCE AND THE RAMP EXCEEDS I O FT. IN LENGTH, THE RAMP SHALL COMPLY WITH ONE OF THE FOLLOWING
  - REQUIREMENTS: A GUIDE CURB A MINIMUM OF 2-INCHES IN HEIGHT SHALL BE PROVIDED AT EACH SUE OF THE RAMP, OR B) A WHEEL GUIDE FAIL SHALL BE PROVIDED, CENTERED 3-INCHES PLUS OR MINUS I -INCH BROVE THE SURFACE OF THE RAMP.

#### CURB RAMPS

- CURB RAMPS SHALL BE CONSTRUCTED AT EACH CORNER OF STREET INTERSECTIONS AND WHERE A PEDESTRIAN WAY CROSSES A CURB.
- CURB RAMPS SHALL BE A MINIMUM OF 4 FEET IN WIDTH AND SHALL LIE, GENERALLY, A SINGLE SLOPED PLANE, WITH A MINIMUM OF SURFACE WARPING AND CROSS SLOPE
- THE SLOPE OF CLUB RAMES SHALL NOT EXCEED 1-JUNT VERTICAL TO 12-JUNTS HORZOFFAL TRANSITIONS FROM RAMES TO WALSS, CUTTERS, OF STREETS SHAL GUTTERS OF ROOTS SHRAFTS IN MIXED STREETS SHALL GUTTERS OF ROOTS SHRAFTS IN MIXED SHALL NOT EXCEED 1-JUNT VERTICAL TO OF THE FAMBLE OF RAVES SHALL NOT EXCEED 1-JUNT VERTICAL TO 10-UNITS HORIZONTAL
- A LEVEL LANDING A FEET DEEP SHALL BE PROVIDED AT THE UPPER END. OF EACH CURR RAMP OVER ITS FULL WIDTH TO PERMIT SAFE EGRESS FROM THE RAMP SURRACE, OR THE SUCE OF THE FANNED OR FLAEED SIDES OF THE CURB RAMP SHALL NOT EXCEED 1-UNIT VERTICAL TO 1.2-UNITS HORIZONTAL.
- THE SURFACE OF EACH CURB RAMP AND ITS FLARED SIDES SHALL BE STABLE, FIRM AND SUP-RESISTANT AND SHALL BE OF CONTRASTING FINISH FROM THAT OF THE ADJACENT SIDEWALK.
- Discoult, OR COMMUNICATION OF THE CLIRE RANGE VIEW BELT AND A CLIRES OF OTHER WELLDEFINED COMMUNICATION OF THE CLIRES RANGES VIEW AND A CLIRES AN
- C. CLAB MARE PHALL INVESTIGATE MEMORY INTO PERFECT THE FILL MET AND DETHICATION CONTRACT THE COOLEMENT OF DETENDED AND MEMORY WARNING SHALL CONSIDE OF MASED FILLACIATE DAMAGES OF THE ADMARETER ONDMARL OS DIAL CANADA CONTRACTOR DAMAGES WITH A DAMARETER OF NOMMARL OS DIAL OF AT THE BASE FILMENTS TO AS IN SUCH THE TOP, A RESIST OF NOMMARL OS DIAL OF AT THE BASE FILMENTS TO AS IN SUCH THE TOP, A RESIST OF DAMAGES THE ADMARET AND ADMARET AND ADMARETER OF NOMMARL OS DIAL OF AND A CONTRET TO CATTRET SYNCHE OF NOMMARL AS IN INCESS THE DAMAGES AND ADMARET AND ADMARET AND ADMARET AND ADMARET NOMMARL OS DIAL OF ADMARET AND ADMARET ADMARET ADMARET NOMMARL OS DIALOS AND ADMARET ADMARET ADMARET ADMARET DETHER LIGHTO-DAMARET ADMARET ADMARET ADMARET ADMARET DETHER LIGHTO-DAMARET ADMARET ADMAR CONTRAST SHALL BE AN INTEGRAL PART OF THE WALKING SURFACE.

## ENTRANCES AND DOORS

- ALL ENTRANCES AND ALL EXTERIOR GROUND-FLOOR EXIT DOORS SHALL BE ACCESSIBLE TO PERSONS WITH DISABILITIES.
- ALL ACCESSIBLE ENTRANCES SHALL BE IDENTIFIED WITH AT LEAST ONE STANDA SIGN AND WITH ADDITIONAL DIRECTIONAL SIGNS, AS REQUIRED, VISIBLE FROM APPROACHING PEDESTRIAN WAYS.

WHERE A PAIR OF DOORS IS UTILIZED, AT LEAST ONE OF THE DOORS SHALL

WHEN AN AUTOMATIC DOOR OPERATOR IS UTILIZED TO OPERATE A PAIR OF DOORS, AT LEAST ONE OF THE DOORS SHALL PROVIDE A CLEAR, UNOBSTRUCTED OPENING WIDTH OF 32-INCHES WITH THE DOOR POSITIONED AT AN ANGLE OF 90 DEGREES PROM ITS CLOSED POSITION.

LATCHING AND LOCKING DOORS THAT ARE HAND ACTIVATED AND WHICH ARE IN A PATH OF TRAVEL SHALL BE OPERABLE WITH A SINGLE EFFORT BY LEVEL-TYPE

PATH OF TRAVEL SHALL BE OPERABLE WITH A SINGLE EFFORT BY LEVEL.TYPE HARDWARE, PANICE BARS, PUES-IFULL ACTIVATIONS BARS, OR OTHER HARDWARE DESIGNED TO PROVIDE PASSAGE WITHOUT REQUIRING THE ABILITY TO GRASP OPENING HARDWARE. ALL EXIT DOORS SHALL BE OPENABLE FROM THE INSIDE WITHOUT THE LISE OF A KEY OR SPECIAL INOVAEDGE OR EFFORT.

HAND-ACTIVATED DOOR OPENING HARDWARE SHALL BE CENTERED BETWEEN 34-INCHES AND 44-INCHES ABOVE THE FLOOR.

6. THE FLOOR OR LANDING ON EACH SIDE OF A ENTRANCE OR PASSAGE DOOR SHALL BE LEVEL AND CLEAR. THE LEVEL AND CLEAR ARE SHALL HAVE A LEVEL IN THE BE LEVEL AND CLEAR. THE LEVEL AND CLEAR ARE SHALL HAVE A LEVEL IN THE HE DIRECTION FOR ONE SHALL OF A UNICHES AS MARKED IN FROM ANALES TO THE FLARE OF THE DOOR WITH OLCOBE POSITION. WHERE THE FLARE OF THE DOOR IS OFFERS OR LOCATED IN THE ALCOVER AD STANLED AT BOAT ANALES MARKED FROM THE FLARE OF THE DOORWINT TO THE FACE OF THE WALL. THE DOOR SHALL THE ROWNED IN THE DOORWING TO THE FACE OF THE WALL. THE DOOR SHALL THE ROWNED IN THE DOORWING TO THE FACE OF THE WALL. THE DOOR SHALL THE ROWNED IN THE DOORWING TO THE FACE OF THE WALL. THE DOOR SHALL THE ROWNED IN THIS DOOR STANLE OF THE CLEARANCES.

9. The work of the Livel, AND CLARA RAFA ON the SDE TO WHICH THE DOOR SWIM SHALL DETRID 24 AND ELSE AND THE STIRLE EDEC OF THE DOOR FOR EXTERDED DOOR SHALL DETRID 24 AND ELSE AND THE STIRLE EDEC OF THE DOOR FOR EXTERDED DOOR RECESSED OF LOCATED IN AN ANOVE, THE PROJECTION DESTINGE ALLOWED TO PROJECT INTO THE REQUIRED DOOR STIRLE CLARANCE MEASURED PROM THE FACE OF THE WALL TO THE FACE OF THE DOOR IS JUNED TO 0°.

THE FLOOR OR LANDING SHALL BE NOT MORE THAN 1/2-INCH LOWER THAN THE THRESHOLD OF THE DOORWAY, CHANGE IN LEVEL BETWEEN 1/4-INCH AND 1/2-INCH SHALL BE BEVELED WITH A SLOPE NO GRAFTER THAN 1/2.

THE BOTTOM 10-INCHES OF ALL DOORS EXCEPT AUTOMATIC AND SUDING SHALL HAVE A SMOOTH, UNINTERRUPTED SURPACE TO ALLOW THE DOOR TO BE OPENED BY AVHECLANER TOOTREST WITHOUT CREATING A TRAP OR HAZARDU/S CONDITION, WHERE NARROW FRAME DOORS ARE USED, A 10-INCH HIGH SMOOTH PANEL SHALL BE INSTALLED ON THE PUSH SIDE OF THE DOOR, WHICH WILL ALLOW

THE DOOR TO BE OPENED BY A WHEELCHAIR FOOTREST WITHOUT CREATING A TRAP OR HAZARDOUS CONDITION.

Inter SPACE BETWEEN TWO CONSECUTIVE DOOR OPENINGS IN A VESTIBULE, SERVING OTHER THAN A REQUIRED BIT STANDARY SHALL PROVIDE A MIMIMAU OF WHEN THE DOOR IS POSITIONED AT MAILAGUE OF DOORSES FROM ITS CLOSED WHEN THE DOORS IN A SERVES SHALL SWING EITHER IN THE SAME DIRECTION OR WAYY FROM THE SPACE BETWEEN THE DOORS.

1.3. MAXI

MAXIMUM EFFORT TO OPERATE DOORS SHALL NOT EXCEED 5 LBS. FOR EXTERIOR AND INTERIOR DOORS, SUCH TULL OR FUSH EFFORT BEING APPLED AT RIGHT AND TO HIKGED DOORS AND AT THE CENTER HOUR OF SUBJIONS OF ACTIONIS DOORS. COMPRESATING EPICES OR AUTOMATIC DOOR OPERATORS MAY BE UTLIZED TO MEET THE ABOVE STADARDS, WHEN BE OODS ARE RECOMED, THE MAXIMUM EFFORT TO OPERATE THE DOOR MAY EB CHORES AND FED TO THE MINIMUM ALLOWARE THE APPROPRIATE ADMINISTRATIVE AUTOMATICS IN 51 MINIMUM AUTOMATICS AND A MINIMATICS AND A MINIMATICS AND A MINIMANTOMATICS AND A MI

14. IF THE DOOR HAS A CLOSER, THEN THE SWEEP PERIOD OF THE CLOSER SHALL BE ADJUSTED SO THAT FROM AN OPEN POSITION OF 90 DEGREES, THE DOOR WILL TAKE AT LEAST 5 SECONDS TO MOVE TO A POSITION OF 12 DEGREES FROM THE LATCH

WATER CLOSET COMPARIMENT SHALL BE EQUIPPED WITH A DOOR THAT HAS AN AUTOMATIC-CLOSING DEVICE, AND SHALL HAVE A CLEAR, UNGESTRUCTED OPENI WOTH OF 32" WHEN LOCATED AT THE END AND 34" WHEN LOCATED AT THE SIDE WITH THE DOOR POSITIONED AT AN ANGLE OF 90 DEGREES FROM ITS CLOSED CONTROL

THE INSIDE AND OUTSIDE OF THE WATER CLOSET COMPARTMENT DOOR SHALL BE EQUIPPED WITH A LOOP OR U-SHAPED HANDLE IMMEDIATELY BELOW THE LATCH. THE LATCH SHALL BE FUI-OVER STYLE, SUDDING, OR OTHER HARDWARE NOT REQUIRING THE USER TO GRASP OR TWIST.

2. IN BUILDINGS IN OCCUPANCY GROUP A HAVING AN OCCUPANT LOAD OF

300 OR LESS, GROUPS B, F, M AND S, AND IN PLACES OF RELIGIOUS WORSHIP, THE MAIN EXTERIOR DOOR OR DOORS ARE PERMITTED TO B EQUIPPED WITH KEY-OPERATED LOCKING DEVICES FROM THE EGRESS 5

2.1. THE LOCKING DEVICE IS READILY DISTINGUISHABLE AS LOCKED

2.2. A READILY VISIBLE DURABLE SIGN IS POSTED ON THE EGRESS SIDE ON OR ADJACENT TO THE DOOR STATING: "THIS DOOR TO REMAIN UNLOCED WHEN BUILDING IS OCCUPIED: "THE SIGN SHALL BE IN LETTERS I INCH HIGH ON A CONTRASTING BACKGROUND.

2.3. THE USE OF THE KEY-OPERATED LOCKING DEVICE IS REVOKABLE BY THE BUILDING OFFICIAL FOR DUE CAUSE.

WHERE EGRESS DOORS ARE USED IN PAIRS, APPROVED AUTOMATIC FLUSH BOLTS SHALL BE PERMITTED TO BE USED, PROVIDED THAT THE DOOR LEAR HAVING THE AUTOMATIC FLUSH BOLTS HAS NO DOORKNOB OR SURFACE MOUNTED HARDWARE.

FIRE DOORS AFTER THE MINIMUM ELEVATED TEMPERATURE HAS DISABLED THE UNLATCHING MECHANISM IN ACCORDANCE WITH LISTED FIRE DOOR TEST PROCEDURES.

QUIRED EXITS AND BLIND CORRIDOR TURNS SHALL HAVE EXIT SIGNS. If SHALL HAVE LETTERS WITH A PRINCIPAL STROKE NOT LESS THAN 3/4" V

21 COPPIDORS SHALL BE FIRE RESISTANCE PATED IN ACCORDANCE WITH TABLE 1017.1

ALL EXIT DOORS SHALL SWING IN THE DIRECTION OF EXIT TRAVEL WHEN SERVING MORE THAN 50 OCCUPANTS PER BUILDING CODE.

ILLUMINATED EXIT SIGNS SHALL BE PROVIDED WHERE REQUIRED BY, AND IN ACCORDANCE WITH, APPLICABLE LAWS.

17. LOCKS AND LATCHES SHALL BE PERMITTED TO PREVENT OPERATION OF DOORS WHERE ANY OF THE FOLLOWING EXISTS:

I. PLACES OF DETENTION OR RESTRAINT.

PROVIDE A CLEAR, UNOBSTRUCTED OPENING WIDTH OF 32-INCHES WITH POSITIONED AT AN ANGLE OF 90 DEGREES FROM ITS CLOSED POSITION

22. ANY ROOM THAT IS USED FOR AN ASSEMBLY, DINNE, DRINKING OR SMILAR PURPOSE INSERT DIRES SATIS ARE NOT INSTALLED SHALL HAVE THE CAPACITY OF MAIN BOT OR ENTLACESS DOCRAWY FROM THE ROUMENT IN THE MARKENIN MAIN BOT OR ENTLACESS DOCRAWY FROM THE ROUMENT IN THE MARKENIN DOCRAWING THE AND THE ADDRESS OF THE ADDRESS AND THE MARKENIN TO WIGHT IS STATUCHED. SHOLEN SHALL INJURIES THE MAINERS OF DOCUMANTS FROMITIED FOR EACH ROOM USE. NO FRESON SHALL DEFACE ON REMOVE SUCH SIGN EXECT IN AUTOMODULE THE MAINERS OF REMOVE SUCH SIGN EXECT IN AUTOMODULE THE MAINERS OF DOCUMANTS FROMITIED FOR EACH ROOM USE. NO FRESON SHALL DEFACE ON REMOVE SUCH SIGN EXECT IN AUTOMODULE THE MAINERS OF DOCUMANTS FROM THE FOR EACH ROOM USE. NO FRESON SHALL DEFACE ON REMOVE SUCH SIGN EXECT IN A MUNICIPACIE THE INVERSION EXECUT.

IN BUILDINGS AND FACILITIES, FLOORS OF A GIVEN STORY SHALL BE A COMMON LEVEL THROUGHOUT, OR SHALL BE CONNECTED BY PEDESTRIAN RAMPS, PASSENGER LELEVATORS OR SPECIAL ACCESS LIFTS.

IF DARFE DR CARFET THE SI LESD DR A ARONNO DR ALCOR SINGHET, THAN IF SHALL BE SCIENTER ATTACHED. INVEA & REV CLEDON OR PAD OR EACOME DR NO CLEREND OR PAD, HAD HAVE A LEVEL LOOP, TEXTURED LOOP, LEVEL.OUT PAD OR LEVEL JURNALITY RE TEXTURE. THE MANNUN PRE TEXTURE THAN THE RIS REVEAL DATACHT RE TEXTURE. THE MANNUN PRE TEXTURE TEXTURE IN REVEAL DATACHT RE TEXTURE THE MANNUN PRE TEXTURE TEXTURE TRAN ALONG THE ENTIRE LONGTH OF THE ENTOGED EDGE. CARFET EDGE TRM SHALL COMPLY THAT THE REQUEREMENTS FOR CHANGES IN LEVEL.

IF GRATINGS ARE LOCATED IN WAIKING SURFACES, THEN THEY SHALL HAVE SPACES NO GREATER THAN 1/2" WIDE IN ONE DIRECTION. IF GRATINGS HAVE ELONGATED OPENINGS, THEY SHALL BE PLACED SO THAT THE LONG DIMENSION IS PERPENDICULAR TO THE DOMINIANT DIRECTION OF TRAVEL.

EVERY CORRIDOR AND HALLWAY SERVING AN OCCUPANCY LOAD OF 10 OR MORE SHALL NOT BE LESS THAN 44-INCHES IN WIDTH.

CORRIDORS AND HALLWAYS SERVING AN OCCUPANT LOAD OF LESS THAN 10 SHALL NOT BE LESS THAN 3G INCHES IN WIDTH.

CORRIDORS AND HALLWAYS THAT ARE LOCATED ON AN ACCESSIBLE ROUTE AND EXCEED 200 FEET IN LINGHIS SHALL HAVE A NINNAM CLARK WOTH SPACE OF Q INCHES BY QO NICHES LOCATED AR REASONABLE INTERVISAIS ON TO EXCEED 200 FEET. AT 'INTERSECTION OF TWO CORRIDORS OR WALKS IS AN ACCEPTABLE PASSING PLACE.

EVERY AISLE SHALL NOT BE LESS THAN 36" WIDE IF SERVING ONLY SIDE, AND NOT LESS THAN 44 INCHES WIDE IF SERVING BOTH SIDES.

HAZARDS AND PROTRUDING OBJECTS

ANY OBSTRUCTION THAT OVERHANGS A PEDESTRIANS WAY SHALL BE A MINIMUM OF 80 INCHES ABOVE THE WALKING SURFACE AS MEASURED FROM THE BOTTOM OF THE OBSTRUCTION.

OBJECTS MOUNTED WITH THEIR LEADING EDGES AT OR BELOW 27-INCHES ABOVE THE FINISHED FLOOR MAY PROTRUDE ANY AMOUNT.

OBJECTS PROJECTING FROM WALLS (FOR EXAMPLE, TELEPHONES) WITH THEIR LEADING EDGES BETWEEN 27 INCHES AND 80 INCHES ABOVE THE FINISHED FLOOR SHALL PROTINUE ON ORRE THAN 4 INCHES INTO WALKS, HALLS, CORRIDORS, PASSAGEWAYS OR AUSLES.

PROTRUDING OBJECTS SHALL NOT REDUCE THE CLEAR WIDTH OF AN ACCESSIBLE POLITE OF MANFLUEPING SPACE

WALKS, HALLS, CORRIDORS, PASSAGEWAYS, AISLES OR OTHER CIRCULATION SPACES SHALL HAVE 80-INCHES MINIMUM CLEAR HEAD ROOM.

ABRUPT CHANGES IN LEVEL, EXCEPT BETWEEN A WALK OR SIDEWALK AND A ADJACENT STREET OR DRIVEWAY, EXCEEDING 4-INCHES IN A VERTICAL DIMI

ADJACENT STREET OR DRIVEWAY, EXCEEDING 4-INCHES IN A VERTICAL DIMENSI SUCH AS AT PLANTHES OR FOLINTINS LOCATED IN OR ADJACENT TO WALKS, SIDEWALKS, OR OTHER PEDESTRIAN WAYS SHALL BE DEVENDER SUBPACE TO WARD I HEAST 4-INCHES I HEADIT ABOVE THE WALK OR SIDEWALK SUBPACE TO WARD THE BUND OF A FOTENTIAL DROP-OFF, WHEN A GUARDRAL OR HANDRALL IS PROVIDED, NO CURES IS FECURIERS WHEN A GUIDE FAULS

INCURSE OF THE WALK OR SIDEWALK, THE WALK OR SIDEWALK OR SIDEWALK, THE WALK OR SIDEWALK, THE WALK IS 5 PERCENT OR LESS GRADIENT OR NO ADJACENT HAZARD EXISTS.

THE MINIMUM CLEAR FLOOR OR GROUND SPACE REQUIRED TO ACCOMMODATE A SINGLE, STATIONARY WHEELCHAR AND OCCUPANT IS 30-INCHES X 43-INCHES. TH MINIMUM CLEAR FLOOR OR GROUND SPACE FOR WHEELCHARS MAY BE POSITION FOR FORWARD OR PARALLEL APPROACH TO AN OBJECT. CLEAR FLOOR OR GROUNI SPACE FOR, WHEICHARS MAY BE PART OF THE NICE SPACE REQUIRED UNDER

ONE FULL UNOBSTRUCTED SIDE OF THE CLEAR FLOOR OR GROUND SPACE FOR A WHEELCHAIR SHALL ADJOIN OR OVERLAP AN ACCESSIBLE ROUTE: OR ADJOIN ANOTHER WHEELCHAIR CLEAR FLOOR SPACE. IF A CLEAR FLOOR SPACE IS JOACTED IN AN ALCOVE OR OTHERWISE COMPINED ON ALL OR A PART OF THREE SIDES, ADDITIONAL WAREVERVISE CLEARANCE SHALL BE REVOLVED.

PROVIDE AN ADDITIONAL G-INCHES WIDTH ON ONE SIDE FOR ALCOVES GREATER THAN 24-INCHES DEEP AND DESIGNED FOR FRONTAL APPROACH.

IF THE CLEAR FLOOR SPACE ALLOWS ONLY FORWARD APPROACH TO AN OBJECT THE MAXIMUM HIGH FORWARD REACH ALLOWED SHALL BE 48-INCHES. THE MINIMUM LOW FORWARD REACH ALLOWED IS 15.

IF THE CLEAR FLOOR SPACE ALLOWS PARALLEL APPROACH BY A PERSON IN WHEELCHAIR, THE MAXIMUM HIGH SIDE REACH ALLOWED SHALL BE 48-INCH AND THE LOW-SIDE REACH ALLOWED SHALL BE NO LESS THAN 15-INCHES ABOVE THE FLOOR.

THE BOTTOM OF RECEPTACLE OUTLETS SHALL BE NOT LESS THAN 15-INCHES ABOVE THE FLOOR OR WORKING PLATFORM.

THE CENTER OF THE GRIP OF THE OPERATING HANDLE OF CONTROLS OR SWITCHES INTENDED TO BE USED THE OCCUPANT OF THE ROOM OR AVEA TO CONTROL UGHTING AND RECEIFFACLE OUTLETS, APPLANCES, OR, OCOLING, HEATING AND VENITATING EQUIPMENT, SHALL BE NOT LESS THAN 3-FEET NOR MCRE THAN 4-FEET ABOVE THE FLOOR OR WORKING FLATFORM.

THE CENTER OF FIRE ALARM INITIATING DEVICES (BOXES) SHALL BE LOCATED

WHERE A SINGLE COUNTER CONTAINS MORE THAN ONE TRANSACTION STATION, SUCH AS A BANK COUNTER WITH MULTIPLE TELLER WINDOWS OR A RETAL SALE COUNTER WITH MULTIPLE CASH REGISTER STATIONS, AT LEAST 5%, BUT NEVER LESS THAN 1, OF EACH TYPE OF STATION SHALL BE LOCATED AT A SECTION OF COSS THAN 1, OF EACH TYPE OF STATION SHALL BE LOCATED AT A SECTION OF

COUNTER THAT IS A LEAST 36" LONG AND 28" TO 34" HIGH.

48-INCHES ABOVE THE LEVEL OF THE FLOOR, WORKING PLATFORM, GROUND SURFACE OR SIDEWALK.

ADDITIONAL REQUIREMENTS

PROVIDE AN ADDITIONAL 12-INCHES WIDTH ON ONE SIDE FOR ALCOVES GREATER THAN 15-INCHES DEEP AND DESIGNED FOR SIDE APPROACH.

CLEAR FLOOR OR GROUND SPACE

FOR WHEELCHAIRS

SPACE FOR WHE SOME OBJECTS.

VIDE AND

Carlile

Coatsworth

Irvine, California 92612 Phone: 949.833.1930 Fax: 949.833.1140

Architects, Inc.

3

Urbane Cafe

TENANT IMPROVEMENT

URBANE CAFE

ENOS RANCHOS - BRADLEY WEST

655 EAST BETTERAVIA RD.

SANTA MARIA, CA 93454

CLIENT/ LL/ CITY SUBMITTAL 03 MAY, 2017

AS NOTED

HEALTH DEPT. RESUBMITTA

BUILDING DEPT. RESUBMITTA

REVISIONS:

A

PROJECT

DRAWN BY: SCALE:

SHEET TITLE

ACCESSIBILITY NOTES

**G-003** 

FILE:


DATE:

FLOORS AND LEVELS


FLOOR SURFACES SHALL BE SUP-RESISTANT.

CORRIDORS AND AISLES

EVERY PORTION OF EVERY BUILDING IN WHICH ARE INSTALLE MERCHANDISE, EQUIPMENT OR SIMILAR MATERIALS SHALL B ASLES LEADING TO AN EXIT.

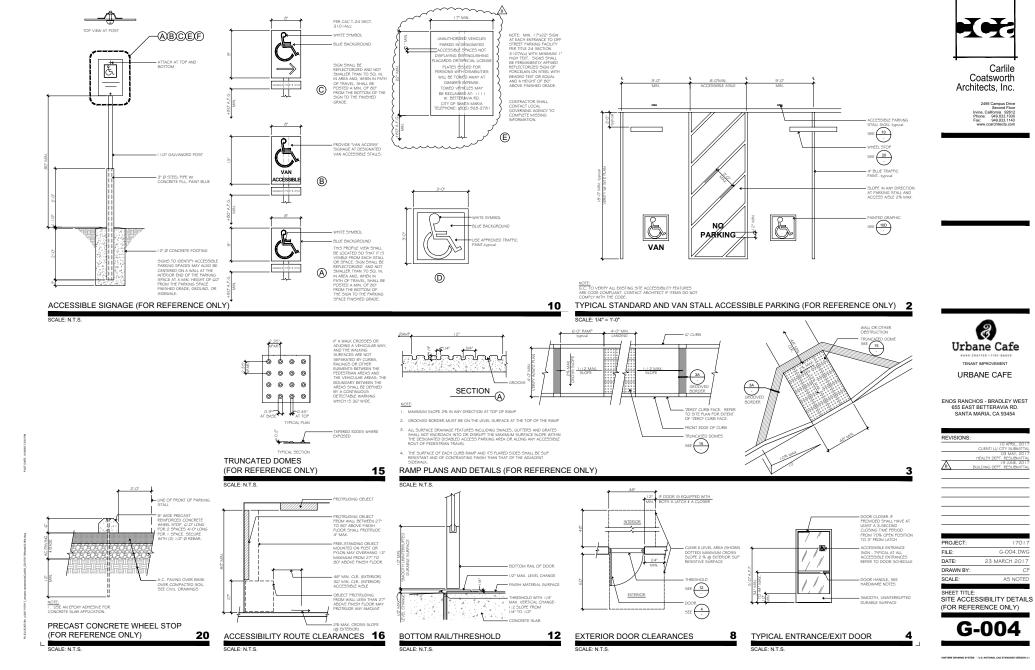


CF

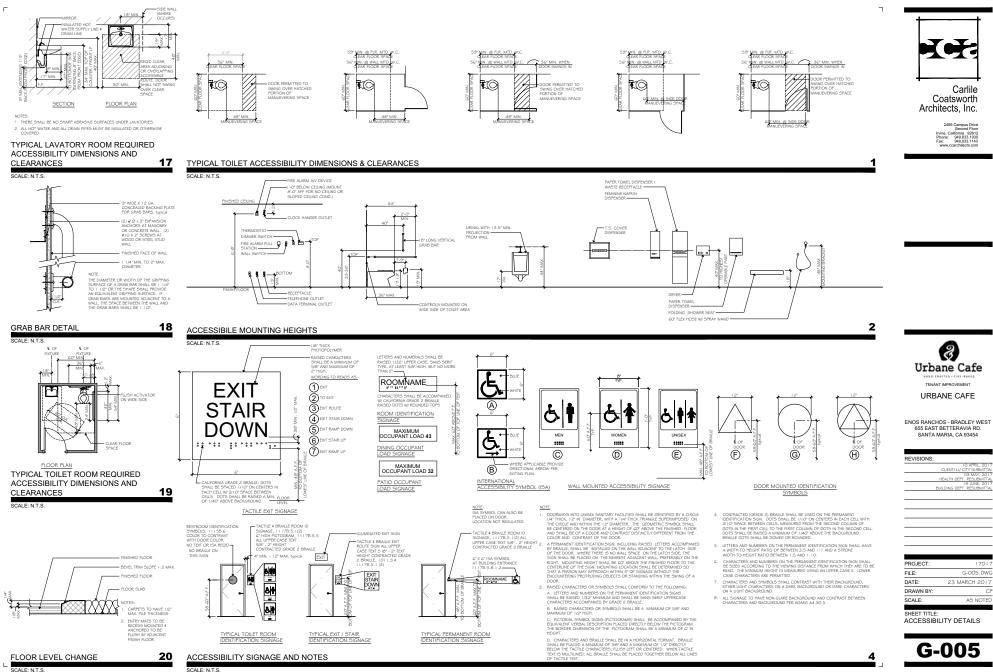

UNFORM DRAWING SYSTEM - U.S. NATIONAL CAD STANDAR

- I. THE GENERAL CONTRACTOR (G.C.) IS RESPONSIBLE TO MANAGE SCHEDULES AND SECURE ALL FURNISHED ITEMS.
- 2. THE G.C. IS EXPECTED TO ACCEPT ALL DELIVERIES WHEN THEY ARRIVE. ANY REFUSED SHIPMENTS WILL BE AT THE GCS COST TO RETURN.
- THE G.C. IS RESPONSIBLE TO KNOW ALL LOCAL REQUIREMENTS FOR INSPECTION TIMEFRAMES ON FIRE ALARM OR SPRINKLER SYSTEMS REQUIRED SUBMIT TO CITY WITHIN 3 DAYS OF CONSTRUCTION START FOR APPROVALS. 4. UPON ENTERING AGREEMENT, THE G.C. HAS AGREED TO PROVIDE THE NECESSARY STAFF AS REQUIRED TO COMPLETE THE RESTAURANT ON TIME.
- JOB SUPERINTENDENT MUST HAVE WORKED WITH YOUR COMPANY FOR AT LEAST ONE YEAR AND MUST HAVE A MINIMUM OF 3 YEARS EXPERIENCE IN JOB SUPERVISION. JOB SUPERINTENDENT IN DOT A WORKING FERINTENDENT BUT ONLY A SUPERINTENDENT TO BE ON THE JOB, EVERY DAY SUPERVISOR ON THE JOB.
- 6. G.C. TO PROVIDE DUMPSTER FOR ALL SITE WASTE ACCORDING TO LANDLORD REQUIREMENTS AND REMOVE PRIOR TO OPENING DAY.
- 7. G.C. TO CLEAN RESTAURANT PRIOR TO FINAL INSPECTION DATE OR TURNOVER.
- IT IS THE GENERAL CONTRACTORS RESPONSIBILITY TO FIND OUT IF THE PROJECT IS UNION OR NON-UNION. BID SUBMITTED WILL BE FINAL AND WILL NOT BE ADJUSTED.

# REQUIREMENTS

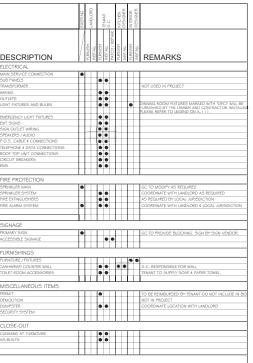

NOTE: GC-IS RESPONSIBLE TO COORDINATE BETWEEN ALL SHEETS INCLUDING-ARCHITECTURAL, MICHANICAL, ELECTICAL, PLUMBING, INTERIOR AND KITCHEN DISCIPLINES, IF ANY DISCREMANCES OCCUR THE G.C. SHALL NOTIFY THE ARCHITECT AS SOON AS POSSIBLE.

SCALE: SHEET TITLE: RESPONSIBILITY



PROJECT FILE:

DATE:

DRAWN BY:

**G-006** 

INFORM DRAWING SYSTEM - U.S. NATIONAL CAL

PRE-CONSTRUCTION

	EXISTING	ANDLORD		TENANT	Ú Í	KITCHEN	DESIGNER	INTERIOR	DESIGNER	
	/	URNISH	INDT ALL		REPAIR	FURNISH )		T	INSTALL 0	DEMARKO
DESCRIPTION		5	ž i	2 2	₹.	5	Z	5	Z	REMARKS
LOOR CONSTRUCTION										
CONCRETE SLAB			Т							
ILAB INFILL	_		1		<u>۱</u>					
RENCH / CORE DRILL	-	+	-19		•	-				
			_	_	_	_	_	_		
XTERIOR WALLS			_			_	_	_	_	
TOREFRONT FRAMING & FINISH		1	+	+						
IGN BAND IERVICE DOOR	•	++	+	+		1	-	-		NOT USED IN PROJECT
RAMING		t t	+	+	+	t	-			Construction of Phylodical
URRING & FINISH		t t	1	+	t	t	1			
NSULATION		Ð	1	T	L	L				
	T		Τ	Τ		Ē				
NTERIOR WALLS										
EMISING WALL STUDS		9			1	1				
EMISING WALL FINISH	1	•		1						
EMISING WALL INSULATION	-	•			+	1	-	-	-	
ARTITON FRAMING ARTITION FINISH	+		-ť		-	+	-	-	-	
OORS, FRAMES & HARDWARE	+		-12		-	ŀ	-	-		
IBER REINFORCED PANELS (FRP)	1	t t				t	1		H	
ORNER GUARDS			T		1					
AINTING										
XTERIOR		ł	Т			1				
TORE INTERIOR			-		•					
	_	ш	1		L	L	L	_		
CEILING / ROOF						_	_	_	_	
COUSTICAL CEILING TILE SYPSUM BOARD CEILING / SOFFITS	-		- 19		•	-	_	_		
OOF / DECK INSULATION			ď			-	-	-		
OOF WORK	1					t				LANDLORD REQUIRED SUB-CONTRACTOR
			1							
STOREFRONT										
TOREFRONT SYSTEM 4 GLAZING		U	Т		Γ	Γ				
EMPORARY BARRICADE			-		•					WHEN REQUIRED BY LANDLORD
NTRY DOORS & HARDWARE		1	+	+	+	+	-	-	-	
ISCHARICAL ADVAC			_	_		-		_		1
MECHANICAL (HVAC)	Lc.		_	_	_	-	_	_	_	
OOF TOP UNIT 1 OOF TOP UNIT 2		1	+	+	+	+	-	-	-	NOT USED IN PROJECT
COF TOP UNIT 3	+	t t	+	+	+	t	-			NOT USED IN PROJECT
XHAUST FAN I		t t	1		•	t	1			
XHAUST FAN 2	1		1	1	1	I.				
XHAUST FAN 3				1		Ľ				
UCTWORK & DAMPERS	-	11		1		+-	-	-	-	
RILLES, REGISTERS & DIFFUSERS HERMOSTATS, SENSORS & WIRING	+	++		Ŧ		ł	-	-	$\left  \right $	
HERMOSTATS, SENSORS & WIKING	+	++		ł		ł	-	-	$\left  \right $	GAS AND CONDENSATE DRAINAGE SYSTEM
	+	t t	ť		-	t	-			and the second sec
LUMBING		-	-	-	-	-	-	-		
VATER & SEWER ROUGH-IN		I T	T	-	-	Ē	_	-		
INTURES	1	Ħ	į,		ł.	t	1			
VATER. HEATER.	1	L	•		•	Г				
			1	•		Ľ				
OOF TOP UNIT CONNECTIONS	_	+ +								
COOF TOP UNIT CONNECTIONS			1							

Z Urbane Cafe TENANT IMPROVEMENT URBANE CAFE

ENOS RANCHOS - BRADLEY WEST 655 EAST BETTERAVIA RD.

BUILDING DEPT. RESUBMIT



17017

CP

G-006.DWG

AS NOTED


23 MARCH 2017



# Carlile Coatsworth

Architects, Inc.



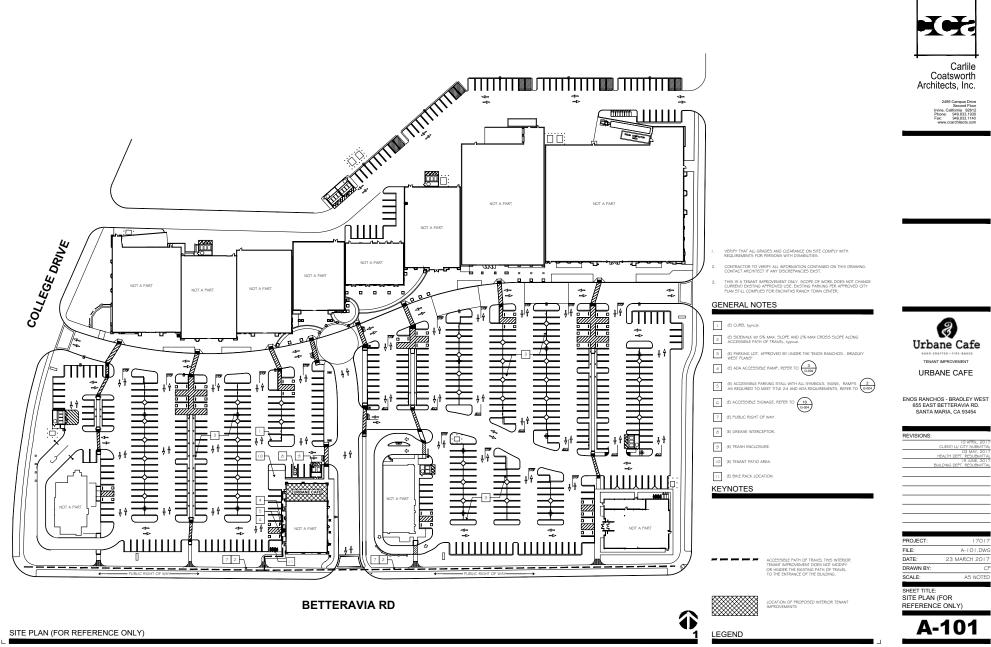



Coatsworth Architects, Inc.



ALL DIMENSIONS ARE TO CENTERLINE OF COLUMN / FACE OF STUD / MASONRY/ CONCRETE / EXISTING FINISH, UNLESS NOTED OTHERWISE.

CURTAINS, DRAPES AND OTHER DECORATIVE MATERIALS SUSPENDED FROM THE WALLS OR CEILINGS SHALL MEET THE FLAME SPREAD PROPAGATION PERFORMANCE CRITERIA OF NETRY 701 IN ACCOMANCE WITH SECTION 806.2 OR BE NONCOMBUSTIBLE. BUILDING N 806.1

3.

THE MEANS OF EGRESS INCLUDING THE EXIT DISCHARGE. SHALL BE ILLUMINATED TO A LEVEL OF NOT LESS THAN ONE FOOT-CANDEL AT THE WALKING SURFACE AT ALL TIMES THE BUILDING SPACE SERVED BY THE MEANS OF EGRESS IS OCCUPIED.

G.C. TO COORDINATE WITH ALL DISCIPLINES IN THE SET INCLUDING KITCHEN AND INTERIOR DRAWINGS.

GENERAL NOTES

1 FOR RESTROOM FIXTURE CLEARANCES PLEASE REFER TO SHEET G-005.

2 REFER TO FLOOR FINISH PLAN SHEET K-S FOR ALL INTERIOR FLOOR FINISHES.

3 FLOOR TO BE PREPARED FOR INSTALLATION OF COOLER PER MANUFACTURES SPECIFICATIONS.

4 (N) ELECTRICAL PANELS - SEE ELECTRICAL DRAWINGS.

6 (E) STOREFRONT AND DOORS TO REMAIN.

KEYNOTES

2 1/2" METAL STUDS PER SCHEDULE 4/A-502 TO UNDERSIDE OF STRUCTURE, REFER TO DETAIL 20/A-501, S/8" MOISTURE RESISTANT GYP. BD. ""CONCERTE BD. INSTEAD OF GYP BD. ANYWHERE WITHIN 24" OF THE NICHEN HOOD.

 $\diamond$ G 'METAL STUDS PER SCHEDULE 4/A-502 37',42', AND 32' LOW WALLS WITH SNEEZE GUARD PER SHEET K-1. S(#' MOISTURE RESISTANT G/P', BD, BOTH SIDES, REFER TO DETAILS 4 AND 8 ON SHEET A-501 FOR LOW WALL SUPPORT COLUMNS.  $\langle 2 \rangle$ 

3 5/8" METAL STUDS PER SCHEDULE 4/A-502 TO UNDERSIDE OF STRUCTURE, 5/8" GYP. BD. BOTH SIDES, TYPICAL, R-19 BATT INSULATION TYPICAL, MOISTURE RESISTANT GYP. BD. REFER TO DETAIL 20/A-501. 

G\* METAL STUDS PER SCHEDULE 4/A-502 TO UNDERSIDE OF STRUCTURE, 5/8\* MOISTURE RESISTANT GYP. BD. BOTH SIDES, TYPICAL. R-19 BATT INSULATION TYPICAL. REFER TO DETAIL 20/A-501.

NOTE: ANY CONSTRUCTION THAT IS WITHIN 24" OF THE HOOD OR OVEN NEEDS TO BE I HR ASSEMBLY WITH CONCRETE BD. INSTEAD OF GYP. BD.

WALL TYPES

A (#) DOOR TAG. REFER TO A-GO | FOR DOOR SCHEDULE EXISTING WALL TO REMAIN. PATCH AND REPAIR AS NECESSARY READY TO RECEIVE NEW FINISHES. NEW CONSTRUCTION ACCESSIBLE SIGNAGE, REFER TO 4/G-004 OCC. TOTAL OCCUPANCY SIGNAGE, REFER TO 4/G-005.  $\Box$ ALIGN

PROJECT FILE: A-IIO.DWG DATE: DRAWN BY: ĆP SCALE: AS NOTED SHEET TITLE: FLOOR PLAN

Z

Urbane Cafe

TENANT IMPROVEMENT

URBANE CAFE

ENOS RANCHOS - BRADLEY WEST 655 EAST BETTERAVIA RD.

SANTA MARIA, CA 93454

CLIENT/ LL

HEALTH DE

BUILDING DE

REVISIONS

 $\mathbb{A}$ 

A-11

SCALE: 1/4" = 1'-0"

L

Г



LEGEND

(€₁

DINING 102

,\_\_\_\_Ĵ

EXTERIOR \_\_\_\_\_

 $\langle 3 \rangle$ 

π4

 $\langle \rangle$ 

 $\widehat{}$ 

 $\langle \rangle$ 

-

 $\langle 2 \rangle$ 

S'-O' MIN

ENTRY 101

(I)

EXTERIOR

5

-

2

<u>\_</u>\_\_\_\_

KITCHEN 106

ADJACENT TENANT

 $\odot$ 

BAKERY PREP 103

Ŷ

000

5

MEN'S RESTROOM

WOMEN'S RESTROOM 105


2

EXTERIOR

A-112

5

FLOOR PLAN

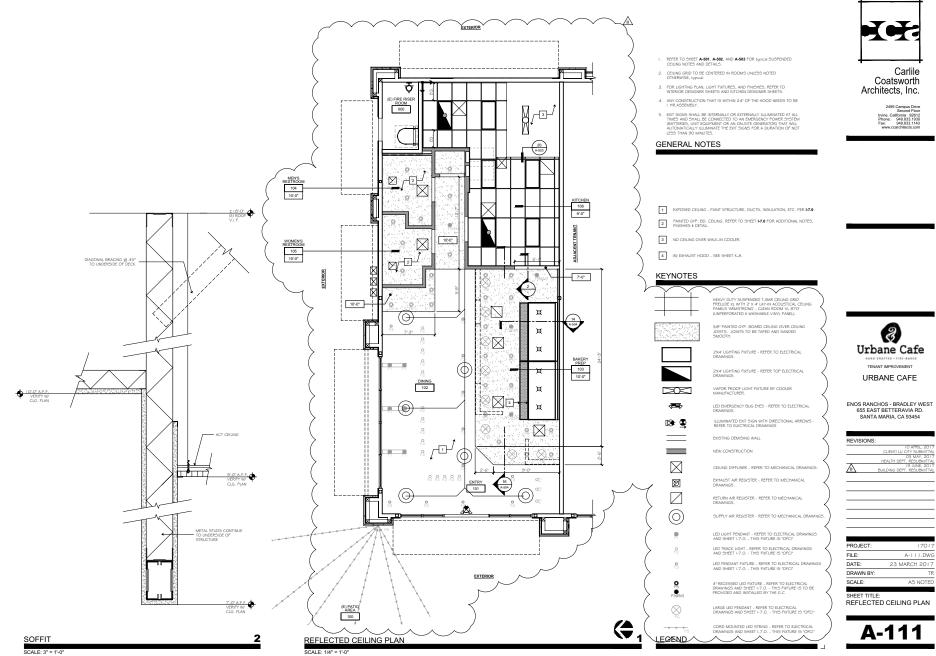

1701

A-III.DWG

AS NOTED

Г

1



Carlile Coatsworth Architects, Inc.



1. PROVIDE "K" RATED PORTABLE FIRE EXTINGUISHER(5) FOR THE KITCHEN AREA COMMERCIAL HOOD SYSTEM.

MINIMUM 2A 10B:C FIRE EXTINGUISHERS SHALL BE FROWDED. TRAVEL DISTANCE TO ANY EXTINGUISHER SHALL NOT EXCEED 75 FEET FROM ANY PORTION OF THE BUILDING. SUTINGUISHERS) SHALL BE HUNG NO HIGHER THAN 44 NICHES MEADWED FROM THE FLOOK TO THE TOP OF THE EXTINGUISHER.

THE SURFACE OF FLOORS SHALL BE SUP RESISTANT. WHEN TESTED IN ACCORDANCE WITH ASTM C1028B TEST PROCEDURE FOR COEFFICIENT OF FRICTION, TILE MUST ACHIEVE A WET AND DRY VALUE OF NOT LESS THAN C

## GENERAL NOTES

TO PUBLIC RIGHT OF WAY

NITCHEN 106

BAKERY PREP 103

TO PUBLIC

707

(♣₁

LEGEND

đ

Ŷ

(E) FIRE RISEI ROOM

Ľ 

RESTROOM 105

Ò

╏┓╱┓

бſ

p p

<u>p</u>

80

ଇଇ

N N N N N N

4

, /

<u>ØØ</u>

ଇଇ

ଅଅଅଅ

₩ÍÆP

Ø

1

Ø

ø

阙

Ø.

3

S S

102 <u>`</u>@'

<u>\_6</u>\_

5

70

<u>B</u> B

N N N N N

a a a a a

4

## 1 ALL FURNISHINGS PER SHEETS: K-1 AND K-2.

- 2 ACCESSIBLE SEATING LOCATION (60 X 5% = 3 TOTAL).

3 MIN. 2A 10B:C FIRE EXTINGUISHER HUNG NO HIGHER THAN 44" TO TOP OF EXTINGUISHER FROM FINISH FLOOR ,SEE DETAIL 12 / A-801.

4 (N) PATIO RAIL PER INTERIOR DESIGNER.

6 (E) GREASE INTERCEPTOR LOCATION TO REMAIN.

- (E) TRASH CONTAINER LOCATION TO REMAIN.
- (E) PARKING TO REMAIN.

## KEYNOTES



LOOSE SEATING AREA / INCLUDING AISLES (365 S.F.)

PROJECT FILE: A-II2.DWG DATE: DRAWN BY: SCALE: AS NOTED SHEET TITLE:

3

Urbane Cafe

TENANT IMPROVEMENT

URBANE CAFE


ENOS RANCHOS - BRADLEY WEST 655 EAST BETTERAVIA RD. SANTA MARIA, CA 93454

CLIENT/

REVISIONS

FIXTURE PLAN



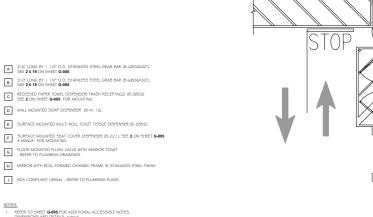

NOTES:


Г

- 1. REFER TO SHEET G-005 FOR ADDITIONAL ACCESSIBLE NOTES, DIMENSIONS AND DETAILS, typical.
- STAINLESS STEEL TOILET ROOM ACCESSORIES AS MANUFACTURED BY BOBRICK WASHROOM EQUIPMENT COMPANY OR EQUAL, typical.
- 3. REFER TO PLUMBING DRAWINGS FOR PLUMBING FIXTURE SPECIFICATIONS. typical

D WALL MOUNTED SOAP DISPENSER (B-4112).

G FLOOR MOUNTED FLUSH VALVE WITH SENSOR TOILET - REFER TO PLUMBING DRAWING5


J ADA COMPLIANT URINAL - REFER TO PLUMBING PLANS

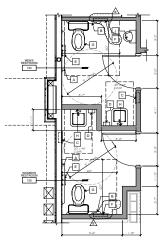





2

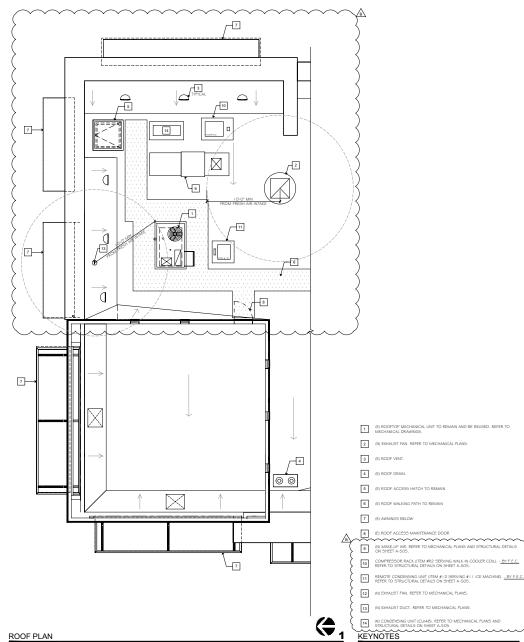



2495 Campus Drive Second Floor Irvine, California 92612 Phone: 949,833,1190 Fax: 949,833,1140 www.carchitects.com



	ENOS RANCHOS - BRADLEY WEST 655 EAST BETTERAVIA RD. SANTA MARIA, CA 93454
D. REFER TO	
	REVISIONS:
	10 APRIL, 201 CLIENT/ LL/ CITY SUBMITTA
	O3 MAY, 201 HEALTH DEPT, RESUBMITTA
	BUILDING DEPT. RESUBMITTA

PROJECT:	17017
FILE:	A-II3.DWG
DATE:	23 MARCH 2017
DRAWN BY:	TR
SCALE:	AS NOTED
SHEET TITLE:	
ROOF PLAN	

A-113

SCALE: 1/4" = 1'-0"

L

Г





## SCALE: 1/4" = 1'-0"

г

ING SYSTEM - U.S. NATIONAL

Г

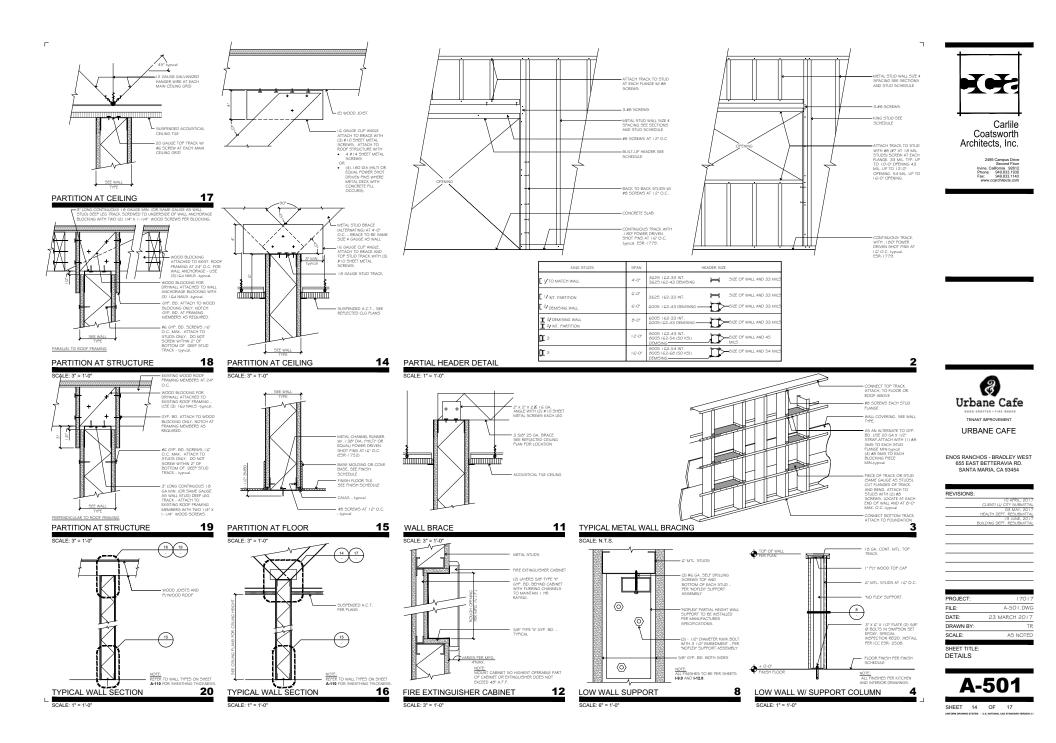

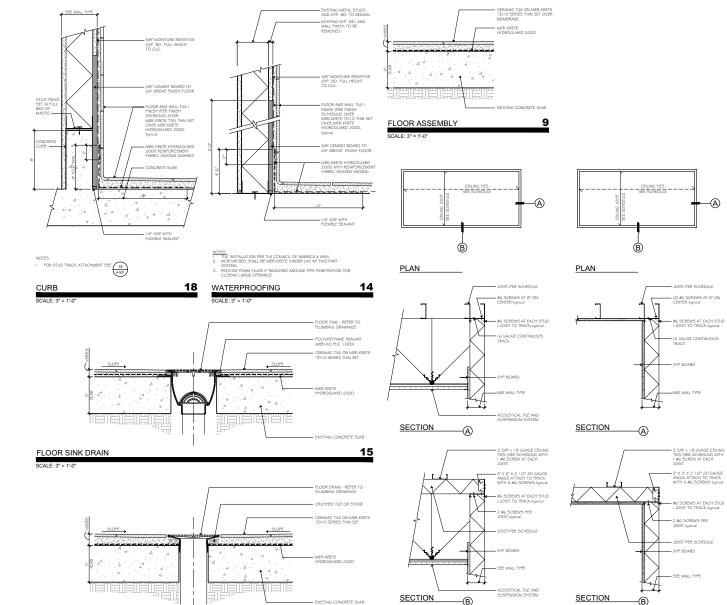

16

SCALE: 1 1/2" = 1'-0"

Г

## INTERIOR PARTITIONS (NON-LOAD BEARING)

-A)

5.

6.

- TERIOR FARITIONS MONLLAD BEARING BUILINK CODE USED SIE 2012 / KMS 100.2012 / CEC 2016. ALL THE WITH, STUDD USED SHALL BE 33 KSU U.N. CONFORMAN THE BROINER, SOCKING OF DUB DEARMING SIFTERIERS SHALL BE AS FEDURED THE WANAFACTURER UNLESS NOTED DIFERMICE ON FEDURED THE WANAFACTURER UNLESS NOTED DIFERMICE ON UNLESS OFTENDER OFTEND THE WANAFACTURER U.N.O. UNLESS OFTENDER OFTEND THE WANAFACTURER U.N.O. GUICEUR OF STUD SIZE SYNCHY OR WIEDON FANTIONE. GUICEUR OFTEND SIZE SYNCHY OR WIEDON FANTIONE. GUICEUR OFTEND SIZE SYNCHY OR WIEDON FANTIONE. GUICEUR OFTEND SIZE SYNCHY OR WIEDON FANTIONE.
- 4.

7	DESIGN LOAD: LATERAL LOAD = 5 PSF, DEFLECTION LIMIT = 1/120						
ſ	METAL STUDS	SIZE	MAX	IMUM			
	METAL STUDS	(SSMA DESIGNATION)	SPACING	HEIGHT			
t	3-5/8" x 25 GA	3625125-18	16	11'-9"			
ſ	3-5/8° x 20 GA	3625125-33	16	18-9			
I	6" × 20 GA	6005125-33	16	25'-0'			

3-5/8° x 20 GA	3625125-33	16	18-9
6" × 20 GA	6005125-33	16	25'-0'
6" × 1 8 GA	6005137-43	16	33'-0"
5" × 1.5 GA	8005137-43	16	39'-0"
5" × 1 G GA	46-0*		
EILING JOISTS (GYPE	BOARD CEILING)		

## BUILDING CODE USED IS IBC 2012 / AISI 5100-2007 / CBC 2016. ALL THE METAL STUDS USED SHALL BE 33 KSI U.N.O. CONFORMING


- 3.
- 4

TOTAL DEFLECTION LIMIT = NO STORAGE LOAD ALLOWED	U360		
SIZE	MAX	MUM	CEILING TIE
(SSMA DESIGNATION)	SPACING	SPAN	(BRACING) MAX. SPACIN
**3625125-18 (25 GA)	16"	6'-0'	4.0

0.0000.000.000.000			
3625125-33 (20 GA)	16"	9-6*	4'-1
6005125-33 (20 GA)	16*	14'-O"	4'-1
8005137-43 (18 GA)	16"	20-6*	4-1





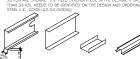







Carlile Coatsworth

Architects, Inc.

2495 Campus Dri Second Flo

Irvine, California 92612 Phone: 949.833.1930 Fax: 949.833.1140 www.ccarchitects.com

# URBANE CAFE

# ENOS RANCHOS - BRADLEY WEST 655 EAST BETTERAVIA RD.

## SANTA MARIA, CA 93454 REVISIONS: O APRIL 201

CLIENT/ LL/ CITY SUBMITTAL
 03 MAY, 2017
HEALTH DEPT. RESUBMITTAL
19 JUNE, 2017
BUILDING DEPT. RESUBMITTAL










SCALE: 3" = 1'-0"



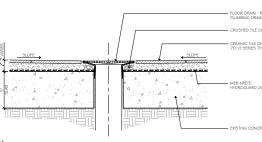


FLOOR DRAIN

12 CEILING FRAMING DETAILS

WALL WITH GYP BOARD CEILING SCALE: 1 1/2" = 1'-0"

# #G SCREWS AT EACH STUD / JOIST TO TRACK-typical 2 #G SCREWS PER JOIST-PER SCHEDULE

-®

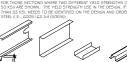



S-SECTIONS







ALL THE METAL STUDS USED SHALL BE 33 KSU U.N.D. CONFORMING TO BHUDING COLE. UNDERCHART STUDS USED SHALL BE UNDER STUDS OF SAME GAUGE AS STUD INCAS SHALL BE UNDER SHOLES UTH 2 - 46 SCREWS AT EACH JOINT OFFENDED SOL ONE STICE OF CENING U.N.D. PESIGN LOAD, DEAD LOAD 5 FSF 4 LIVE LOAD = 10 FSF, TOTAL DEFECTION LIMIT = 1260

NO ST

IES G)

	SPACING	SPAN	MAX. SPACING
5-18 (25 GA)	16"	6'-0"	4'-0'
5-33 (20 GA)	16"	9-6*	4'-0'
5-33 (20 GA)	16"	14'-0"	4'-0'
7-43 (18 GA)	1.6*	20'-6*	4'-0"




























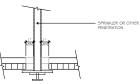


NOTE: SPRIALER HEADS AND OTHER PENETRATIONIS SHALL HAVE A 2° OVERSIZE RING, SEEVE, OK ADAPTES THROUGH THE CELING THE TO ALLOW FOR REE MOVEMENT OF A LEAST 1° IN AULTORIZZONTAL IDECTIONS, ALTERNATIVEY, A SWING JOINT THAT CAN ACCOMMODIATE CELING MOVEMENT IN ALL HORIZONTAL DECICIONS IS DEMITTED TO RE REVOLDED AT THE OF OF THE SPRINLER HEAD

## CEILING PENETRATION

SCALE: 3" = 1'-0"

-1/4'Ø SCREW EYE WITH FULL THREAD EMBEDMENT ( 1/4" MIN.) - 3"x4" OR 2"x6" OR LARGER ACING WIRE SUPPORT WRF

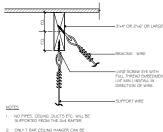

COOLER HEIGHT PER MANUFACTURES

20

I 1/2" COLD ROLLEE CHANNEL

NOT TO SCALE

 ONLY T BAR CEILING HANGER CAN BE SUPPORTED FROM THE BOTTOM OF 3x4 OR 2x6 MEMBER5 3. MAX. LOAD PER HANGER = 50 LBS. WIRE CONNECTIONS


SCALE: 1 1/2"= 1

METAL CEILING

CLOSURE PLATE

CLOSURE PLATE

SCALE: 1 1/2" = 1'-0"

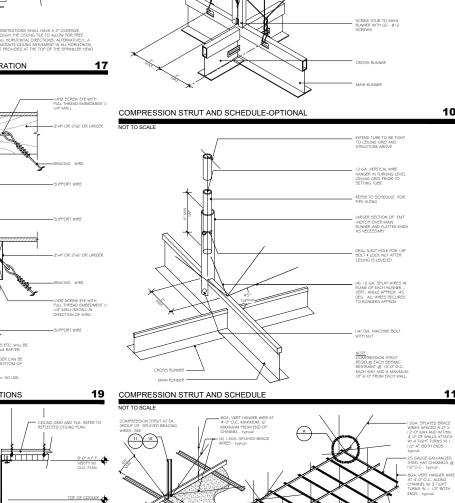

7/8" HAT CHANNEL

TYPICAL SUSPENDED GYP. BD CEILING

-GYP. BD. SCREWED 12" O.C.



16" O.C - typical	#G SHEET MET			
<ul> <li>8GA. VERT HANGER WIRE AT 4'-0" O.C. ALONG</li> </ul>			SCHEDULE	-
CHANNEL W/ 3 TIGHT TURNS IN 1 1/2" BOTH	METAL STUD		MAX HT. OF COM	PRESSION STRUT
ENDS - typical	SIZE	GAUGE	SINGLE STUD	DOUBLE STUD
	2505125-33	20 GA.	7'-0'	12'-6"
-ATTACH HAT CHANNELS TO	3625125-33	20 GA.	6'-6"	17'-0"
COLD ROLLED CHANNEL	3625137-43	18 GA.	8'-0"	17'-6"
WITH (2) #10 SHEET METAL	6005125-33	20 GA.	6-0"	26'-0"
SCREWS - typical	6005137-43	18 GA.	7'-6"	26'-6"
-1 1/2" X 16 GAUGE	8005137-43	18 GA.	7'-0"	34'-0"


THE FOLLOWING SPANS ARE BASED UPON STUDS HAVING A 1 5/8" LEG WITH A 3/8" RETURN, DOUBLE STUDS ARE CONNECTED TOGETHER IN THE SHAPE OF A "T", WITH ( )

SCHEDULE		
CONDUIT SIZE	MAXIMUM HEIGHT	
1/2" DIA	8-0"	
3/4* DIA	12-0	
I * DIA	18'-0"	
11/4" DIA	27'-0'	
1 1/2" DIA	34'-0"	
2" DIA	50-0	

IN LIEU OF A CALCULATION, THE FOLLOWING STRUT TYPES AND LENGTHS ARE ACCEPTABLE:

- STRUTS SHALL BE DESIGNED IN ACCORDANCE WITH ASCE 7-10, 13.5.6 DESIGN REQUIREMENTS.
- THE STRUT SHALL BE VERTICAL AND SHALL NOT HANG MORE THAN ONE IN SIX (1:6) OUT OF PLUMB.
- THE FOLLOWING IS TO BE CONSIDERED WHEN COMPLYING WITH THE ABOVE SECTION: IN A STRUCTURE WHERE THE ROOF SYSTEM IS COMPOSED OF BEAMS, PURING, MOS SUB-JURING, THE 204 SUB-TURING ARE MOT TO BE CONSIDERED STRUCTURE, MEMBERS SUPPORTING THE ROOF.
- LATERAL FORCE BRACING (COMPRESSION STRUT) REQUIRED A STRUT FASTENED TO THE MAIN RUNNER EXTENSION TO AND FASTENED TO STRUCTURAL MEMBERS SUPPORTING THE REOOF OR LOOP RADVE. MELLA STUDIS OR EMUT COMULT FER DETAILS 31-OR 41 ARE ACCEPTABLE. COMPRESSION STRUTS REQUIRED AT 12-0° O.C. AND A MINIMUM OF C-0° FORM EACH WALL.

## NOT TO SCALE

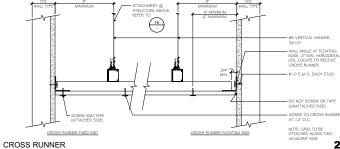

## NOT TO SCALE

10

11

GALVANIZED COLD RU CHANNEL AT 4'-0' O.C MAXIMUM - typical


METAL STUDS:

HANGER WIRES @ 4'-0" O.C.

MTAL STUD PER SCHEDULE

SEISMIC WIRES IN LINE

W RUNNERS @12'-0' O.C.E.W. 46'-0' MAX. FROM WALLS, 45° MAX. FROM HORIZ. PLANE -typical

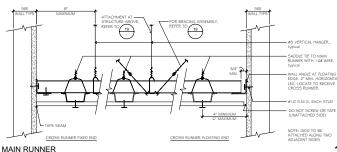



4

#8 WIRE VERTICAL HANGER AT 4'- 0" O.C.

COMPRESSION STRUT AT 6' X 8' O.C.

#12 DIAGONAL WIRE TIES. 4 TWISTS WITHIN 1-1/2" EACH END

1-1/2" MAIN RUNNER AT 4'-0" O.C.

#8 X 3/4" SELF-TAPPING SCREWS TO PREVENT SUPPAGE OF WIRE TIES

3

CROSS FURRING









# SANTA MARIA, CA 93454

ENOS RANCHOS - BRADLEY WEST 655 EAST BETTERAVIA RD.

TENANT IMPROVEMENT URBANE CAFE

Carlile Coatsworth Architects, Inc. 2495 Campus Driv Second Flo Irvine, California 92612 Phone: 949.833.1930 Fax: 949.833.1140 www.ccarchitects.com



Г

BRACE ASSEMBLY


BRACE ASSEMBLY


NOT TO SCALE


NOT TO SCALE

8


# 3 Urbane Cafe

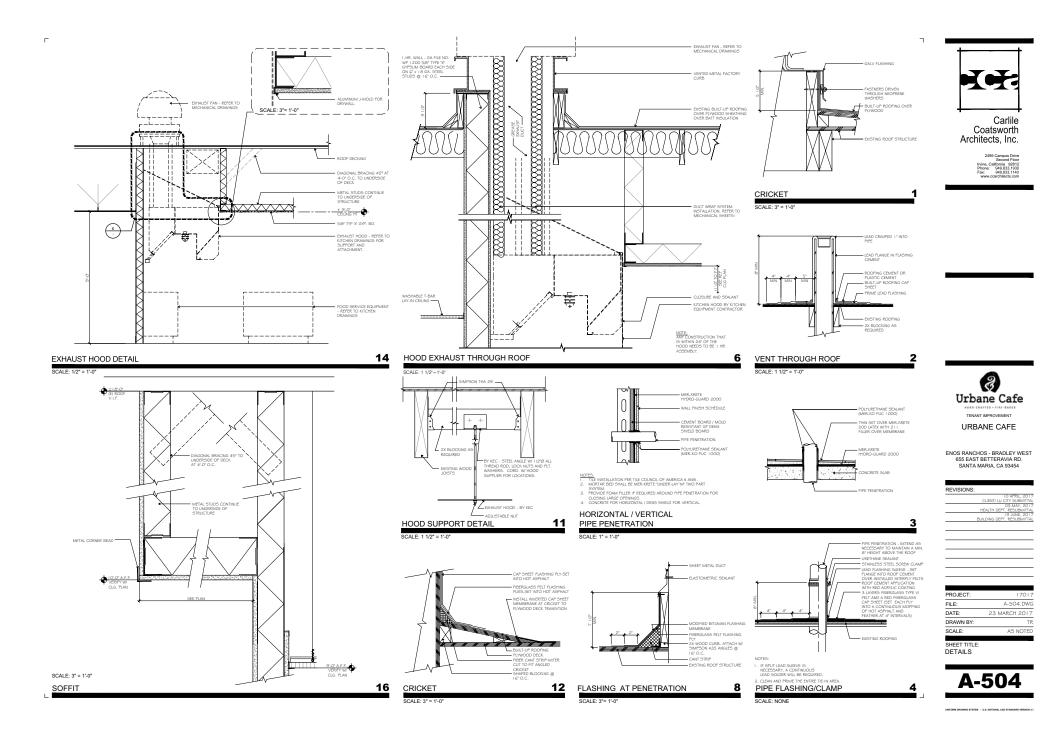

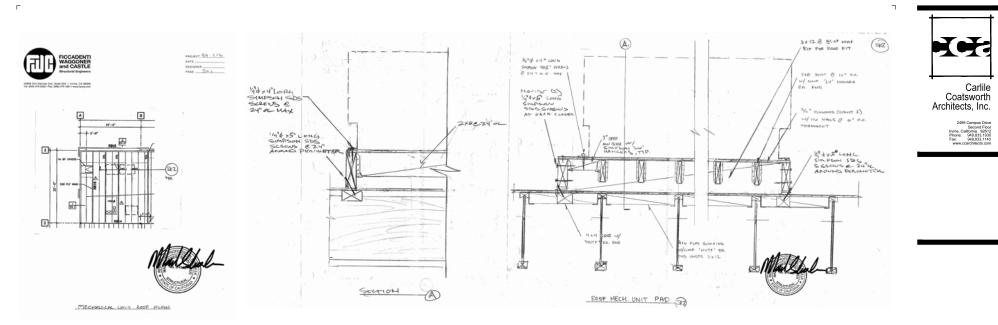

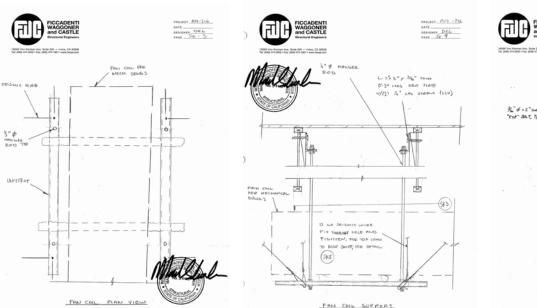

3" ¢ ROD

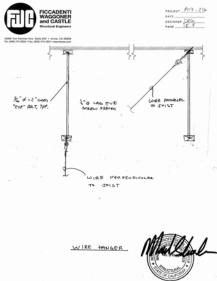




ENOS RANCHOS - BRADLEY WEST 655 EAST BETTERAVIA RD. SANTA MARIA, CA 93454

TO APRIL 2017 TY LU CITY SUBMITAL 03 MAY, 2017 TH DEPT, RESUBMITAL 19 JUNE, 2017 VG DEPT, RESUBMITAL
TH DEPT. RESUBMITTAL 19 JUNE, 2017
19 JUNE, 2017 NG DEPT. RESUBMITTAL
17017
A-505.DWG
23 MARCH 2017
CP
AS NOTED

A-505

·····

1

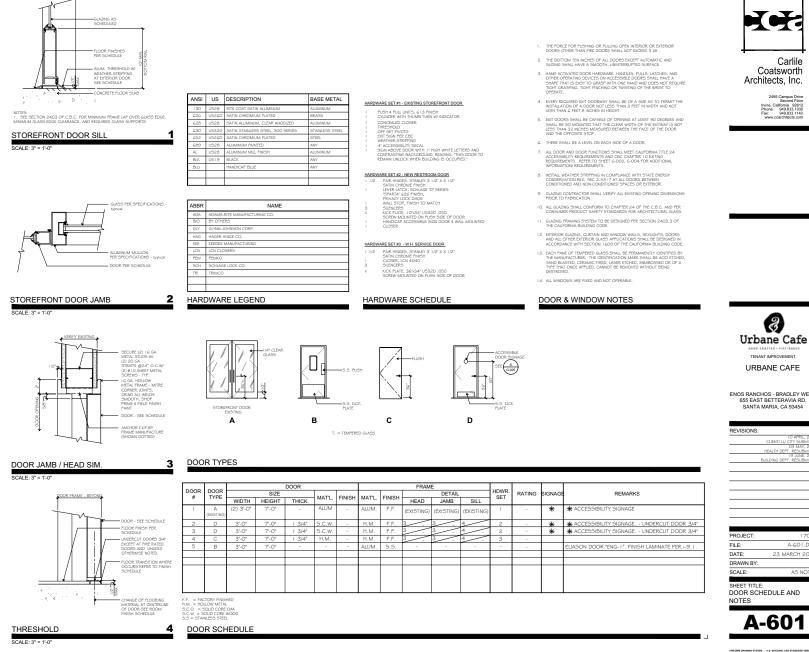



L



Г

Carlile Coatsworth Architects, Inc.



ENOS RANCHOS - BRADLEY WEST 655 EAST BETTERAVIA RD. SANTA MARIA, CA 93454

3

TENANT IMPROVEMENT

URBANE CAFE

VIS	S-	

CLIENT/ LL/ CITY SUBMITTA 03 MAY, 201 HEALTH DEPT BUILDING DEP1




PROJECT FILE: A-GOI.DWG DATE: DRAWN BY: TR SCALE: AS NOTED



A-601

UNFORM DRAWING SYSTEM - U.S. NATIONAL CAD

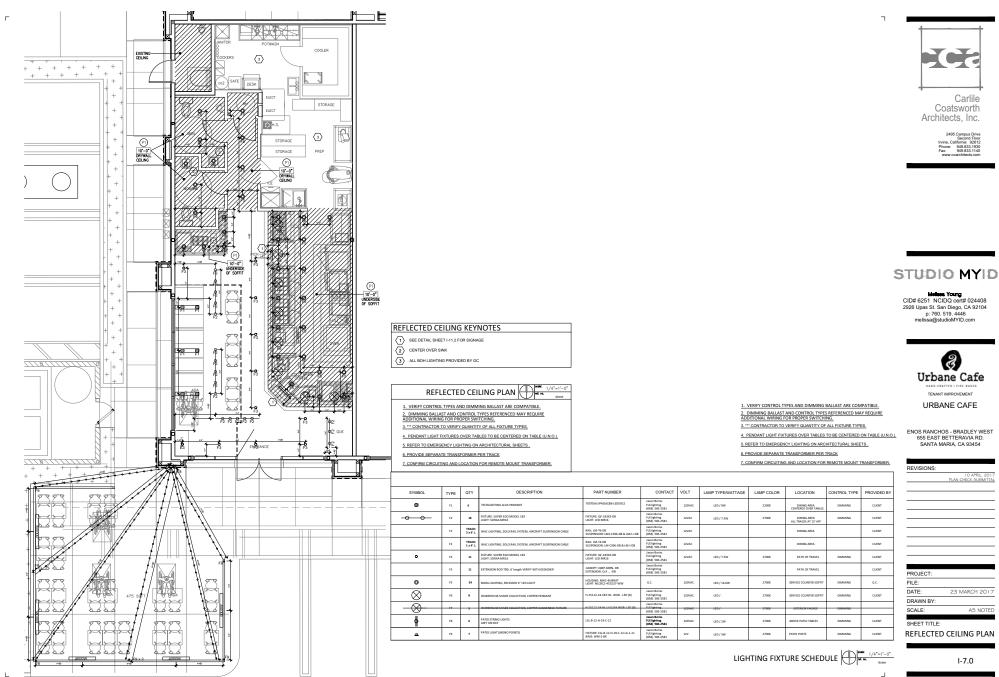

VING SYSTEM - U.S. NATIONAL CAD STANDARD VERSION



FINISH PLAN KEYNOTES

Carlile Coatsworth Architects, Inc.



 NEW DRYWALL SURFACES SHALL RECEIVE #1100 HI BUILD PRIMER SEALER BY VISTA PAINT OR EQUAL.

 PRIMER FOR ALL DRYWALL SURFACES SHALL BE #4000 UNIPRIME TINTED ACRYLIC PRIMER BY VISTA PAINT OR EQUAL.

 PAINTED SURFACES SHALL RECEIVE A MINIMUM OF (2) COATS OF PAINT. ADDITIONAL COATS MAY BE REQUIRED TO ACHIEVE SATURATION OF SELECTED COLORS. SEE LEGEND.

T REFER TO FOOD SERVICE PLAN FOR ADDITIONAL FINISH INFO. AT KITCHEN AREA.

3 SCHLUTER DILEX-AHK COVED AT ALL BASES OF RESTROOM TILE

PROVIDE BULLNOSE TILE FOR PT1

2 USE SCHLUTER/JOLLY PROFILE OR EQUAL TRANSITION PIECES AT ALL EXPOSED TILE EDGES.

4. EXISTING FLOORING AREAS THAT ARE TO REMAIN ARE TO BE CLEANED, PATCHED AND REPARED TO LIKE NEW CONDITION. NOTIFY DESIGNER WHEN DEMO IS COMPLETE FOR ONSITE INSPECTION AND APPROVAL SEE FINISH PLAN FOR AREAS TO REMAIN.

 ALL DRYWALL SOFFIT CONDITIONS TO RECEIVE (P-1), UNLESS NOTED OTHERWISE.
 UNLESS NOTED OTHERWISE, ALL WALL SURFACES SHALL RECEIVE PAINT (P-1) THROUGHOUT, SEE LEGEND.

THROUGHOUT, SEE LEGEND. 7 ALL PARTITIONS TO BE (P-1) U.N.O.

8, REFER TO ELEVATIONS FOR FURTHER DETAIL & LOCATION OF FINISHES.

PROVIDE DESIGNER WITH ALL SEAMING & FINISHES PLANS FOR APPROVAL PRIOR TO INSTALLATION. A 5° HIGH SELF-**GO**VING SLIMFOOT BASE IS REQUIRED AT ALL COUNTERS, U.N.O.

PAINT FINISH TOTALE EGG-SHELL U.N.O.

ALL FLOOR GROND. TO BE SEALED PER MANUFACTURES RECOMMENDATIONS. USE SCHLUTER ON EQUAL TRANSITION PIECES AT ALL EXPOSED TILE EDGES.

FINISH PLAN NOTES

ENOS RANCHOS - BRADLEY WEST 655 EAST BETTERAVIA RD. SANTA MARIA, CA 93454

**STUDIO MYID** 

Mellese. Young CID# 6251 NCIDQ cert# 024408 2926 Upas St. San Diego, CA 92104 p. 760. 519. 4446 melissa@studioMYID.com

Z

Urbane Cafe


TENANT IMPROVEMENT

URBANE CAFE

REVISIONS:		LO APRIL 2
	PLAN C	CHECK SUBMI
PROJECT:		
FILE:		
DATE:	23 N	ARCH 20
DRAWN BY:		
SCALE:	<sup>1</sup> / <sub>4</sub> "=1'-0"	AS NOT
SHEET TITLE	E.	

1-9.0

SYSTEM - U.S. NATIONAL CAD STA

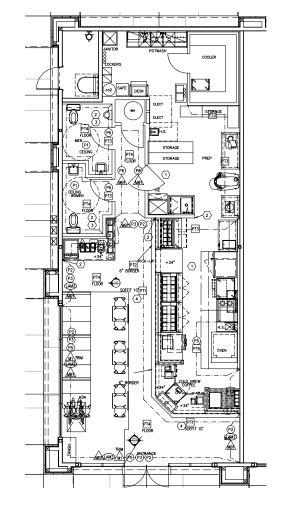

FINISH PLAN

 $\otimes$ -

Г

L

### 2016 CALIFORNIA BUILDING CODE

CHAPTER & INTERIOR FINISHES

Г

L

SECTION 801 GENERAL

801.1 SCOPE, PROVISIONS OF THIS CHAPTER SHALL GOVERN THE USE OF MATERIALS USED AS INTERIOR FINISHES. TRIM AND DECORATIVE MATERIALS.

8012 INTERIOR WALL AND CEILING FINISH. THE PROVISIONS OF SECTION 803 SHALL LIMIT THE ALLOWABLE FIRE PERFORMANCE AND SMOKE DEVELOPMENT OF INTERIOR WALL AND CEILING FINISH MATERIALS BASED ON OCCUPANCY CLASSIFICATION.

801.3 INTERIOR FLOOR FINISH. THE PROVISIONS OF SECTION 804 SHALL LIMIT THE ALLOWABLE FIRE PERFORMANCE OF INTERIOR FLOOR FINISH MATERIALS BASED ON OCCUPANCY CLASSIFICATION.

801.4 DECORATIVE MATERIALS AND TRIM. DECORATIVE MATERIALS AND TRIM SHALL BE RESTRICTED BY COMBUSTIBILITY AND THE FLAME PROPAGATION PERFORMANCE CRITERIA OF NFPA 701, IN ACCORDANCE WITH SECTION 806. [F]

801.5 APPLICABILITY. FOR BUILDINGS IN FLOOD HAZARD AREAS AS ESTABLISHED IN SECTION 1612.3, INTERIOR FINISHES, TRIM AND DECORATIVE MATERIALS BELOW THE DESIGN FLOOD ELEVATION SHALL BE FLOOD DAMAGE-RESISTANT MATERIALS.

80.6 APPLICATION. COMBUSTIBLE MATERIALS SHALL BE PERMITTED TO BE USED AS FINISH FOR WALLS, CEILINGS, FLOORS AND OTHER INTERIOR SURFACES OF

801.7 WINDOWS. SHOW WINDOWS IN THE EXTERIOR WALLS OF THE FIRST STORY ABOVE GRADE SHALL BE PERMITTED TO BE OF WOOD OR OF UNPROTECTED METAL EDAMING.

801.6 FOAM PLASTICS. FOAM PLASTICS SHALL NOT BE USED AS INTERIOR FINISH EXCEPT AS PROVIDED IN SECTION 803.4. FOAM PLASTICS SHALL NOT BE USED AS INTERIOR TRIM EXCEPT AS PROVIDED IN SECTION 806.3 OR 2004.2. THIS SECTION SHALL APPLY BOTH TO EXPOSED FOAM PLASTICS AND TO FOAM PLASTICS USED IN CONJUNCTION WITH A TEXTLE OR WINT ACANOS OR COVER.

NOTE: 1. PANT THE OR OTHER FINISH MATERIAL USED ON WALLS AND CEILINGS OF ALL KITCHENS, FOOD PREPARATION WORK, AND STORAGE AREAS WILL BE A LIGHT COLOR WHICH HAS A LIGHT REFLECTIVE VALUE OF 70% OR GREATER

2. THE MATERIAL SHOWN IN THE FINISH SCHEDULE WILL COMPLY WITH CBC TABLE 803.9 AND ALL WALL AND CEILING MATERIALS SHALL NOT EXCEED THE FLAME SPREAD CLASSIFICATION AND SMOKE DEVELOP RATINGS.

SYMBOL	MATERIAL TYPE	DESCRIPTION	DISTRIBUTOR/ CONTACT	SUPPLIED	INSTALLED	LOCATION	REMARKS/NOTES
FLOO	R FINISHES:						
PT1	PORCELAIN TILE	DALTILE / WALL TILE COLOR: BISCUIT K175 / 6X6 FIELD TILE SEMI GLOSS	WILLOW DECKER 619.228.4200 willow.decker@daible.com	G.C	G.C	SERVICE COUNTER, BEVERAGE AND SOFFIT STACKED PATTERN	G.C. TO SUBMIT SAMPLE
PT2	PORCELAIN TILE	CROSSVILLE / FLOOR TILE COLOR: EMPRESS WHITE / 6X6 TILE A215/1050EPD	TONY ROBSON 619.602.3462 TROBSON@CROSSVILLE.COM	G.C	G.C	FRONT SERVICE COUNTER FLOOR	G.C. TO SUBMIT SAMPLE
PT4	CERAMIC TILE	REFIN / DESIGN INDUSTRY COLOR: RAW GREY / 30X30	619.518.3011 beniĝgdhorvas.com	G.C	G.C	DINING AREA & RESTROOMS	G.C. TO SUBMIT SAMPLE
WALL	TILE & BASE:						
РТЗ	CERAMIC TILE	CAESAR / ONE COLOR: ROPE 30X30	BEN FRUESEN 619.518.3011 ben@gchomas.com	G.C	G.C	FOH KITCHEN WALL, TED	G.C. TO SUBMIT SAMPLE
PT5	CERAMIC TILE	LDI-GLOSSY BRICK-WHITE 4X12 VI-WHITE BODY TILE	DANELLE MORGAN 858.431.9522 DMDRGANGLONGUST.COM	G.C	G.C	PIZZA OVEN FACADE	G.C. TO SUBMIT SAMPLE
61	GROUT	LACTICRETE 78 STERLING SILVER EPOXY GROUT WITH SEALER	G.C	G.C	G.C	PT1 & PT2 PORCELAIN TILE ON SERVICE COUNTER & BEVERAGE STATION	G.C. TO SUBMIT SAMPLE
G2	GROUT	LACTICRETE 78 STERLING SILVER SANDED & SEALED GROUT	G.C	G.C	G.C	PT1 PORCELAIN TILE ON SOFFIT AND PT4 FLOOR TILE	G.C. TO SUBMIT SAMPLE
63	GROUT	LACTICRETE 35 MOCHA USE EPOXY GROUT WITH SEALER	G.C	G.C	G.C	ALL PT3 CERAMIC TILE	G.C. TO SUBMIT SAMPLE
<u>A</u>	METAL BASE	BLACK POWDER COATED METAL BASE	MILLWORKER	M.W	G.C	DINING AREA	
PAINTS	S:	TO MATCH FRAZEE WHITE SHADOW	1				1
(P1)	PAINT (WHITE)	#181, WITH BENJAMIN MOORE PAINT, SEMI GLOSS FINISH	G.C	G.C	G.C	SOFFIT AND RESTROOM CEILING	G.C. TO SUBMIT SAMPLE
P2	PAINT (BLACK)	BENJAMIN MOORE, BLACK SEMI GLOSS FINISH	G.C	G.C	G.C	UPPER PART OF INTERIOR WALLS	G.C. TO SUBMIT SAMPLE
PJ	PAINT (FAUX FINISH)	TO MACH SAMPLE PROVIDED BY MYID	MYID	G.C	G.C	INTERIOR WALLS	
•	PAINT (BLACK)	PAINT FOR ANODIZED ALUMINUM PROFILE.	6.0	G.C	G.C	METAL TRIM	G.C. TO SUBNIT SAUPLE
		ZOLATONE / PEARLTONE /					
P5	PAINT (COPPER)	ZOLATONE / PEARLTONE / PFX-C3057	G.C	G.C	G.C	DINING AREA WALLS AND OVEN (CERAMIC TILE)	G.C. TO SUBMIT SAMPLE
<b>P6</b>	PAINT (TAUPE)	BENJAMIN MOORE FAIRVIEW TAUPE HC-85 SEMI GLOSS	G.C	G.C	G.C	DINING AREA WALLS	G.C. TO SUBMIT SAMPLE
WALL	PANELS/ LAMINA	ATES:					
	LAB DESIGN /	LAMINATE	G.C	G.C	G.C	CABINETS, WALLS	SUBMIT SAMPLES FOR APPROVAL
	LANASTER WOOD INTERIOR ARTS / 3100 VRN MALLORCA	LAMINATE	G.C	G.C	G.C	WAINSCOT	SUBMIT SAMPLES
-	WALNUT						FOR APPROVAL
M	BLACK METAL	BLACK POWDERCOATED METAL	BY MILLWORKER	G.C	G.C	TRIM FOR NEW WAINSCOT	SUBMIT SAMPLES
~							
RESI	NS & ACRYLICS:	1	1				I
@	QUARTZ COUNTERTOP	CAESARSTONE COSMOPOLITAN WHITE / 5130 / # GAUGE	MAGGIE RYBAK 619 623 0536 Magie Rytak@castantoneus.com	MW	MW	SERVICE COUNTER TOP	SUBMIT SAMPLES FOR APPROVAL
WOO	D:						
UPHO	LSTERY:						
(UPHD)	UPHOLSTERY (BROWN)	REID WITLIN LTD PATTERN: CRAZY PINEAPPLE COLOR: CHESTNUT POLYVINYL	SHARLENE MURTAGH 858.449.4546 smurtagh@korcseal.com	MW	MW	BENCH AND BOOTH SEATING	SUBMIT SAMPLES FOR APPROVAL
							FINISH LEGE



Carlile Coatsworth Architects, Inc.



## STUDIO MYID

Mellina Young CID# 6251 NCIDQ cert# 024408 2926 Upas St. San Diego, CA 92104 p. 760. 519. 4446 melissa@studioMYID.com



ENOS RANCHOS - BRADLEY WEST
655 EAST BETTERAVIA RD.
SANTA MARIA, CA 93454

REVISIONS:

 10 APRIL, 2017 PLAN CHECK SUBMITTA

PROJECT: FILE:

DATE:	23	MARCH	201

DRAWN BY: SCALE: #=1'-0" AS NOTED

SHEET TITLE:


FINISH LEGEND

1

I-9.1

UNFORM DRAWING SYSTEM - U.S. NATIONAL CAD STANDARD VERSION 3



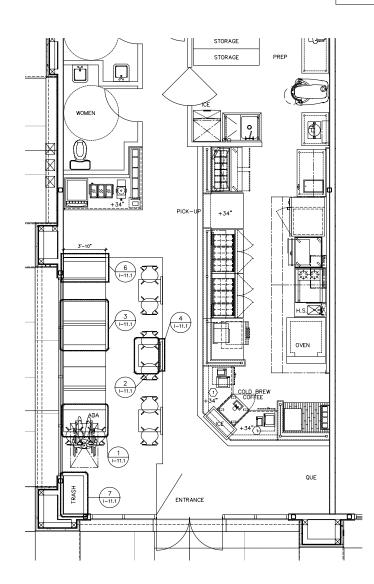


г

L

 SEE DETAIL SHEET 1-11.2 FOR (2) BASKETS, (1) CATERING HOLDERS, & (2) MENU HOLDER
 KEYNOTES

FLOOR PLAN

\*\*\* 3/8"=1'-0\* -

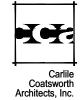


2495 Can Sec

STUDIO MYID

Melless Young CID# 6251 NCIDQ cert# 024408 2926 Upas St. San Diego, CA 92104 p: 760. 519. 4446 melissa@studioMYID.com


Second Floor Irvine, California 92612 Phone: 949.833.1930 Fax: 949.833.1140

٦

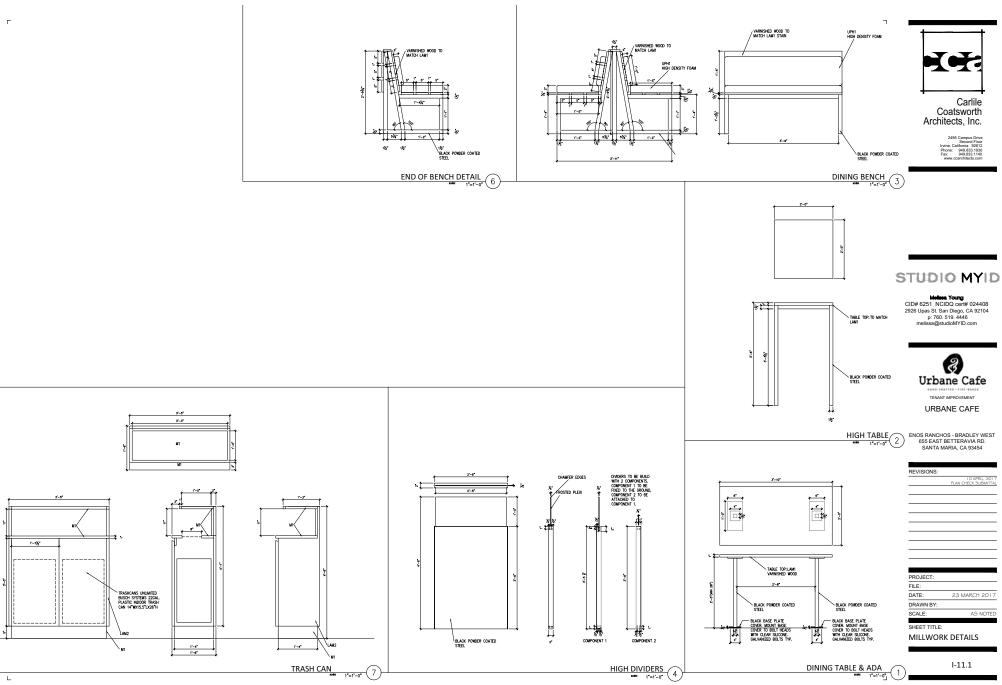


UNFORM DRAWING SYSTEM - U.S. NATIONAL CAD STANDARD VERSION 3.1

.

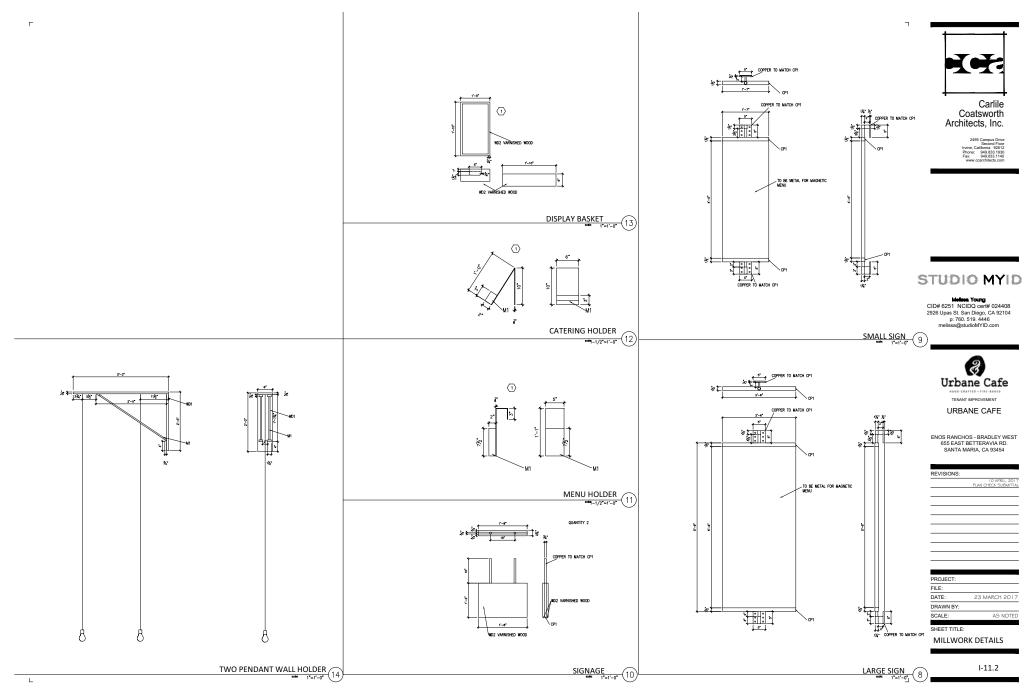

UNFORM DRAWING SYSTEM - U.S. NATIONAL CAD STANDARD VERSION 3.1

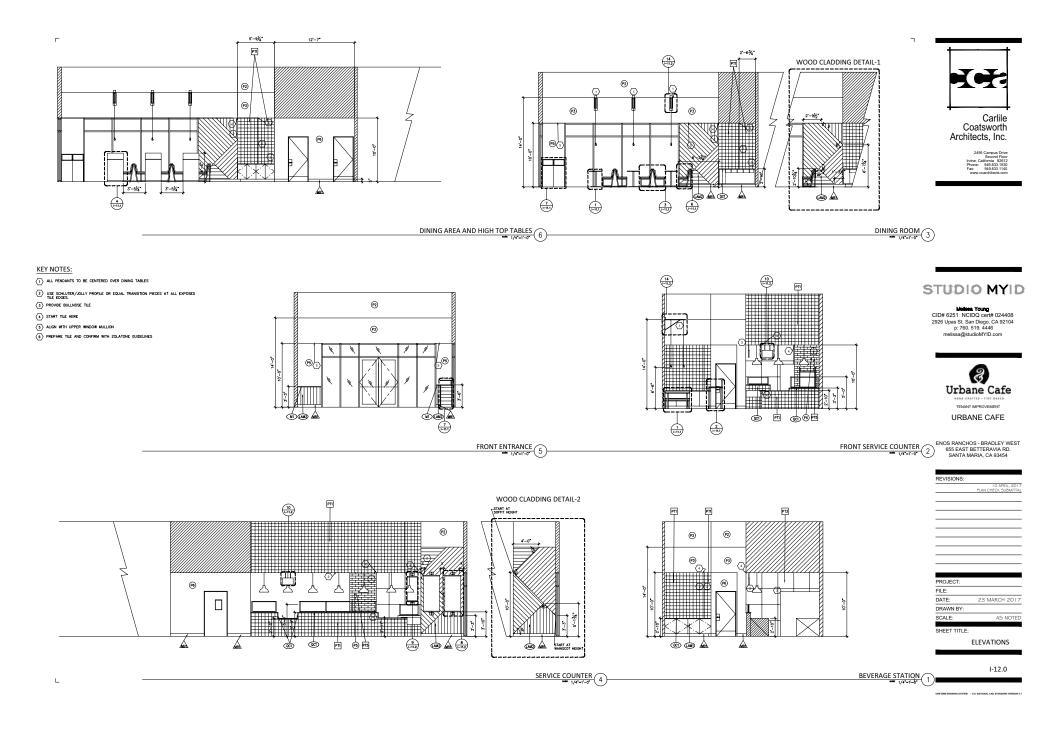

## NOTES:

1. ALL PLUMBING FIXTURES AND ACCESSORY ITEMS SHOULD BE INSTALLED PER ADAAG & 2016 CBC ACCESSIBILITY REQUIREMENTS AND PER MANUFACTURER'S GUIDELINES & RECOMMENDATIONS. 2. CONTRACTORS TO VERIFY ALL QUANTITY OF PLUMBING FIXTURES AND ACCESSORIES.

2016 CALIFORNIA BUILDING CODE (CBC)

L

118-604.8.1.1.1 & 118-604.8.1.1.3 Accessible lavatories. Lavatories required to be accessible shall comply with this subsection. The requirements of this subsection shall apply to lavatory fixtures, vanities and built-in lavatories.


Faucet controls and operating mechanisms shall be operable with one hand in accordance with this chapter and shall not require tight grasping, pinching or twisting of the wrist. The force required to activate controls shall be no greater than 5 lbf[22.2 N], Lever-operated, push-type and electronically controlled mechanisms (preferable) are examples of accepted bedgins. Self-closed tight full bacter tagging and the start for the start of the st


2. Lovatories, when located adjacent to a side wall or partition, shall be a minimum of 18 inches (457 mm) to the centerline of the fixture. All lavatories that are designat to be accessible shall be a minimum 17 inches (432 mm) in inchinotatal depth and monated with the rim or counter edge no higher than 34 inches (646 mm) above the finished for and with vertical dearance measured from the bottmor of the approx or the autorist bottom dege of the busyon of 29 inches(177) mm producing 127 inches) (436 mm) above the finished for and with vertical dearance measured from the bottmor of the approx or the autorist bottom dege of the busyon of 29 inches(177) mm producing 127 inches) (436 mm) at a point located 8 inches (201 mm) back from the front edge. In addition, an minimum 5 inch-high (230 mm) tac dearance muse the provided estending back toxicard the will to additionate no mer tam fain feeds (120 mm) mm and additional the data and additional the data and the start dearance more tam fain effects (120 mm) mm the start high (120 mm) tac dearance muse the provided estending back toxicard the will to additionate no mer tam fain effects (120 mm) mm the start high (120 mm) tac dearance more tam fain effects (120 mm) mm the start high (120 mm) tac dearance more tam fain effects (120 mm) the data will. The tox dearance more tam fain effects (120 mm) tac data will have to dearance more tam fain effects (120 mm) tac dearance more tam fain effects (120 mm) tac data will. The tox dearance more tam fain effects (120 mm) tac data will have to dearance more tam fain effects (120 mm) tam (120 mm) tac dearance more tam fain effects (120 mm) tac dearance more tam fain effects (120 mm) tac data minimum start will have to dearance more tam fain effects (120 mm) tam (120 mm) tac dearance more tam fain effects (120 mm) tam (120 mm) tac dearance more tam fain effects (120 mm) tac dearance more tam fain e


3. A clear floor space 30 inches by 48 inches (762 mm by 1219 mm) complying with Section 11188.4 shall be provided in front of a lavatory to allow forward approach. Such clear floor space shall adjoin or overlap an accessible route and shall extend a maximum of 19 inches (483 mm) into knee and toe space underneath the lavatory. 4. Hot water and drainpipes accessible under lavatories shall be insulated or otherwise covered. There shall be no sharp or abrasive surfaces under lavatories.


1 use schluter/jolly profile or equal transition pieces at all exposed tile edges.

2 SCHLUTER DILEX-AHK COVED AT ALL BASES OF RESTROOM TILE

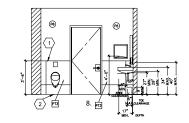

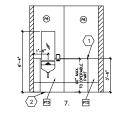


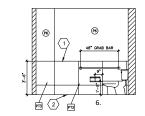

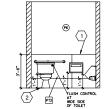

 $\bigoplus_{n \in \mathbb{N}}$ 



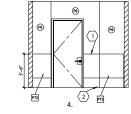

10

2 🖻

**P6** 

 $\langle 1 \rangle$ 

FLUSH CONTROL

MDE SIDE 3.

@

f13 2.

@

PT3 1.

 $\langle 2 \rangle$ 

Ü

WOMEN

2 (1234)

 $\begin{pmatrix} 1 \\ 2 \end{pmatrix}$ P

48" GRAB BAR

2

 $\langle 1 \rangle$ 

RESTROOMS ELEVATIONS \*\*\*\* 3/8\*=1\*=0\*
2

<u>5</u>

**P6** 

RABLE

(1)



Ъ



## STUDIO MYID

Mellesa Young CID# 6251 NCIDQ cert# 024408 2926 Upas St. San Diego, CA 92104 p: 760. 519. 4446 melissa@studioMYID.com



URBANE CAFE

ENOS RANCHOS - BRADLEY WEST 655 EAST BETTERAVIA RD. SANTA MARIA, CA 93454

REVISIONS:

PROJECT:	
FILE:	
DATE:	23 MARCH 2017
DRAWN BY:	
00415	AC NOTED

RESTROOMS ENLARGED

PLAN & ELEVATIONS

1

I-12.2

