ABBREVIATIONS

ABV	ABOVE	JST	JOIST
ACOUS	ACOUSTICAL	JT	JOINT
ACT	ACOUSTICAL CEILING TILE	LAM	LAMINATE
AD	AREA DRAIN	LAV	LAVATORY
ADJ	ADJUSTABLE	LB(S)	POUNDS
AFF	ABOVE FINISH FLOOR	LDG	LANDING
ALT	ALTERNATE	LT	LIGHT
ALUM	ALUMINUM	MAX	MAXIMUM
APPROX	APPROXIMATE	MECH	MECHANICAL
ARCH	ARCHITECT	MEMB	MEMBRANE
B.O. BALC	BOTTOM OF BALCONY	MFR MIN	MANUFACTURER MINIMUM
BD	BOARD	MISC	MISCELLANEOUS
BET	BETWEEN	MO	MASONRY OPENING
BLDG	BUILDNG	MTD	MOUNTED
BLKG	BLOCKING	MTL	METAL
BLW	BELOW	N	NORTH
BM	BEAM	NIC	NOT IN CONTRACT
BOT	BOTTOM	NO	NUMBER
BRKT	BRACKET	NOM	NOMINAL
BULKHD	BULKHEAD	NTS	NOT TO SCALE
BUR	BUILT UP ROOF	O.P.	OVERFLOW PIPE
C.G. CAB	CORNER GUARD CABINET	OA OC	OVERALL ON CENTER
CALK	CAULKING	OD	OUTSIDE DIAMETER
CEM	CEMENT	OFF	OFFICE
CER	CERAMIC	OH	OPPOSITE HAND
CJ	CONTROL JOINT	OPG	OPENING
CLG	CEILING	OPP	OPPOSITE
CLOS	CLOSET	PART	PARTITION
CLR	CLEAR	PERM	PERIMETER
CO	CASED OPENING	PG	PAINT GRADE
COL	COLUMN	PLAM	PLASTIC LAMINATE
CONC	CONCRETE	PLAS	PLASTER
CONT	CONTINUOUS CARPET	PLYWD PR	PLYWOOD PAIR
CT	CERAMIC TILE	PT	PAINT
CTR	CENTER	PTD	PAINTED
DBL	DOUBLE	R	RISER
DET	DETAIL	RAD	RADIUS
DIA	DIAMETER	RCP	REFLECTED CEILING PLAN
DIM	DIMENSION	RD	ROOF DRAIN
DN	DOWN	RE	REFER
DR	DOOR	REF	REFRIGERATOR
DS	DOWN SPOUT	REINF REQD	REINFORCED REQUIRED
DW DWG	DISHWASHER DRAWING	REQU	RESILIENT
E	EAST	RM	ROOM
EA	EACH	RO	ROUGH OPENING
EIFS	EXTERIOR INSULATION & FINISH	RTU	ROOF TOP UNIT (MECH)
	SYSTEM	S	SOUTH
ELEC	ELECTRIC	SAFB	SOUND ATTENUATION FIBER
ELEV	ELEVATION	00	BATT
EMER ENCL	EMERGENCY ENCLOSURE	SC SCHED	SCUPPER SCHEDULE
EOS	EDGE OF SLAB	SEAL	SEALANT
EQ	EQUAL	SECT	SECTION
EQUIP	EQUIPMENT	SF	SQUARE FOOT
ETR	EXISTING TO REMAIN	SHT	SHEET
EW	EACH WAY	SIM	SIMILAR
EXP. JT.	EXPANSION JOINT	SPEC	SPECIFICATION
EXST	EXISTING	SQ	SQURE
F.O.	FACE OF	SS	STAINLESS STEEL
FA FAP	FIRE ALARM FIRE ANNUNCIATOR PANEL	STD STL	STANDARD STEEL
FD	FLOOR DRAIN	STOR	STORAGE
FDN	FOUNDATION	STRUCT	STRUCTURAL
FE	FIRE EXTINGUISHER	SUSP	SUPSPENDED
FEC	FIRE EXTINGUISHER PANEL	SYM	SYMMMETRICAL
FG	FINISH GROUP	Т	TREAD
FH	FIRE HYDRANT	T&G	TONGUE & GROOVE
FHC	FIRE HOSE CABINET	TEL	TELEPHONE
FIN	FINISH	TER	TERRAZZO
FLR FLUOR	FLOOR ELOURESCENT	THK THR	THICK THRESHOLD
FLUOR	FLOURESCENT FOOT OR FEET	TO	TOP OF
FUR	FURRING	TYP	TYPICAL
GAL	GALLON	UC	UNDERCUT
GALV	GALVANIZED	UNFIN	UNFINISHED
GB	GRAB BAR	UNO	ULNESS NOTED OTHERWISE
GC	GENERAL CONTRACTOR	UON	UNLESS OTHERWISE NOTED
GL	GLASS	UTIL	UTILITY
GND	GROUND	VCT	VINYL COMPOSITION TILE
GWB	GYPSUM BOARD	VERT	VERTICAL VERTICAL
GYP H.W.H.	GYPSUM HOT WATER HEATER	VIF VTR	VERIFY IN FIELD VENT TERMINATION PIPE
. I. v V . □.	INVESTIGATION	V 1 🗅	

McCrea Ranch Visitor Center Thousand Oaks, California

GENERAL NOTES

APPLICABLE CODES AND STANDARDS: 2001 CALIFORNIA BUILDING CODE AND ITS APPENDICES AND STANDARDS. 2001 CALIFORNIA PLUMBING CODE AND ITS APPENDICES AND STANDARDS. 2001 CALIFORNIA MECHANICAL CODE AND ITS APPENDICES AND STANDARDS. 2001 CALIFORNIA FIRE CODE AND ITS APPENDICES AND STANDARDS. 2004 CALIFORNIA ELECTRICAL CODE AND ITS APPENDICES AND STANDARDS. 2005 CALIFORNIA BUILDING ENERGY EFFICIENCY STANDARDS.

ALL WORK DESCRIBED IN THE DRAWINGS SHALL BE VERIFIED FOR DIMENSION GRADE, EXTENT AND COMPATIBILITY WITH EXISTING SITE CONDITIONS. ANY DISCREPANCIES AND UNEXPECTED CONDITIONS THAT AFFECT OR CHANGE THI WORK DESCRIBED IN THE CONTRACT DOCUMENTS SHALL BE BROUGHT TO THE ARCHITECT'S ATTENTION IMMEDIATELY. DO NOT PROCEED WITH THE WORK IN THE AREA OF DISCREPANCIES UNTIL ALL SUCH DISCREPANCIES ARE RESOLVED. IF THE CONTRACTOR CHOOSES TO DO SO, HE/SHE SHALL BE

OMISSIONS MADE IN THESE DRAWINGS AND SPECIFICATIONS OR THE MIS-DESCRIPTION OF THE WORK WHICH IS MANIFESTLY NECESSARY TO CARRY OUT THE INTENT OF THE DRAWINGS AND SPECIFICATIONS. OR WHICH IS CUSTOMARILY PERFORMED SHALL NOT RELIEVE THE CONTRACTOR FROM PERFORMING SUCH OMITTED OR DESCRIBED DETAILS OF THE WORK AS IF FULLY AND COMPLETELY SET FORTH AND DESCRIBED IN THE DRAWINGS AND

DIMENSIONS SHOWN SHALL TAKE PRECEDENCE OVER DRAWING SCALE OR PROPORTION. LARGER SCALE DRAWINGS SHALL TAKE PRECEDENCE OVER SMALLER SCALE DRAWINGS.

IN THE EVENT OF THE UNFORESEEN ENCOUNTER OF MATERIALS SUSPECTED TO BE OF AN ARCHAEOLOGICAL OR PALEONTOLOGICAL NATURE, ALL GRADING AND EXCAVATION SHALL CEASE IN THE IMMEDIATE AREA AND THE APPROPRIATE AUTHORITIES ARE TO BE NOTIFIED BY THE CONTRACTOR. THE FIND SHALL BE LEFT UNTOUCHED UNTIL AN EVALUATION BY A QUALIFIED ARCHAEOLOGIST OR PALEONTOLOGIST IS MADE.

CONTRACTOR IS TO BE RESPONSIBLE FOR BEING FAMILIAR WITH THESE DOCUMENTS INCLUDING ALL CONTRACT REQUIREMENTS. GRADING PLANS, DRAINAGE IMPROVEMENTS, ROAD AND ACCESS

REQUIREMENTS AND ENVIRONMENTAL HEALTH CONSIDERATIONS SHALL COMPLY WITH ALL LOCAL ORDINANCES. CONTRACTOR TO REVIEW TITLE 24 DOCUMENTATION TO PROVIDE A BUILDING THAT MEETS AND EXCEEDS THE BUILDING ENERGY AND EFFICIENCY AND PERFORMANCE AS REQUIRED BY ASHRA/IESNA 90.1-1999 OR THE LOCAL

ENERGY CODE, WHICHEVER IS MORE STRINGENT. 9. A FINAL COMPACTION REPORT MUST BE COMPLETED PRIOR TO BUILDING

PROJECT DIRECTORY

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THOMA ENGINEERING

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CAMROSA WATER DISTRICT ADDRESS:

7385 EAST SANTA ROSA ROAD CAMARILLO, CA 93010

ADDRESS: 3589 FOOTHILL DRIVE

PHONE: (805) 494-7065 **FAX:** (805) 494-7008 **CONTACT:** CONRAD REYNADO

OXNARD, CA 93031 CONTACT:

TELEPHONE SERVICE: AT&T

PHONE: (805) 583-6634 **FAX: CONTACT:** JOE GARCIA

PROJECT SCOPE

1. CONSTRUCTION OF NEW VISITOR CENTER BUILDING. 2. EXTERIOR IMPROVEMENTS FOR EXISTING CARETAKER BUILDING.

3. RELATED SITE IMPROVEMENTS AND UNDERGROUND UTILITIES.

DEFERRED SUBMITTALS

PHONE: (805) 482-8063 **CONTACT: CHRIS SMITH**

ELECTRICAL SERVICE:

SOUTHERN CALIFORNIA EDISON

THOUSAND OAKS, CA 91365

ADDRESS: 1081 OXNARD AVE. **PHONE:** 1-800-300-9379 **FAX:**

ADDRESS:

1. PRE-MANUFACTURED ROOF TRUSSES.

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GENERAL NOTES

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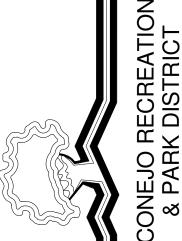
M3 MECHANICAL ROOF PLAN MECHANICAL FLOOR PLAN MECHANICAL: 6


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Patrick L. Blote Expires 3/31/11

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D

CENTER

RANCH VISITOR (4500 N. MOORPARK RD. THOUSAND OAKS, CALIFORNIA

MCCREA

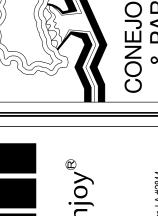SHE

NO. REVISION 1 PLAN CHECK RESUBMITTAL 05/14/10 PROJECT MANAGER CHECKED BY DATE FEBRUARY 01, 2010 PROJECT NUMBER

ELEVATION \ A101 DETAIL REFERENCE

H.W.H. HOT WATER HEATER

HARDWOOD

HARDWARE

HOLLOW METAI

INNER DIAMETER

INCANDESCENT

INSULATION

SYMBOLS

DESIGNATION

INTERIOR

JANITOR


HORIZONTAL

HOUR

HEIGHT

HDWD

INSUL

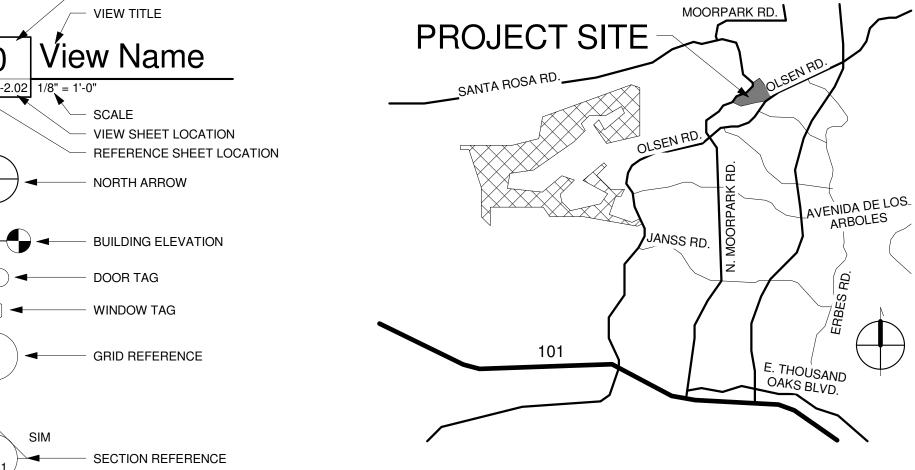

VICINITY MAP

VENT TERMINATION PIPE

VINYL WALL COVERING

WITHOUT

WINDOW

WSCT

- CENTER LINE

REVISION

WATERCLOSET

WATERPROOF

WETSTACK

WAINSCOT

WEIGHT

FIRE DEPARTMENT CONDITIONS

- 1. ACCESS ROAD WIDTH-AN ONSITE ACCESS ROAD WIDTH OF 20 FEET AND OFF-STREET PARKING SHALL BE PROVIDED. (R-1, R-2, I OCCUPANCY AND COMMERCIAL / INDUSTRIAL).
- 2. CONSTRUCTION ACCESS-PRIOR TO COMBUSTIBLE CONSTRUCTION, ALL UTILITIES LOCATED WITHIN THE ACCESS ROAD AND THE FIRST LIFT OF THE ACCESS ROAD PAVEMENT SHALL BE INSTALLED. A MINIMUM 20 FOOT CLEAR WIDTH SHALL REMAIN FREE OF OBSTRUCTION DURING ANY CONSTRUCTION ACTIVITIES WITHIN THE DEVELOPMENT ONCE COMBUSTIBLE CONSTRUCTION STARTS.
- TURNING RADIUS-THE ACCESS ROAD SHALL BE OF SUFFICIENT WIDTH TO ALLOW FOR A 40 FOOT OUTSIDE TURNING RADIUS AT ALL TURNS IN THE ROAD.
- VERTICAL CLEARANCE-ALL ACCESS ROADS / DRIVEWAYS SHALL HAVE A
- MINIMUM VERTICAL CLEARANCE OF 13 FEET 6 INCHES (13' 6").

 5. TURNAROUNDS-APPROVED TURNAROUND AREAS FOR FIRE APPARATUS SHALL BE PROVIDED WHEN DEAD-END FIRE DEPARTMENT ACCESS ROADS / DRIVEWAYS EXCEED 150 FEET. TURNAROUND AREAS SHALL NOT EXCEED A 5% CROSS SLOPE IN ANY DIRECTION AND SHALL BE LOCATED WITHIN 150 FEET OF THE END OF THE ACCESS ROAD / DRIVEWAY. TURNAROUND AREAS SHALL NOT BE USED FOR PARKING AND SHALL BE KEPT FREE OF OBSTRUCTIONS AT ALL TIMES. TURNAROUND AREAS SHALL BE POSTED AS
- FIRE LANES IN ACCORDANCE WITH FIRE DISTRICT FIRE LANE STANDARDS.

 6. ACCESS ROAD LOCATION-THE ACCESS / DRIVEWAY SHALL BE EXTENDED TO WITHIN 150 FEET OF ALL PORTIONS OF THE EXTERIOR WALLS OF THE FIRST STORY OF ANY BUILDING AND SHALL BE IN ACCORDANCE WITH FIRE DISTRICT ACCESS STANDARDS. WHERE THE ACCESS ROADWAY CANNOT BE PROVIDED, APPROVED FIRE PROTECTION SYSTEM OR SYSTEMS SHALL BE INSTALLED AS REQUIRED AND ACCEPTABLE TO THE FIRE DISTRICT.
- 7. ACCESS ROAD CERTIFICATION-THE ACCESS ROAD(S)/DRIVEWAY(S) SHALL BE CERTIFIED BY A REGISTERED CIVIL ENGINEER AS HAVING AN ALL WEATHER SURFACE IN CONFORMANCE WITH PUBLIC WORKS AND / OR FIRE DISTRICT STANDARDS. THIS CERTIFICATION SHALL BE SUBMITTED TO THE FIRE DISTRICT FOR REVIEW AND APPROVAL PRIOR TO OCCUPANCY.
- 8. FIRE LANES-PRIOR TO CONSTRUCTION THE APPLICANT SHALL SUBMIT TWO
 (2) SITE PLANS TO THE FIRE DISTRICT FOR APPROVAL OF THE LOCATION OF
 FIRE LANES. PRIOR TO OCCUPANCY, ALL FIRE LANES SHALL BE POSTED "NO
 PARKING-FIRE LANE-TOW AWAY" IN ACCORDANCE WITH CALIFORNIA VEHICLE
 CODE, THE INTERNATIONAL FIRE CODE AND CURRENT VCFPD FIRE LANE
 STANDARDS. ALL SIGNS AND OR FIRE LANE MARKINGS SHALL BE WITHIN
 RECORDED ACCESS EASEMENTS.
- 9. ACCESS ROAD GATES-ANY GATES TO CONTROL VEHICLE ACCESS ARE TO BE LOCATED TO ALLOW A VEHICLE WAITING FOR ENTRANCE TO BE COMPLETELY OFF THE INTERSECTING ROADWAY. A MINIMUM CLEAR OPEN WIDTH OF 15 FEET. IF GATES ARE TO BE LOCKED, A KNOX SYSTEM SHALL BE INSTALLED. THE METHOD OF GATE CONTROL, INCLUDING OPERATION DURING POWER FAILURE (BATTERY BACK-UP), SHALL BE SUBJECT TO REVIEW BY THE FIRE PREVENTION DIVISION. GATE PLAN DETAILS SHALL BE SUBMITTED TO THE FIRE DISTRICT FOR APPROVAL PRIOR TO INSTALLATION. A FINAL ACCEPTANCE INSPECTION BY THE FIRE DISTRICT IS REQUIRED PRIOR TO PLACING ANY GATE INTO SERVICE.
- 10. WALKWAYS-APPROVED WALKWAYS SHALL BE PROVIDED FROM ALL BUILDING OPENINGS TO THE PUBLIC WAY OR FIRE DEPARTMENT ACCESS ROAD / DRIVEWAY.
- 11. BUILDING LOCATION ON PROPERTY-BUILDINGS HOUSING GROUP A OCCUPANCIES SHALL FRONT DIRECTLY ON OR DISCHARGE TO A PUBLIC STREET NOT LESS THAN 20 FEET IN WIDTH. THE EXIT DISCHARGE TO THE PUBLIC STREET SHALL BE A MINIMUM 20 FOOT WIDE RIGHT OF WAY, UNOBSTRUCTED AND MAINTAINED ONLY AS EXIT DISCHARGE TO THE PUBLIC STREET. THE MAIN ENTRANCE TO THE BUILDING SHALL BE LOCATED ON A PUBLIC STREET OR ON THE EXIT DISCHARGE. REFERENCE CALIFORNIA BUILDING CODE REQUIREMENTS. NOTE: FIRE DISTRICT REQUIRES MINIMUM 25 FOOT ACCESS ROADS.
- 12. ADDRESS NUMBERS (COMMERCIAL, INDUSTRIAL, MULTI-FAMILY BUILDINGS)-BUILDING ADDRESS NUMBERS, A MINIMUM OF 8 INCHES (8") HIGH, SHALL BE INSTALLED PRIOR TO OCCUPANCY, SHALL BE OF CONTRASTING COLOR TO THE BACKGROUND, AND SHALL BE READILY VISIBLE AT NIGHT. BRASS OR GOLD PLATED NUMBERS SHALL NOT BE USED. WHERE STRUCTURES ARE SET BACK MORE THAN 150 FEET FROM THE STREET, LARGER NUMBERS WILL BE REQUIRED SO THAT THEY ARE DISTINGUISHABLE FROM THE STREET. IN THE EVENT A STRUCTURE(S) IS NOT VISIBLE FROM THE STREET, THE ADDRESS NUMBER(S) SHALL BE POSTED ADJACENT TO THE DRIVEWAY ENTRANCE ON AN ELEVATED POST. INDIVIDUAL UNIT NUMBERS SHALL BE A MINIMUM OF 4 INCHES IN HEIGHT AND SHALL BE POSTED AT THE FRONT AND REAR ENTRANCE TO EACH UNIT. ADDITIONAL ADDRESS DIRECTIONAL SIGNS MAY BE REQUIRED AT COMMON BUILDING ENTRANCES AND STAIRWAYS.
- 13. FIRE HYDRANT PLAN-PRIOR TO CONSTRUCTION, THE APPLICANT SHALL SUBMIT PLANS TO THE FIRE DISTRICT FOR PLACEMENT OF FIRE HYDRANTS. ON PLANS, SHOW EXISTING HYDRANTS WITHIN 300 FEET OF THE DEVELOPMENT. INDICATE THE TYPE OF HYDRANT, NUMBER AND SIZE OF
- 14. FIRE HYDRANT(S) REQUIRED-FIRE HYDRANT(S) SHALL BE PROVIDED IN ACCORDANCE WITH CURRENT ADOPTED EDITION OF THE INTERNATIONAL FIRE CODE, APPENDIX C AND ADOPTED AMENDMENTS. ON-SITE FIRE HYDRANTS MAY BE REQUIRED AS DETERMINED BY THE FIRE DISTRICT.
- 15. FIRE HYDRANT DESIGN-FIRE HYDRANTS SHALL BE INSTALLED AND IN SERVICE PRIOR TO COMBUSTIBLE CONSTRUCTION AND SHALL CONFORM TO THE MINIMUM STANDARD OF THE CITY OF THOUSAND OAKS WATER WORKS MANUAL AND THE FOLLOWING.
- 15A. EACH HYDRANT SHALL BE A 6 INCH WET BARREL DESIGN AND SHALL HAVE
- ONE 4 INCH AND TWO 2 ½ INCH OUTLET(S).

 15B. THE REQUIRED FIRE FLOW SHALL BE ACHIEVED AT NO LESS THAN 20-PSI
- RESIDUAL PRESSURE.

 15C. FIRE HYDRANTS SHALL BE SPACED 300 FEET ON CENTER AND SO LOCATED THAT NO STRUCTURE WILL BE FARTHER THAN 150 FEET FROM ANY ONE
- 15C. FIRE HYDRANTS SHALL BE SET BACK IN FROM THE CURB FACE 24 INCHES ON CENTER.
- 15D. FIRE HYDRANTS SHALL BE SET BACK IN FROM THE CURB FACE 24 INCHES ON CENTER.
- 15E. NO OBSTRUCTIONS, INCLUDING WALLS, TREES, LIGHT AND SIGN POSTS,
- METER, SHALL BE PLACED WITHIN THREE (3) FEET OF ANY HYDRANT.

 15F. A CONCRETE PAD SHALL BE INSTALLED EXTENDING 18 INCHES OUT FROM
- THE FIRE HYDRANT.

 15G. GROUND CLEARANCE TO THE LOWEST OPERATING NUT SHALL BE BETWEEN 18 TO 24 INCHES.
- 16. FIRE HYDRANT INSTALLATION-PRIOR TO COMBUSTIBLE CONSTRUCTION ON ANY PARCEL, A FIRE HYDRANT CAPABLE OF PROVIDING THE REQUIRED FIRE FLOW AND DURATION SHALL BE INSTALLED AND IN SERVICE ALONG THE ACCESS ROAD / DRIVEWAY AT A LOCATION APPROVED BY THE FIRE DISTRICT, BUT NO FURTHER THAN 250 FEET FROM THE BUILDING SITE. THE OWNER OF THE COMBUSTIBLE CONSTRUCTION IS RESPONSIBLE FOR THE COST OF THIS INSTALLATION.
- INSTALLATION.

 17. HYDRANT LOCATION MARKERS-PRIOR TO OCCUPANCY OF ANY STRUCTURE, BLUE REFLECTIVE HYDRANT LOCATION MARKERS SHALL BE PLACED ON THE ACCESS ROADS IN ACCORDANCE WITH FIRE DISTRICT STANDARDS. IF THE FINAL ASPHALT CAP IS NOT IN PLACE AT TIME OF OCCUPANCY, HYDRANT LOCATION MARKERS SHALL STILL BE INSTALLED AND SHALL BE REPLACED WHEN THE FINAL ASPHALT CAP IN COMPLETED.
- WHEN THE FINAL ASPHALT CAP IN COMPLETED.

 18. FIRE FLOW-THE MINIMUM FIRE FLOW REQUIRED SHALL BE DETERMINED AS SPECIFIED BY THE CURRENT ADOPTED EDITION OF THE FIRE CODE APPENDIX B WITH ADOPTED AMENDMENTS AND THE APPLICABLE WATER MANUAL FOR THE JURISDICTION (WITH EVER IS MORE RESTRICTIVE). GIVEN THE PRESENT PLANS AND INFORMATION, THE REQUIRED FIRE FLOW IS APPROXIMATELY 1,250 GALLONS PER MINUTE AT 20 PSI FOR MINIMUM 2 HOUR DURATION. A MINIMUM FLOW OF 1,250 GALLONS PER MINUTE SHALL BE PROVIDED FROM ANY ONE HYDRANT. A MINIMUM FIRE FLOW OF 1000 GPM SHALL BE PROVIDED FROM EACH HYDRANT WHEN MULTIPLE HYDRANTS ARE FLOWING AT THE SAME TIME. THE APPLICANT SHALL VERIFY THAT THE WATER PURVEYOR CAN PROVIDE THE REQUIRED VOLUME AND DURATION AT THE PROJECT PRIOR TO OBTAINING A BUILDING PERMIT.
- 19. FIRE SPRINKLERS-ALL STRUCTURES SHALL BE PROVIDED WITH AN AUTOMATIC FIRE SPRINKLER SYSTEM IN ACCORDANCE WITH CURRENT VCFPD ORDINANCE AT TIME OF BUILDING PERMIT APPLICATION.

- 20. FIRE PROTECTION SYSTEM PLANS-PLANS FOR ALL FIRE PROTECTION SYSTEMS (SPRINKLERS, DRY CHEMICAL, HOOD SYSTEMS, ETC.) SHALL BE SUBMITTED, WITH PAYMENT FOR PLAN CHECK, TO THE FIRE DISTRICT FOR REVIEW AND APPROVAL PRIOR TO INSTALLATION. NOTE: FIRE SPRINKLER SYSTEMS WITH 20 OR MORE HEADS SHALL BE SUPERVISED BY A FIRE ALARM SYSTEM IN ACCORDANCE WITH FIRE DISTRICT REQUIREMENTS.
- 21. FIRE ALARM PLANS-PLANS FOR ANY FIRE ALARM SYSTEM SHALL BE SUBMITTED, WITH PAYMENT FOR PLAN CHECK, TO THE FIRE DISTRICT FOR REVIEW AND APPROVAL PRIOR TO INSTALLATION.
- 22. BUILDING PLAN REVIEW-BUILDING PLANS OF ALL A, E, I, H, R-1 OR R-2 OCCUPANCIES SHALL BE SUBMITTED, WITH PAYMENT FOR PLAN CHECK, TO THE FIRE DISTRICT FOR REVIEW AND APPROVAL PRIOR TO OBTAINING A BUILDING PERMIT.
- 23. FIRE EXTINGUISHERS-FIRE EXTINGUISHERS SHALL BE INSTALLED IN ACCORDANCE WITH THE INTERNATIONAL FIRE CODE. THE PLACEMENT OF EXTINGUISHERS SHALL BE SUBJECT TO REVIEW BY THE FIRE DISTRICT.
- 24. TRASH DUMPSTER LOCATIONS-COMMERCIAL TRASH DUMPSTERS AND CONTAINERS WITH AN INDIVIDUAL CAPACITY OF 1.5 CUBIC YARDS OR GREATER SHALL NOT BE STORED OR PLACED WITHIN 5 FEET OF OPENINGS, COMBUSTIBLE WALLS, OR COMBUSTIBLE ROOF EAVE LINES UNLESS PROTECTED BY APPROVED AUTOMATIC FIRE SPRINKLERS.
- 25. HAZARDOUS WATERSHED FIRE AREA-THIS PROJECT IS LOCATED IN A HAZARDOUS WATERSHED FIRE AREA AND ALL STRUCTURES SHALL MEET HAZARDOUS FIRE AREA BUILDING CODE REQUIREMENTS. CONTACT THE BUILDING DEPARTMENT FOR REQUIREMENTS.
- BUILDING DEPARTMENT FOR REQUIREMENTS.

 26. HAZARD ABATEMENT-ALL GRASS OR BRUSH EXPOSING ANY STRUCTURE(S)
 TO FIRE HAZARDS SHALL BE CLEARED FOR A DISTANCE OF 100 FEET PRIOR
 TO CONSTRUCTION OF ANY STRUCTURE AND SHALL BE MAINTAINED IN
 ACCORDANCE WITH VCFPD ORDINANCE.
- 27. SPARK ARRESTER-AN APPROVED SPARK ARRESTER SHALL BE INSTALLED ON THE CHIMNEY OF ANY STRUCTURE(S).
 28. FIRE DEPARTMENT CLEARANCE-APPLICANT SHALL OBTAIN VCFD FORM #126
- 28. FIRE DEPARTMENT CLEARANCE-APPLICANT SHALL OBTAIN VCFD FORM #126
 "REQUIREMENTS FOR CONSTRUCTION" PRIOR TO OBTAINING A BUILDING
 PERMIT FOR ANY NEW STRUCTURES OR ADDITIONS TO EXISTING
 STRUCTURES.
- 29. FIRE CODE PERMITS-APPLICANT AND / OR TENANT SHALL OBTAIN ALL APPLICABLE INTERNATIONAL FIRE CODE (IFC) PERMITS PRIOR TO OCCUPANCY OR USE OF ANY SYSTEM OR ITEM REQUIRING AN IFC PERMIT.



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RANCH

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DEPARTMENT ONDITIONS

NO. REVISION DATE


PROJECT MANAGER


DRAWN BY CHECKED BY SDR PLB
DATE

FEBRUARY 01, 2010

PROJECT NUMBER

1402505

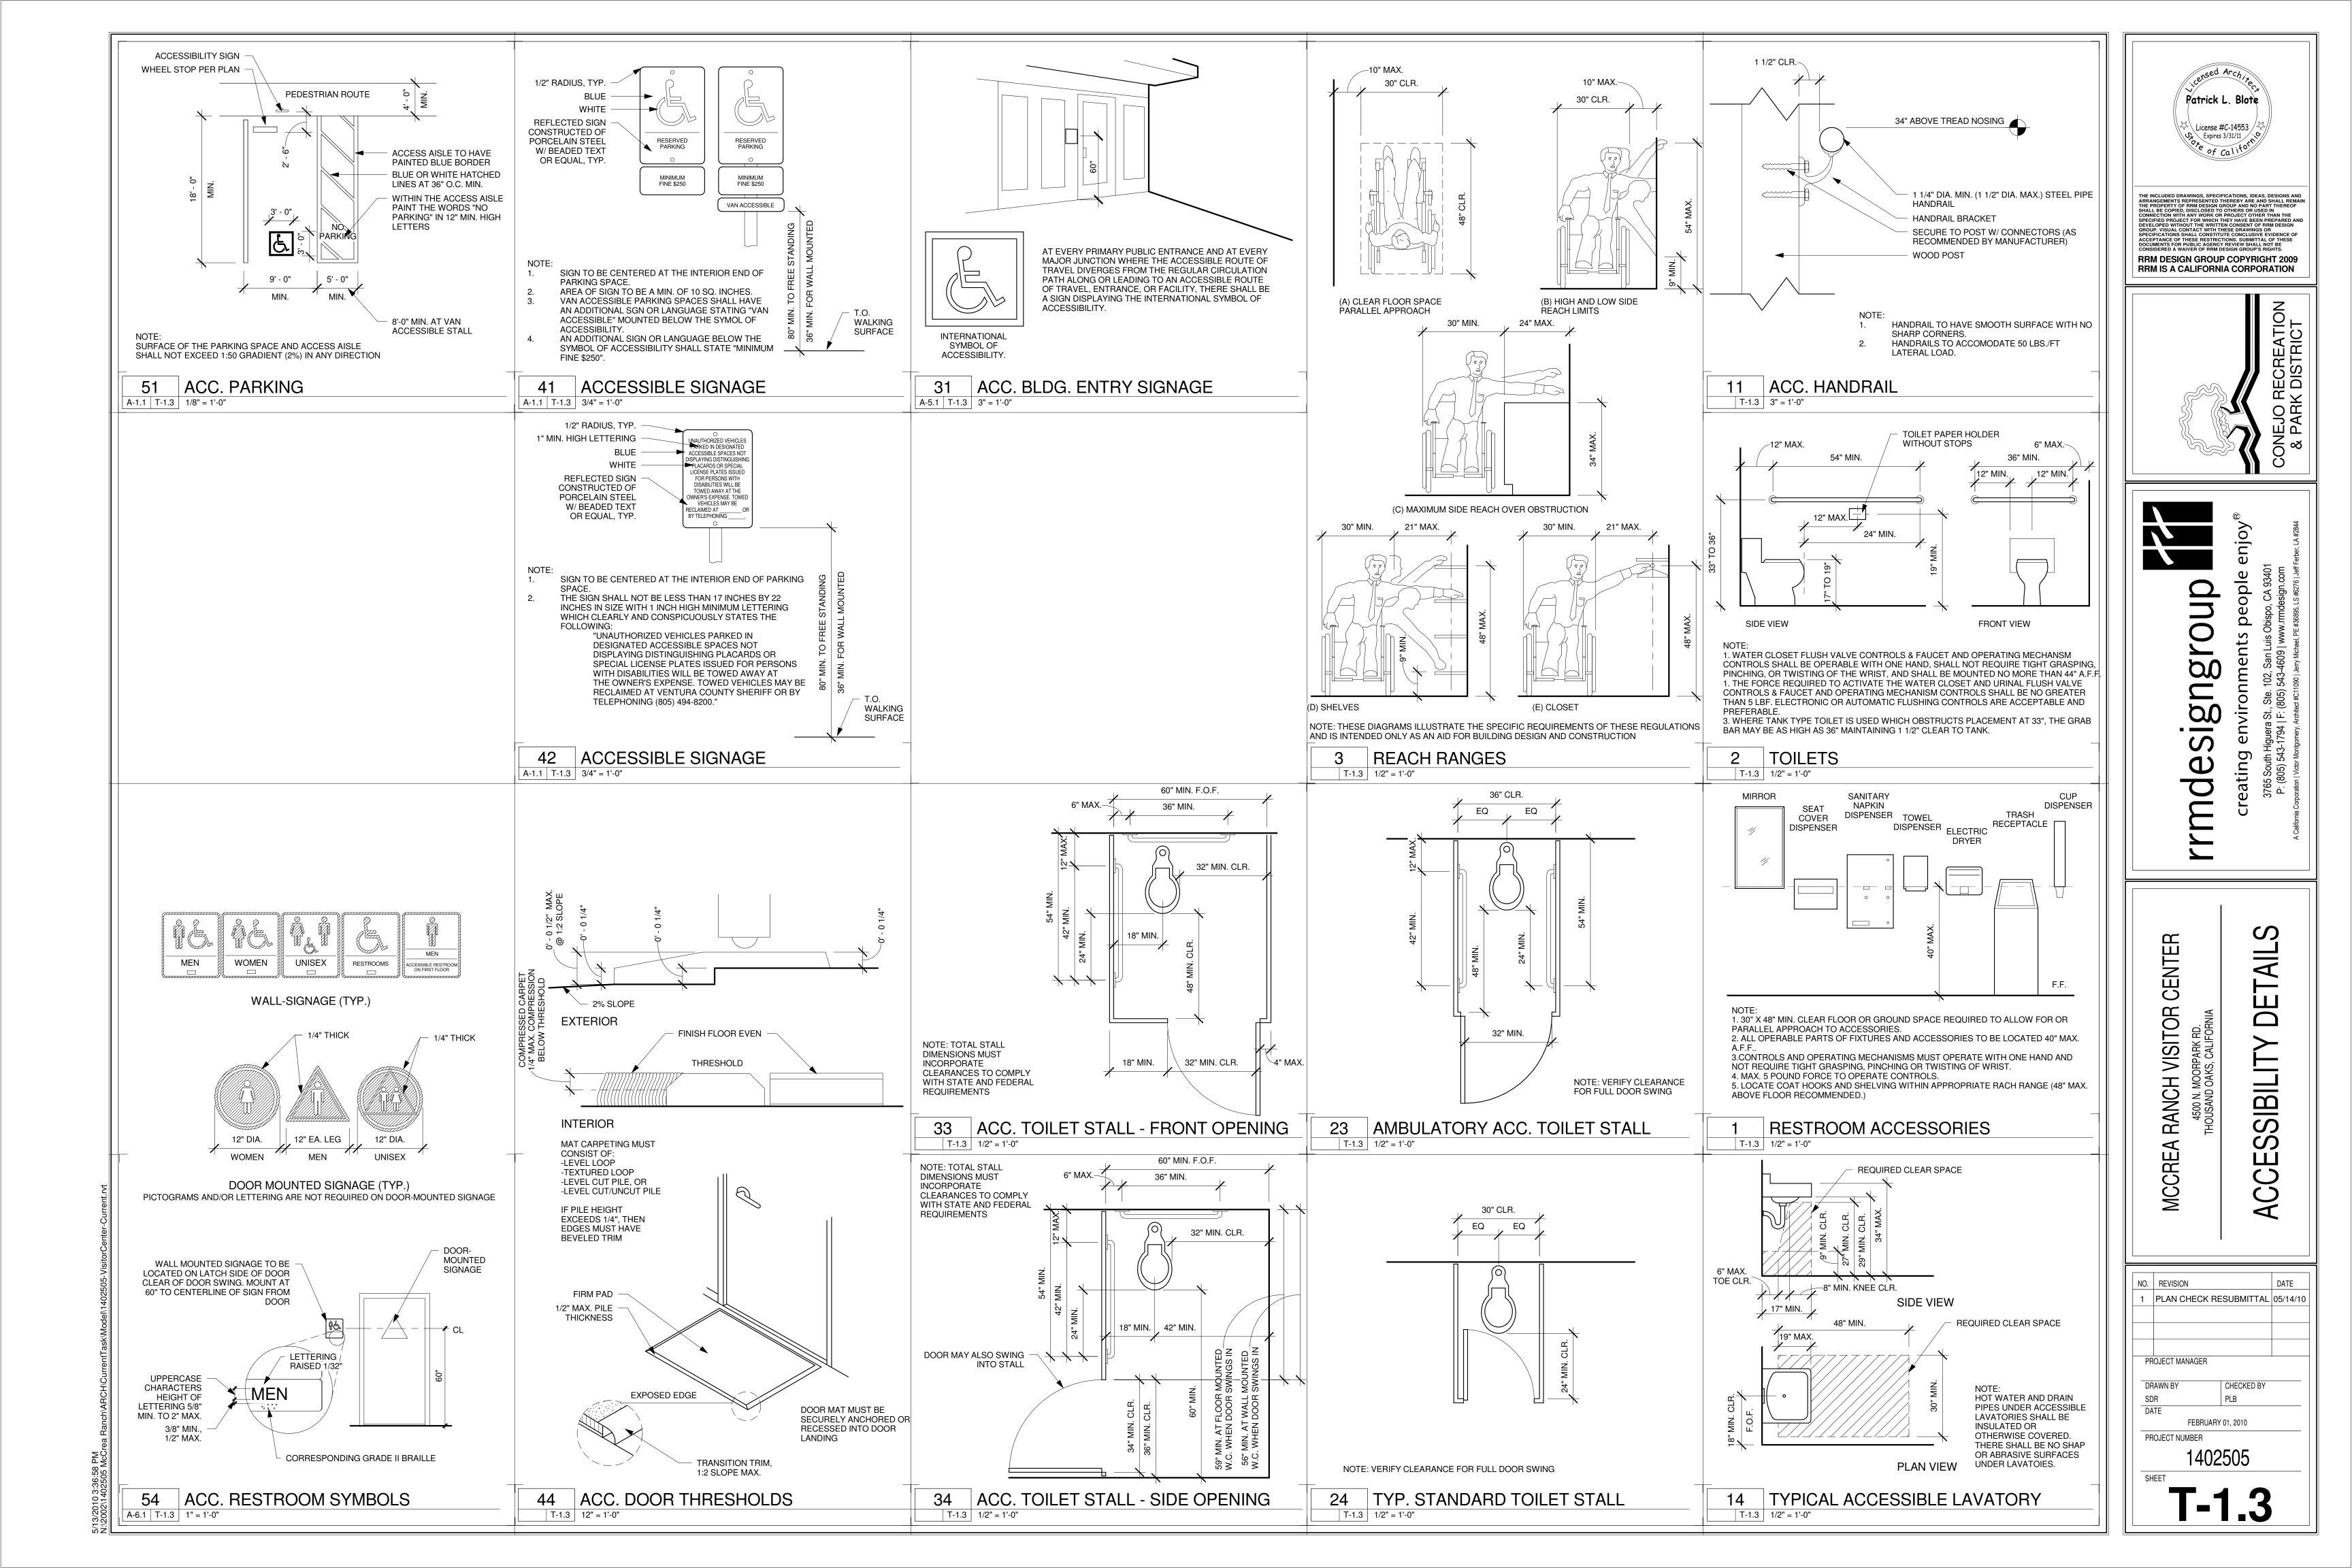

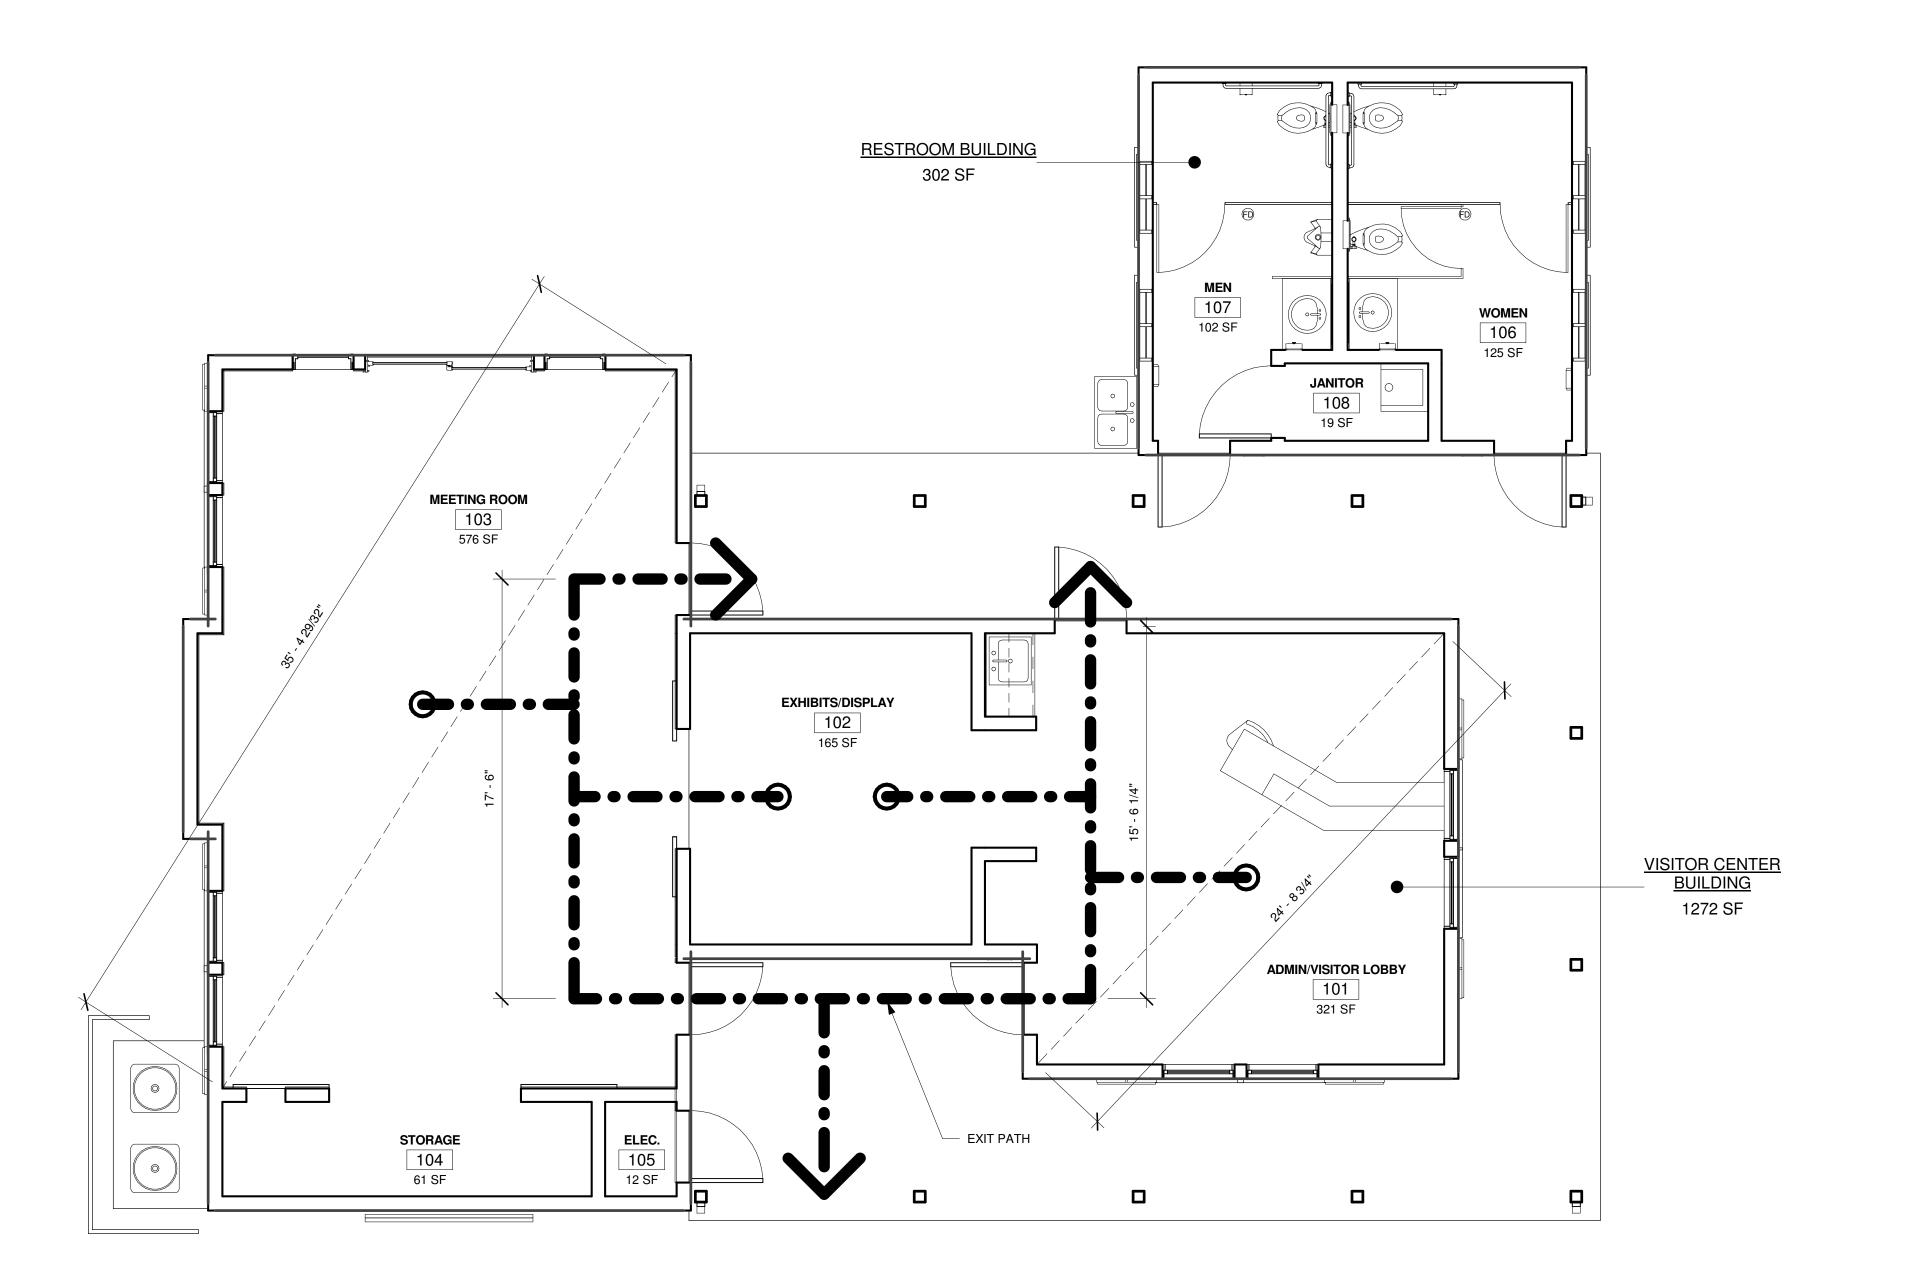

CODE ANALYSIS

CODE INTERPRETATION		
OCCUPANCY	A-4	303.1
CONSTRUCTION TYPE	TYPE V-B	T-601
ALLOWABLE BUILDING HEIGHT	40 FT	T-503
ALLOWABLE BUILDING AREA	6,000 SF	T-503
ALLOWABLE NUMBER OF STORIES	1	T-503
FIRE SPRINKER INCREASE	N/A	504.2
FIRE SPRINKLER AREA INCREASE	N/A	506.3
FIRE RESISTANCE RATING	0	T-601
PROTECTED EXTERIOR OPENINGS	N/A	T-704.8
MAX TRAVEL DISTANCE WITHIN A STORY	200 FT	T-1016
COMMON PATH OF EGRESS TRAVEL	75 FT	1014.3
ONE EGRESS FROM SPACE REQUIRED	49 PERSONS MAX.	T-1015.1
MINIMUM NUMBER OF EXITS	49 PERSONS MAX. & 75 FT. TRAVEL DISTANCE	T-1019.2
ACCESSIBLE EGRESS	REQUIRED	1007.1

PROPOSED PROJECT		
BUILDING AREA		
VISITOR CENTER	1272 SF	
RESTROOMS	302 SF	
BUILDING HEIGHT	16' - 0"	
NUMBER OF STORIES	1	
NUMBER OF EXITS PROVIDED	4	
AUTOMATIC FIRE SPRINKLERS	NONE	

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CONEJO RECREA

Patrick L. Blote

License #C-14553 Expires 3/31/11 CO Pre of Californ

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CODE ANALYSIS

MCCREA RANCH VISITOR CENTER
4500 N. MOORPARK RD.
THOUSAND OAKS, CALIFORNIA

NO. REVISION DATE

1 PLAN CHECK RESUBMITTAL 05/14/10

PROJECT MANAGER

DRAWN BY CHECKED BY SDR PLB
DATE

FEBRUARY 01, 2010

1402505

T-1.4

1 01-CODE PLAN

A-5.1 T-1.4 1/4" = 1'-0"

R	DOM SCHEDULE	<u>-</u>							
				OCCUPAN	NCY				
NO.	NAME	AREA	CLASSIFCATION	FUNCTION OF SPACE FROM CBC TABLE 1004.1.1	LO	AD FACTOR	LOAD	MAXIMUM OCCUPANT LOAD FOR ONE EXIT FROM CBC TABLE 1015.1	NUMBER OF EXITS
101	ADMIN/VISITOR LOBBY	321 SF	A ASSEMBLY WITHOU	T FIXED SEATS: STANDING SPACE	5		64	49	2
102	EXHIBITS/DISPLAY	165 SF	A ASSEMBLY WITHOU	T FIXED SEATS: STANDING SPACE	5	;	3	49	1
103	MEETING ROOM	576 SF	A ASSEMBLY WITHOU	T FIXED SEATS: CONCENTRATED (CHAIRS ONLY-NOT FIXED)	7	3	32	49	2
104	STORAGE	61 SF	A ACCESSORY STORA	GE AREAS, MECHANICAL EQUIPMENT ROOM	300	()	49	1
105	ELEC.	12 SF	A ACCESSORY STORA	GE AREAS, MECHANICAL EQUIPMENT ROOM	300	()	49	1
106	WOMEN	125 SF	A (none)					49	
107	MEN	102 SF	A (none)					49	
108	JANITOR	19 SF	A (none)					49	
Grand tota	al: 8					·,	79		

CITY OF THOUSAND OAKS

PUBLIC WORKS DEPARTMENT

GRADING PLAN

McCREA RANCH VISITOR'S CENTER THOUSAND OAKS, CA.

PUBLIC UTILITY AUTHORIZATION FOR OPERATION

7385 EAST SANTA ROSA ROAD REVIEWED BY: CAMARILLO, CA. 93010

REVIEWED BY:

DATE

DATE

3589 FOOTHILL DRIVE

THOUSAND OAKS, CA. 91365 REVIEWED BY:

805-494-7065

OWNER AND CONSULTANTS

DEVELOPER:

TELEPHONE:

ELECTRIC:

CONEJO RECREATION AND PARK DISTRICT 403 WEST HILLCREST DRIVE THOUSAND OAKS, CA. 91360

REPRESENTATIVE:

SOILS ENGINEER:

GORIAN AND ASSOCIATES

3595 OLD CONJEJO ROAD THOUSAND OAKS, CA. 91320-2122

805-375-9262 DATES OF REPORTS: SEPT. 9, 2009

RANDAL L. WENDT

EDWARD JOHNDUFF

REPRESENTAIVE:

CIVIL ENGINEER:

RRM DESIGN GROUP 3765 SOUTH HIGUERA STREET

SUITE 102 SAN LUIS OBISPO, CA. 93401

805-543-1794 REPRESENTATIVE: GERALD L. MICHAEL

STRUCTURAL ENGINEER:

77 ROLLING OAKS DRIVE

SUITE 203 THOUSAND OAKS, CA. 91361

805-495-3432 REPRESENTATIVE: EDUARDO ZARATE

ARCHITECT:


MINIMUM OF 48 HOURS PRIOR TO START OF

3765 SOUTH HIGUERA STREET

SUITE 102

SAN LUIS OBISPO, CA. 93401

805-543-1794 REPRESENTATIVE: LEIF McKAY

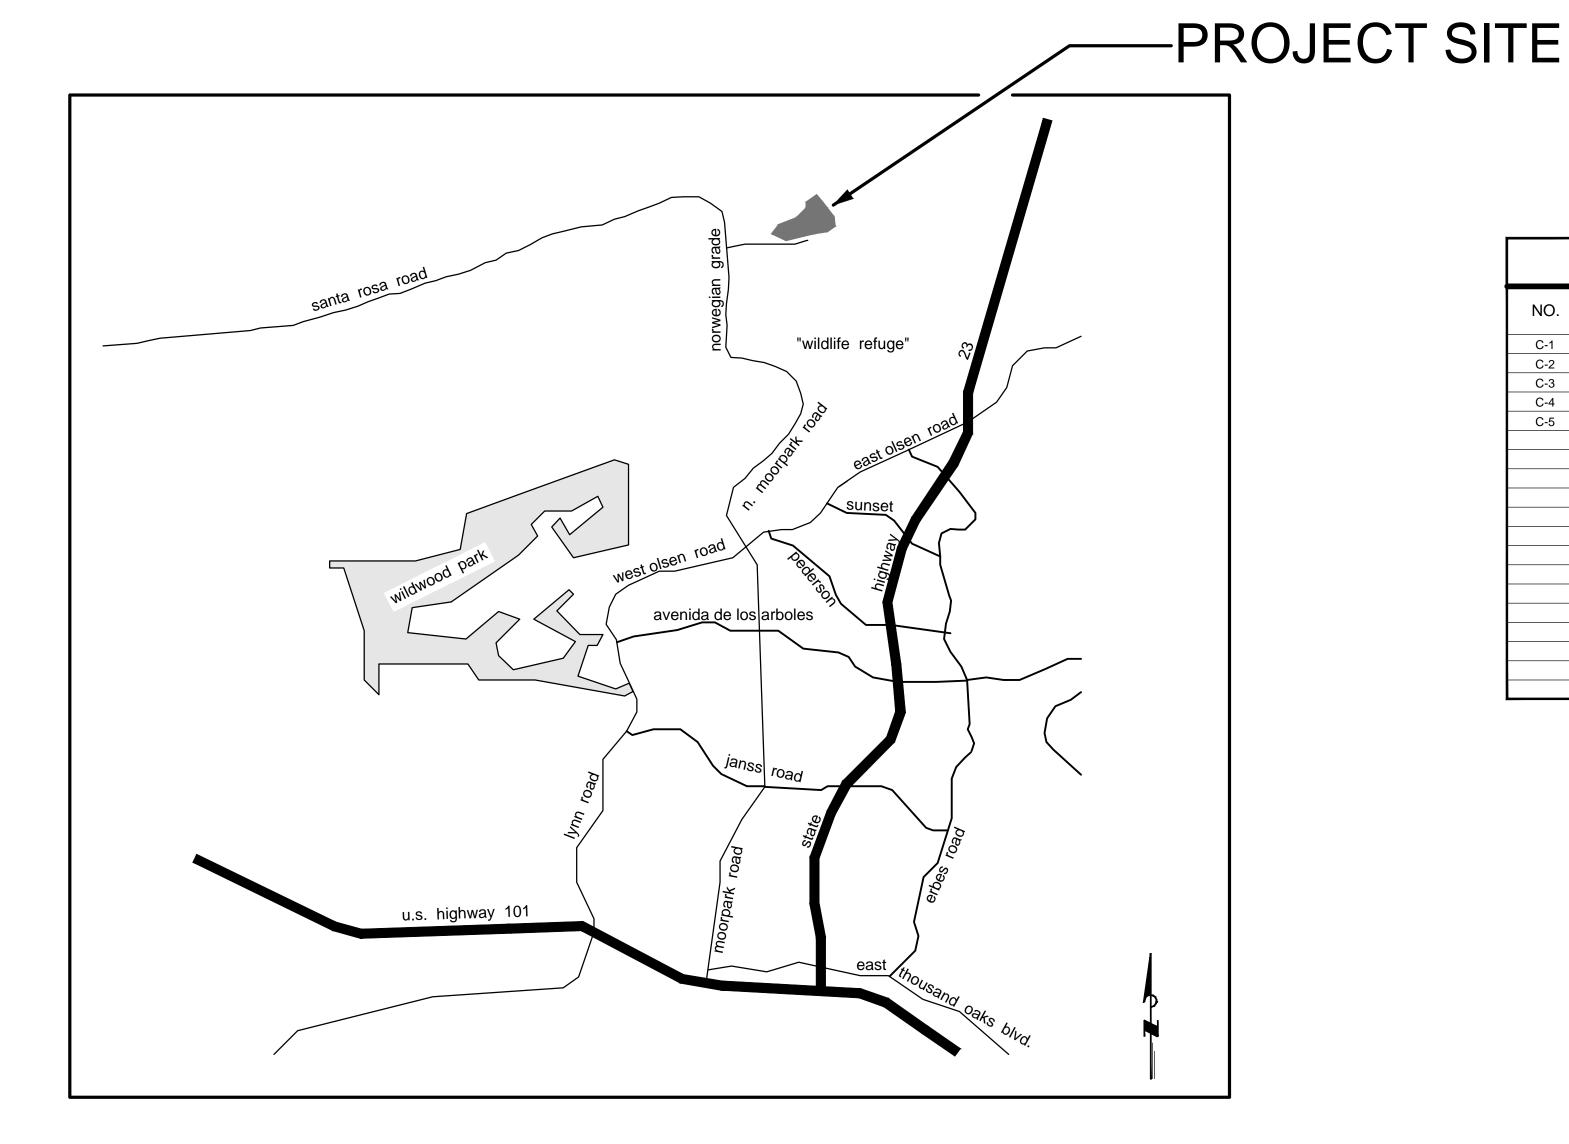

	INDEX OF SHEETS								
NO.	DESCRIPTION	CITY OF T.O. DWG. NO.							
C-1	COVER SHEET	NO.							
C-2	GRADING NOTES	NO.							
C-3	GRADING PLAN	NO.							
C-4	PRIVATE DRIVEWAY	NO.							
C-5	COMPOSITE UTILITY PLAN	NO.							

PERMIT NUMBERS:

3. ENCROACHMENT PERMIT NO. 4. ON-SITE PAVING PERMIT NO.

7. OAK/LANDMAK TREE PERMIT NO.

1. ENTITLEMENT PERMIT NO.

2. GRADING PERMIT NO.

LOCATION MAP NO SCALE

NOTE: NOTIFY PUBLIC WORKS INSPECTOR A MINIMUM OF 24 REVIEWED IN ACCORDANCE WITH CITY'S HOURS PRIOR TO START OF CONSTRUCTION. **NOTE:** CONTRACTOR SHALL TELEPHONE UNDERGROUND SERVICE ALERT (USA) 8 1 1 OR 1(800) 422-4133 A

POLICY CONDITIONS OF APPROVAL BY: SIGNATURE DATE R.C.E. NO. EXP. DATE

ENGINEER OF RECORD: PREPARED BY:

REVIEWED BY: VENTURA COUNTY FIRE DEPARTMENT REVIEWED FOR PERMIT ISSUANCE BY: CITY OF THOUSAND OAKS DATE DEVELOPMENT ENGINEER PLANNING DIVISION DATE DATE <TRAFFIC ENGINEER> DATE <BLDG. DIVISION - ADA COMPLIANCE> CITY OF THOUSAND OAKS DWG. NO. _____ <COSCA>

CITY OF THOUSAND OAKS PUBLIC WORKS DEPARTMENT

5. VENTURA COUNTY WATERSHED PROTECTION DISTRICT

(V.C.W.P.D.) ENCROACHMENT PERMIT NO. 6. CALTRANS ENCROACHMENT PERMIT NO. ____

COVER SHEET

McCREA RANCH VISITOR'S CENTER THOUSAND OAKS, CA.

SHEET C1 OF 5

811	DIA
Know what's below.	AT L

CONSTRUCTION.

AL TOLL FREE LEAST TWO DAYS Call before you dig. UNDERGROUND SERVICE ALERT OF SOUTHERN CALIFORNIA

APR., 2010 DATE APR., 2010 DATE CHECKED BY: 4-14-10 DATE REV. SYMBOL DESCRIPTION OF CHANGE R.C.E. DATE P.D.E. DATE

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GENERAL GRADING NOTES

- 1. ALL IMPOSED CONDITIONS FOR THE APPLICABLE ENTITLEMENT PERMIT SHALL APPLY.
- 2. ALL WORK SHALL BE DONE IN ACCORDANCE WITH THE CITY OF THOUSAND OAKS GRADING ORDINANCE, TITLE 7, CHAPTER 3, REGULATING THE EXCAVATION, GRADING AND FILLING OF LAND AND ANY AMENDMENTS THERETO EXCEPT AS WAIVED OR MODIFIED AS SET FORTH IN THE CONDITIONS OF APPROVAL.
- 3. ESTIMATED EARTHWORK QUANTITIES: CUT: 250 C.Y. EXPORT: 184 C.Y. FILL: 0 C.Y. IMPORT: 0 C.Y.

BY: GORIAN AND ASSOCIATES, INC.

REMOVAL AND RECOMPACTION: 440 C.Y.

4. ALL GEOLOGIC AND SOIL RECOMMENDATIONS IMPOSED BY THE SOILS ENGINEER OR CONTAINED IN THE SOILS AND GEOLOGIC REPORT ARE TO BE COMPLIED WITH AND ARE HEREBY MADE AN INTEGRAL PART OF THE GRADING PLANS AND PERMIT.

GEOLOGIC AND SOILS REPORT DATED: SEPTEMBER 9, 2009 REPORT NUMBERS: 2426-0-0-100

- 5. NO CUT OR FILL SLOPES MAY BE STEEPER THAN 2:1 (H:V) MAXIMUM.
- 6. IN THE EVENT ADVERSE BEDDING PLANES ARE DISCOVERED DURING CONSTRUCTION REQUIRING SLOPE STABILIZATION TECHNIQUES, SUCH WORK SHALL BE APPROVED BY THE CITY ENGINEER UNDER A REVISED GRADING PLAN AND CHANGE ORDER.
- 7. ROUGH GRADED PAD DRAINAGE SHALL BE 2% MINIMUM. FINE GRADING AROUND STRUCTURES SHALL DRAIN AWAY FROM FOOTINGS, TO THE SATISFACTION OF THE PUBLIC WORKS INSPECTOR, TO SWALES WITH 1% MINIMUM SLOPE TO APPROVED DRAINAGE POINTS.
- 8. ANY AREA TO RECEIVE FILL SHALL BE PREPARED BY SCARIFYING TO A MINIMUM DEPTH OF 6", MOISTENED OR DRIED TO NEAR OPTIMUM MOISTURE AND COMPACTED TO A RELATIVE DENSITY OF 90% BEFORE PLACING ADDITIONAL FILL. PRIOR TO PLACING OF ANY FILL MATERIAL, THE AREA SHALL BE APPROVED BY THE PUBLIC WORKS INSPECTOR. SHOULD ADVERSE SOIL CONDITIONS BE ENCOUNTERED, STABILIZATION TECHNIQUES SHALL BE APPROVED BY A CHANGE ORDER.

THE OUTER 12 INCHES OF ALL FILL SLOPE SURFACES SHALL BE TAMPED AND GRID ROLLED TO THE SATISFACTION OF THE SOILS ENGINEER AND THE PUBLIC WORKS INSPECTOR, UNLESS OTHERWISE SPECIFIED.

- 9. THE DISPOSITION OF ANY EXISTING WELL SHALL BE IN ACCORDANCE WITH THE CITY OF THOUSAND OAKS MUNICIPAL CODE SECTION 6-4.04 TO THE SATISFACTION OF THE CITY ENGINEER AND THE VENTURA COUNTY HEALTH DEPARTMENT.
- 10. WITHIN SIX (6) MONTHS AFTER COMMENCEMENT OF GRADING, THE DEVELOPER SHALL PLANT ALL MANUFACTURED SLOPES 3 FEET AND HIGHER WITH SUITABLE GROUND COVER, SHRUBS AND TREES, AND INSTALL A PERMANENT IRRIGATION SYSTEM TO EFFECTIVELY AID IN EROSION CONTROL, ALL TO THE SATISFACTION OF THE CITY ENGINEER. A LANDSCAPING AND IRRIGATION PLAN SHALL BE SUBMITTED TO THE COMMUNITY DEVELOPMENT DEPARTMENT FOR APPROVAL PRIOR TO MAKING SUCH
- 11. ANY CHANGES IN THE WORK SHOWN HEREON SHALL BE SUBJECT TO THE APPROVAL OF
- 12. THE DEVELOPER'S LANDSCAPE ARCHITECT SHALL SUBMIT WRITTEN CERTIFICATION AFTER SATISFACTORY COMPLETION OF LANDSCAPING AND IRRIGATION REQUIREMENTS TO THE PUBLIC WORKS AND THE COMMUNITY DEVELOPMENT DEPARTMENTS. FIELD MEASUREMENTS MAY BE REQUIRED TO ASCERTAIN THE PRECISE HEIGHTS OF CUT AND FILL SLOPES AND/OR SLOPE SURFACE AREA.
- 13. NO STOCKPILING AND/OR IMPORT/EXPORT HAULING SHALL BE PERMITTED UNLESS APPROVED ON THE GRADING PERMIT.
- 14. THE PERMITTEE SHALL EMPLOY A REGISTERED CIVIL ENGINEER TO PROVIDE CONSTANT ON-SITE GRADING SUPERVISION TO ASSURE COMPLIANCE WITH THE APPROVED PLANS AND A SOILS ENGINEER TO PROVIDE CONSTANT SOILS INSPECTION IN ACCORDANCE WITH SECTION 7-3.17 (C & D) OF THE THOUSAND OAKS MUNICIPAL CODE. THE PERMITTEE SHALL SUBMIT RECOMMENDATIONS TO THE CITY ENGINEER WHO SHALL APPROVE THE SELECTION OF THE CIVIL ENGINEER AND SOILS ENGINEER. WEEKLY PROGRESS REPORTS SUBMITTED TO THE CITY ENGINEER BY THE CIVIL ENGINEER MAY BE REQUIRED.
- 15. UPON RECOMMENDATIONS MADE BY THE SOILS ENGINEER AND APPROVED BY THE CITY ENGINEER PRIOR TO THE GRADING OF ANY PROJECT, ROCK WITH DIMENSION FROM EIGHT (8") INCHES TO THIRTY SIX (36") INCHES MAY BE PLACED IN DESIGNATED ROCK DISPOSAL SITES. SUCH OVERSIZED ROCK SHALL NOT BE IN THE UPPER TEN (10') FEET OF COMPACTED FILL OR NEARER THAN (20') FEET TO THE SURFACE OF ANY FILL SLOPE. SUCH ROCK DISPOSAL SITES SHALL BE SHOWN ON THE "RECORD DRAWINGS" AND CERTIFIED TO BE COMPACTED BY THE SOILS ENGINEER.
- 16. ALL RETAINING WALLS SHALL BE CONSTRUCTED UNDER A SEPARATE PERMIT, TO BE OBTAINED PRIOR TO THE ISSUANCE OF THE GRADING PERMIT.

17. OAK TREE NOTES:

- A. ALL OAK TREES WITHIN THE PROJECT BOUNDARIES AND WITHIN 100 FEET OF THE PROJECT BOUNDARIES SHALL BE FENCED AT THE PROTECTED ZONE (5 FEET OUTSIDE THE DRIPLINE) UNTIL PRESERVATION MEASURES, SUBMITTED BY THE SUBDIVIDER, ARE APPROVED BY THE CITY ENGINEER AND COMMUNITY DEVELOPMENT DEPARTMENT. SAID FENCING SHALL CONSIST OF AT LEAST A 5 FOOT HIGH CHAIN LINK MATERIAL FASTENED TO STEEL STAKES 8 FEET ON CENTER.
- ALL OAK TREE WORK SHALL BE DONE IN ACCORDANCE WITH THE CITY OF THOUSAND OAKS OAK TREE ORDINANCE 937-NS AND OAK TREE PRESERVATION AND PROTECTION GUIDELINES RESOLUTION NO. 87-93.
- UNDER NO CONDITION SHALL ANY WORK BE DONE WITHIN THE PROTECTED ZONES OF ANY OAK TREE, WITHOUT OBTAINING AN OAK TREE ENCROACHMENT PERMIT AND GIVING 48 HOURS ADVANCE NOTICE TO THE CITY. NO PROTECTIVE FENCING SHALL BE RELOCATED OR MOVED WITHOUT CITY APPROVAL

REV. SYMBOL

18. ACCESSIBILITY

TO THE EXTENT THE PROVISIONS APPLY, THE DEVELOPER SHALL COMPLY WITH THE REQUIREMENTS OF TITLE 24, BUILDING STANDARDS OF THE CALIFORNIA ADMINISTRATIVE CODE IN REGARDS TO PROVIDING ACCESS TO THE PHYSICALLY DISCABLED.

19. <u>EROSION CONTROL MEASURES</u>

- A. STOCK PILE SANDBAGS IN PARKWAY AREAS FOR RAPID PLACEMENT IN THE EVENT OF A
- B. EXCEPT AS OTHERWISE DIRECTED BY THE PUBLIC WORKS INSPECTOR, ALL DRAINGE DEVICES SHOWN SHALL BE IN PLACE AT THE END OF EACH WORKING DAY WHEN THE FORECAST OF RAIN PROBABILITY IS 40% AND MAINTAINED DURING THE RAINYSEASON (OCTOBER 1ST TO APRIL 15).
- C. APPROVED EROSION CONTROL DEVICES MUST BE IN PLACE DURING THE ABOVE
- D. CLEAN OUT MUD AND SILT AFTER EACH RAIN OR AS DIRECTED BY THE PUBLIC WORKS

20. SPECIAL NOTES FOR STORMWATER POLLUTION PREVENTION

- A. A STORMWATER POLLUTION CONTROL PLAN (SWPCP) IS REQUIRED FOR ALL PROJECTS FOR WHICH THE DISTURBED AREA IS GREATER THAN 1 ACRE. SWPCP FORMS ARE AVAILABLE AT THE PUBLIC WORKS DEPARTMENT. A COPY OF THE SWPCP SHALL BE ON FILE WITH THE CITY PRIOR TO ISSUANCE OF A GRADING
- PERMIT, AND A COPY SHALL BE MAINTAINED AT THE JOB SITE AT ALL TIMES. B. CONSTRUCTION ACTIVITY INCLUDING CLEARING, GRADING, DISTURBANCES TO SOIL SUCH AS STOCKPILING, OR EXCAVATION THAT RESULTS IN DISTURBANCES OF AT LEAST ONE ACRE OF TOTAL LAND AREA ARE REQUIRED BY THE STATE TO APPLY FOR AN NPDES GENERAL PERMIT FOR STORMWATER DISCHARGES ASSOCIATED WITH CONSTRUCTION ACTIVITY. DEVELOPER SHALL FILE A NOTICE OF INTENT (NOI) WITH THE APPROPRIATE FEE TO THE STATE WATER RESOURCES CONTROL BOARD AT THE FOLLOWING ADDRESS:

STATE WATER RESOURCES CONTROL BOARD DIVISION OF WATER QUALITY

STORM WATER PERMIT UNIT

P.O. BOX 1977, SACRAMENTO, CALIFORNIA 95812 - 1977

PROOF OF FILING THE NOI SHALL BE ON FILE WITH THE CITY PRIOR TO ISSUANCE OF A GRADING PERMIT. A COPY OF THE SWPCP SHALL BE MAINTAINED AT THE JOBSITE

TOTAL LAND AREA TO BE DISTURBED IS: 0.68 ACRES. (INCLUDING CLEARING, GRADING, STOCKPILING, AND/OR EXCAVATION)

21. SPECIAL NOTE FOR ON-SITE PAVING PLANS

- THIS PLAN MAY HAVE BEEN REVIEWED ONLY AS A FINE GRADING, DRAINAGE AND PAVING PLAN FOR THE PURPOSE OF DOING FINE GRADING AND CONSTRUCTION OF PARKING LOT(S) WITH THE APPROPRIATE DRAINAGE DEVICES. THE REVIEW DOES NOT SUPERSEDE ANY COMMUNITY DEVELOPMENT DEPARTMENT CONDITIONS AND ALL ITEMS RELATING TO THE PLOT PLAN MUST BE FULFILLED. IT IS THE OWNER/DEVELOPER OR HIS REPRESENTATIVE'S RESPONSIBILITY TO ASCERTAIN THAT EVERYTHING SHOWN HEREON AGREES WITH THE PLOT PLAN (I.E. CONCRETE CURBS, PLANTER AREAS,
- 22. AN ON-SITE PAVING PERMIT SHALL BE OBTAINED FROM THE DEPARTMENT OF PUBLIC WORKS, AND FEES PAID PRIOR TO PAVING PARKING AND DRIVEWAY AREAS.
- 23. MAXIMUM PAVEMENT SLOPES ARE AS FOLLOWS:

PARKING AREAS: 2% MAXIMUM HANDICAP PARKING 2 1/2% MAXIMUM (OTHER PARKING) DRIVEWAY AREAS: 7% MAXIMUM FOR COMMERCIAL USES 15% MAXIMUM FOR RESIDENTIAL USES

24. <u>SEISMIC HAZARDS MAPPING ACT</u>

PRIOR TO APPROVAL OF THE GRADING PLANS AND THE ISSUANCE OF A GRADING PERMIT, THE DEVELOPER'S CIVIL ENGINEER OR ENGINEERING GEOLOGIST SHALL DETERMINE IF THE PROPOSED DEVELOPMENT IS LOCATED WITHIN A LIQUEFACTION OR LANDSLIDE AREA AS IDENTIFIED ON THE SEISMIC HAZARDS MAP PREPARED BY THE STATE OF CALIFORNIA. IF THE DEVELOPMENT IS WITHIN SUCH AN AREA, THE DEVELOPER'S CIVIL ENGINEER OR ENGINEERING GEOLOGIST SHALL PREPARE A REPORT WHICH EVALUATES THE POTENTIAL GEOLOGICAL HAZARD WITH RECOMMENDATIONS FOR SUITABLE MITIGATION MEASURES, PURSUANT TO THE SEISMIC HAZARDS MAPPING ACT. THE DEVELOPER SHALL SUBMIT THE REPORT TO THE STATE DEPARTMENT OF CONSERVATION, DIVISION OF MINES AND GEOLOGY, AT THE FOLLOWING ADDRESS, CONCURRENT WITH SUBMITTAL TO THE CITY:

SEISMIC HAZARDS MAPPING 801 K STREET MS 12 - 78

SACRAMENTO, CA 95814 - 3531

THE DEVELOPER SHALL PROVIDE A RETURN RECEIPT OR OTHER PROOF OF SUCH SUBMITTAL TO THE CITY ENGINEER, ALONG WITH A COPY OF THE REPORT, PRIOR TO THE ISSUANCE OF THE GRADING PERMIT.

NOTE: NOTIFY PUBLIC WORKS INSPECTOR A MINIMUM OF 24 HOURS PRIOR TO START OF CONSTRUCTION.

NOTE: CONTRACTOR SHALL TELEPHONE UNDERGROUND SERVICE ALERT (USA) 8 1 1 OR 1(800) 422-4133 A MINIMUM OF 48 HOURS

REVIEWED IN ACCORDANCE WITH CITY'S POLICY CONDITIONS OF APPROVAL BY:		THIS PLAN HAS BEEN REVIEW GENERAL CONFORMITY WITH DIMENSIONS, MEASUREMENTS GEOTECHNICAL.	THE GEO	_ MAKES NO REI	COMMENDATIONS IN OUR REPRESENTATION AS TO THE	ACCURACY	ATED OF
SIGNATURE	DATE						
R.C.E. NO.	EXP. DATE	REGISTERED GEOLOGIST	NO.	DATE	SOILS ENGINEER	NO.	DATE

APR., 2010 DATE DRAWN BY: KLM APR., 2010

R.C.E. DATE P.D.E.

4-14-10

DATE

3765 South Higuera St., Ste. 102, San Luis Obispo, CA 93401 P: (805) 543-1794 | F: (805) 543-4609 | www.rrmdesign.com A California Corporation | Victor Montgomery, Architect #C11090 | Jerry Michael, PE #36895, LS #6276 | Jeff Ferber, LA #2844

ABBREVIATIONS

MAXIMUM

MANHOLE

MONUMENT

NAT. GRD. NATURAL GROUND

PARALLEL

M.H.

O.G.

PAR.

P.C.C.

P.C.C.

P.O.C

P.R.C.

P.M.C.

PROP.

PVMT.

R.C.B.

R.C.P.

R/W

T.C.

T.S.

V.C.

TOPO.

MIDDLE CURVE

MISCELLANEOUS

ORIGINAL GROUND

PROPERTY LINE

POINT ON CURVE

PROPOSED

RIGHT OF WAY

TOP OF CURB

TOPOGRAPHY

TRAFFIC SIGNAL

VERTICAL CURVE

PAVEMENT

TANGENT

POINT OF COMPOUND CURVE

POINT OF INTERSECTION

POINT OF REVERSE CURVE

REINFORCED CONCRETE BOX

REINFORCED CONCRETE PIPE

PROCESSED MISCELLANEOUS BASE

PORTLAND CEMENT CONCRETE

AGGREGATE BASE

BENCH MARK

CATCH BASIN

CURB RADIUS

CURB RETURN

END OF CURB

END OF CURB RETURN

EDGE OF PAVEMENT

FINISHED GRADE

FINISHED SURFACE

HYDRAULIC GRADE LINE

JUNCTION STRUCTURE

FIRE HYDRANT

GROUND LINE

INTERSECTION

LENGTH OF ARC

CROSS SECTIONS

FLOW LINE

GUTTER

HEADWALL

CENTERLINE

CONCRETE

ASPHALTIC CONCRETE

AGGREGATE SUBBASE

BEGINNING OF CURVE

BEGINNING OF CURVE RETURN

CRUSHED AGGREGATE BASE

CRUSHED MISCELLANEOUS BASE

A.C.

A.S.

B.C.

B.C.R.

B.M.

C.B.

C.A.B.

C.M.B.

CB.R.

C/L, Q

C.R.

E.C.R.

E.P.

F.G.

F.S.

G.L.

GUT.

H.G.L.

X-SEC

H/W, HW

INTER, +

CONC

CITY OF THOUSAND OAKS DATE DEVELOPMENT ENGINEER DATE PLANNING DIVISION DATE <TRAFFIC ENGINEER> <BLDG. DIVISION - ADA COMPLIANCE> DATE

<COSCA>

REVIEWED FOR PERMIT ISSUANCE BY:

CITY OF THOUSAND OAKS PUBLIC WORKS DEPARTMENT

GRADING NOTES AND DETAILS

McCREA RANCH VISITOR'S CENTER THOUSAND OAKS, CA.


SHEET C2 OF 5 CITY OF THOUSAND OAKS DWG. NO. _____


			GEOT	ECHNICAL.							
SIGNATURE	DATE	_									
R.C.E. NO.	EXP. DATE	_	REGI	ISTERED GEO	OLOGIST	NO.	DATE	SOILS ENGINE	ER	NO.	DATE
							DESIGNED BY:		ENGINEE	R OF REC	ORD:
							1				


PRIOR TO START OF CONSTRUCTION. DIAL TOLL FREE DATE Know what's **below.** AT LEAST TWO DAYS CHECKED BY: Call before you dig. BEFORE YOU DIG UNDERGROUND SERVICE ALERT OF SOUTHERN CALIFORNIA

DESCRIPTION OF CHANGE

PREPARED BY: creating environments people enjoy**

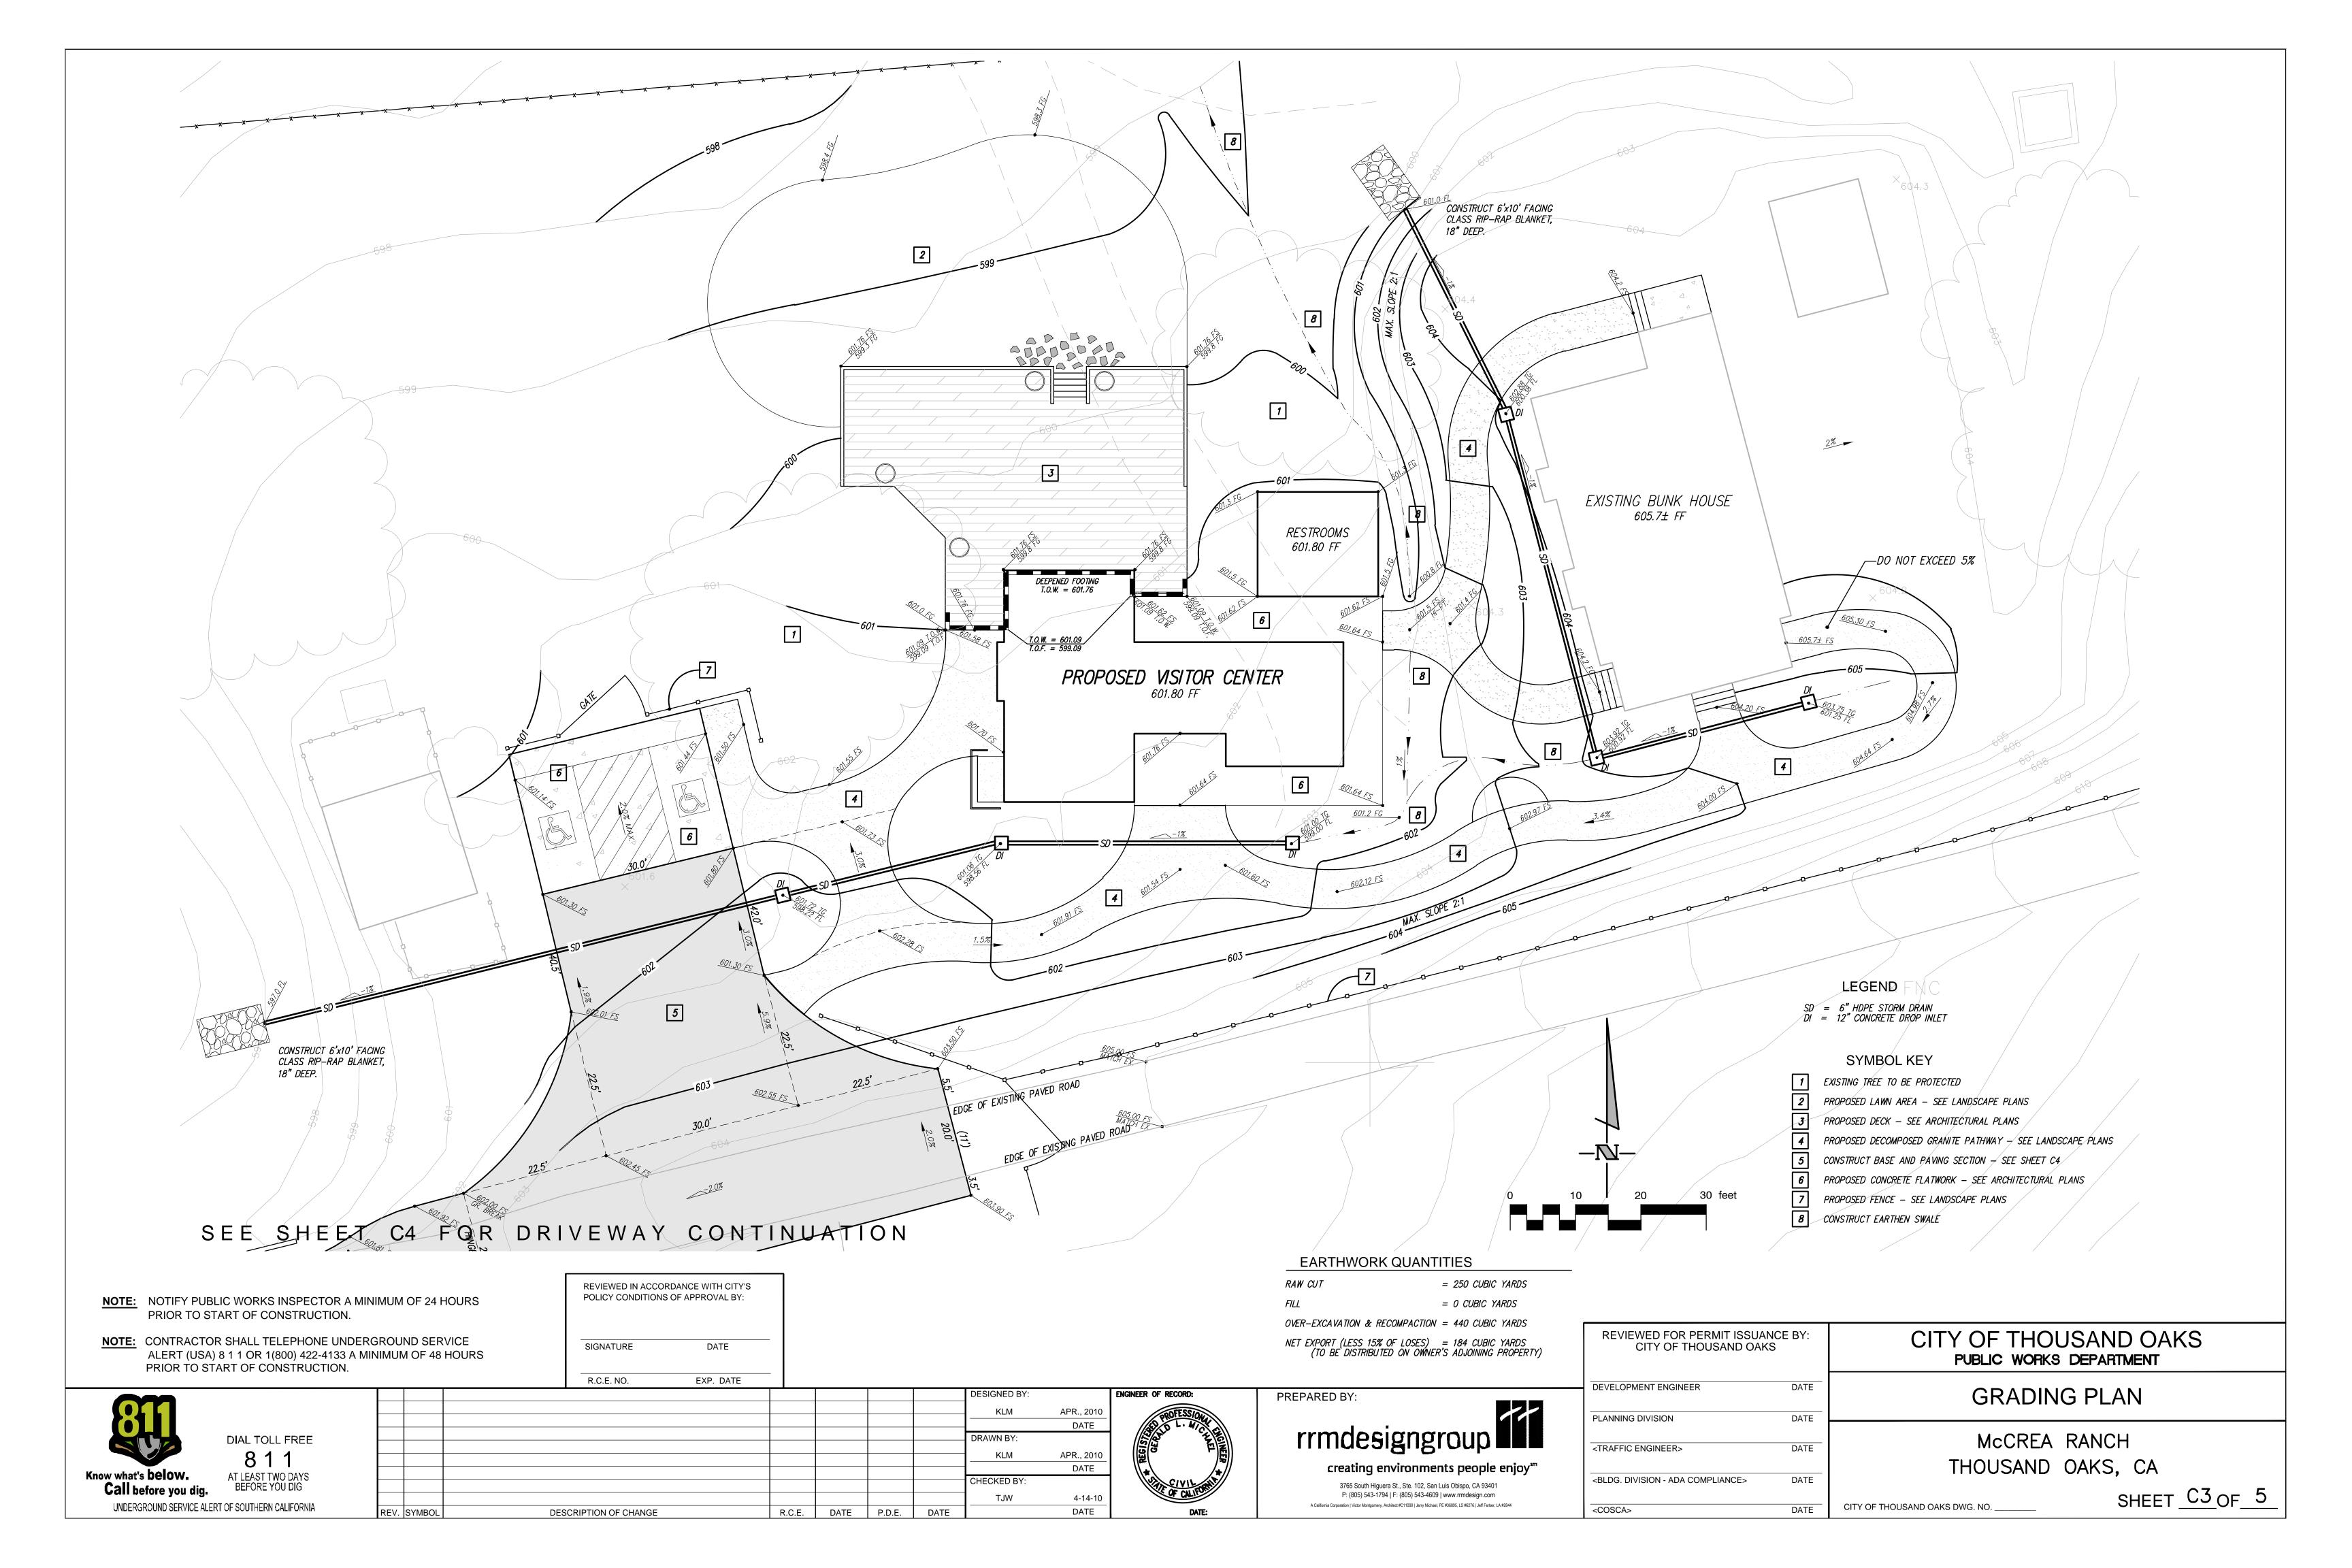

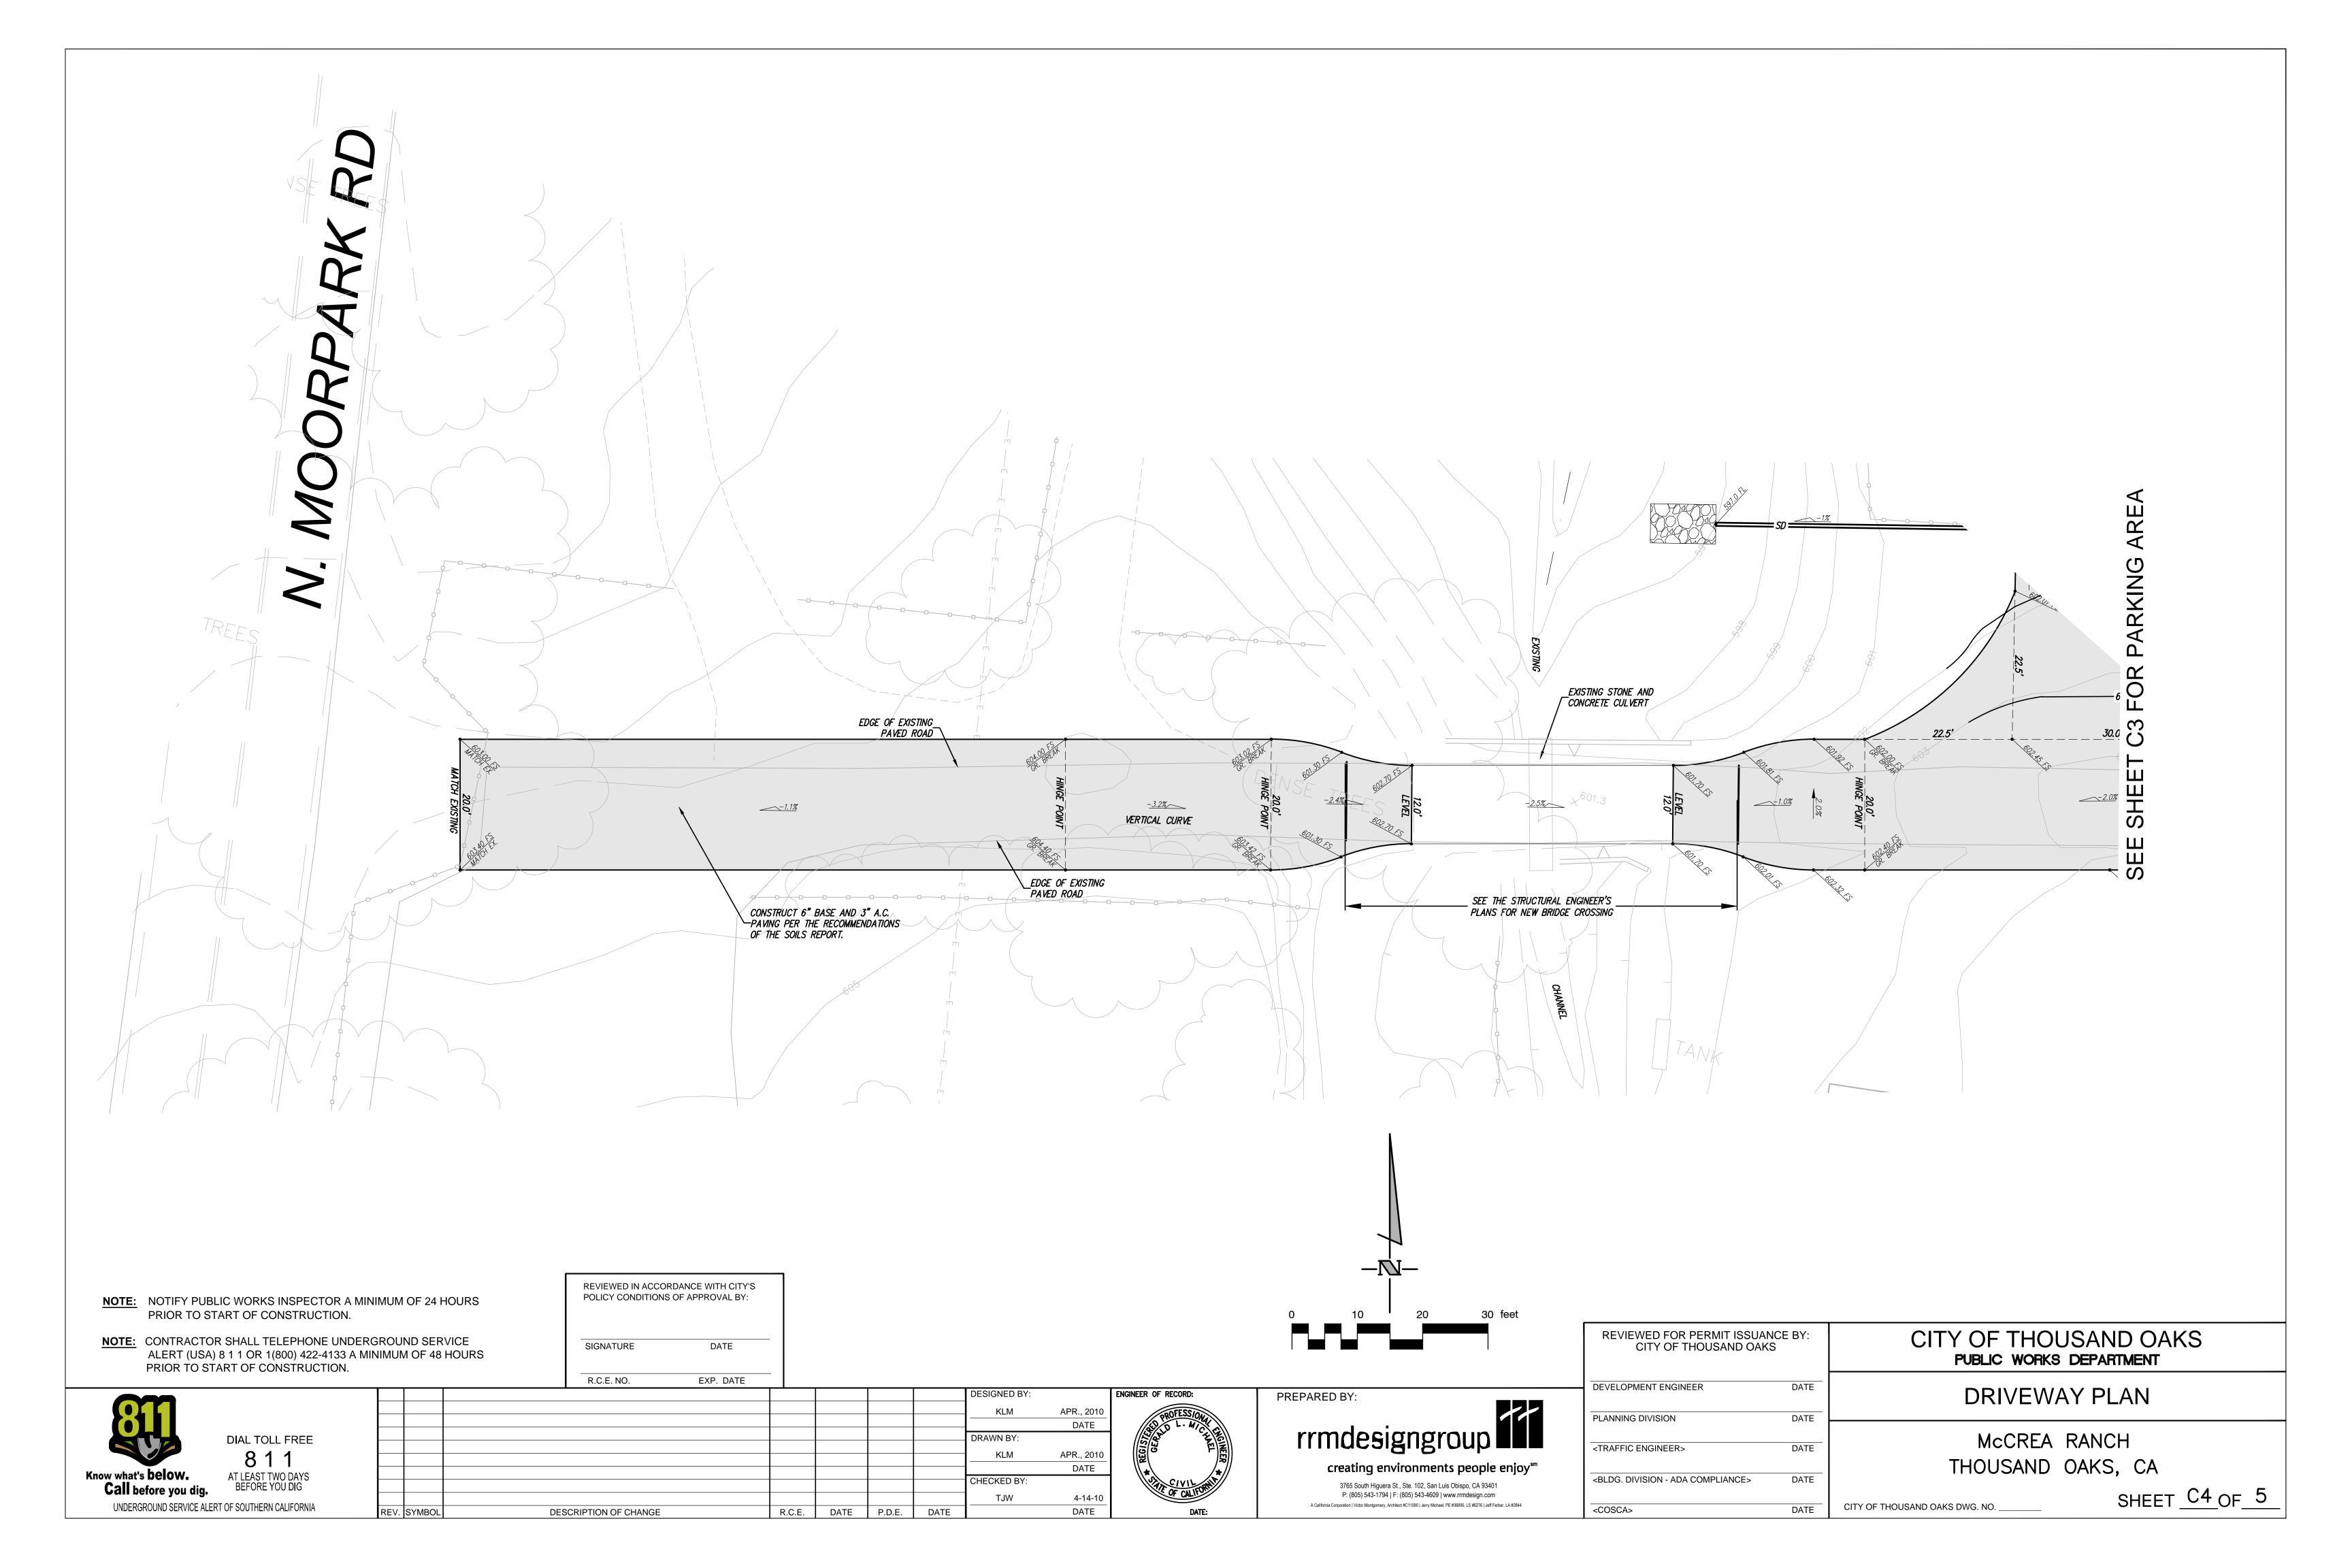

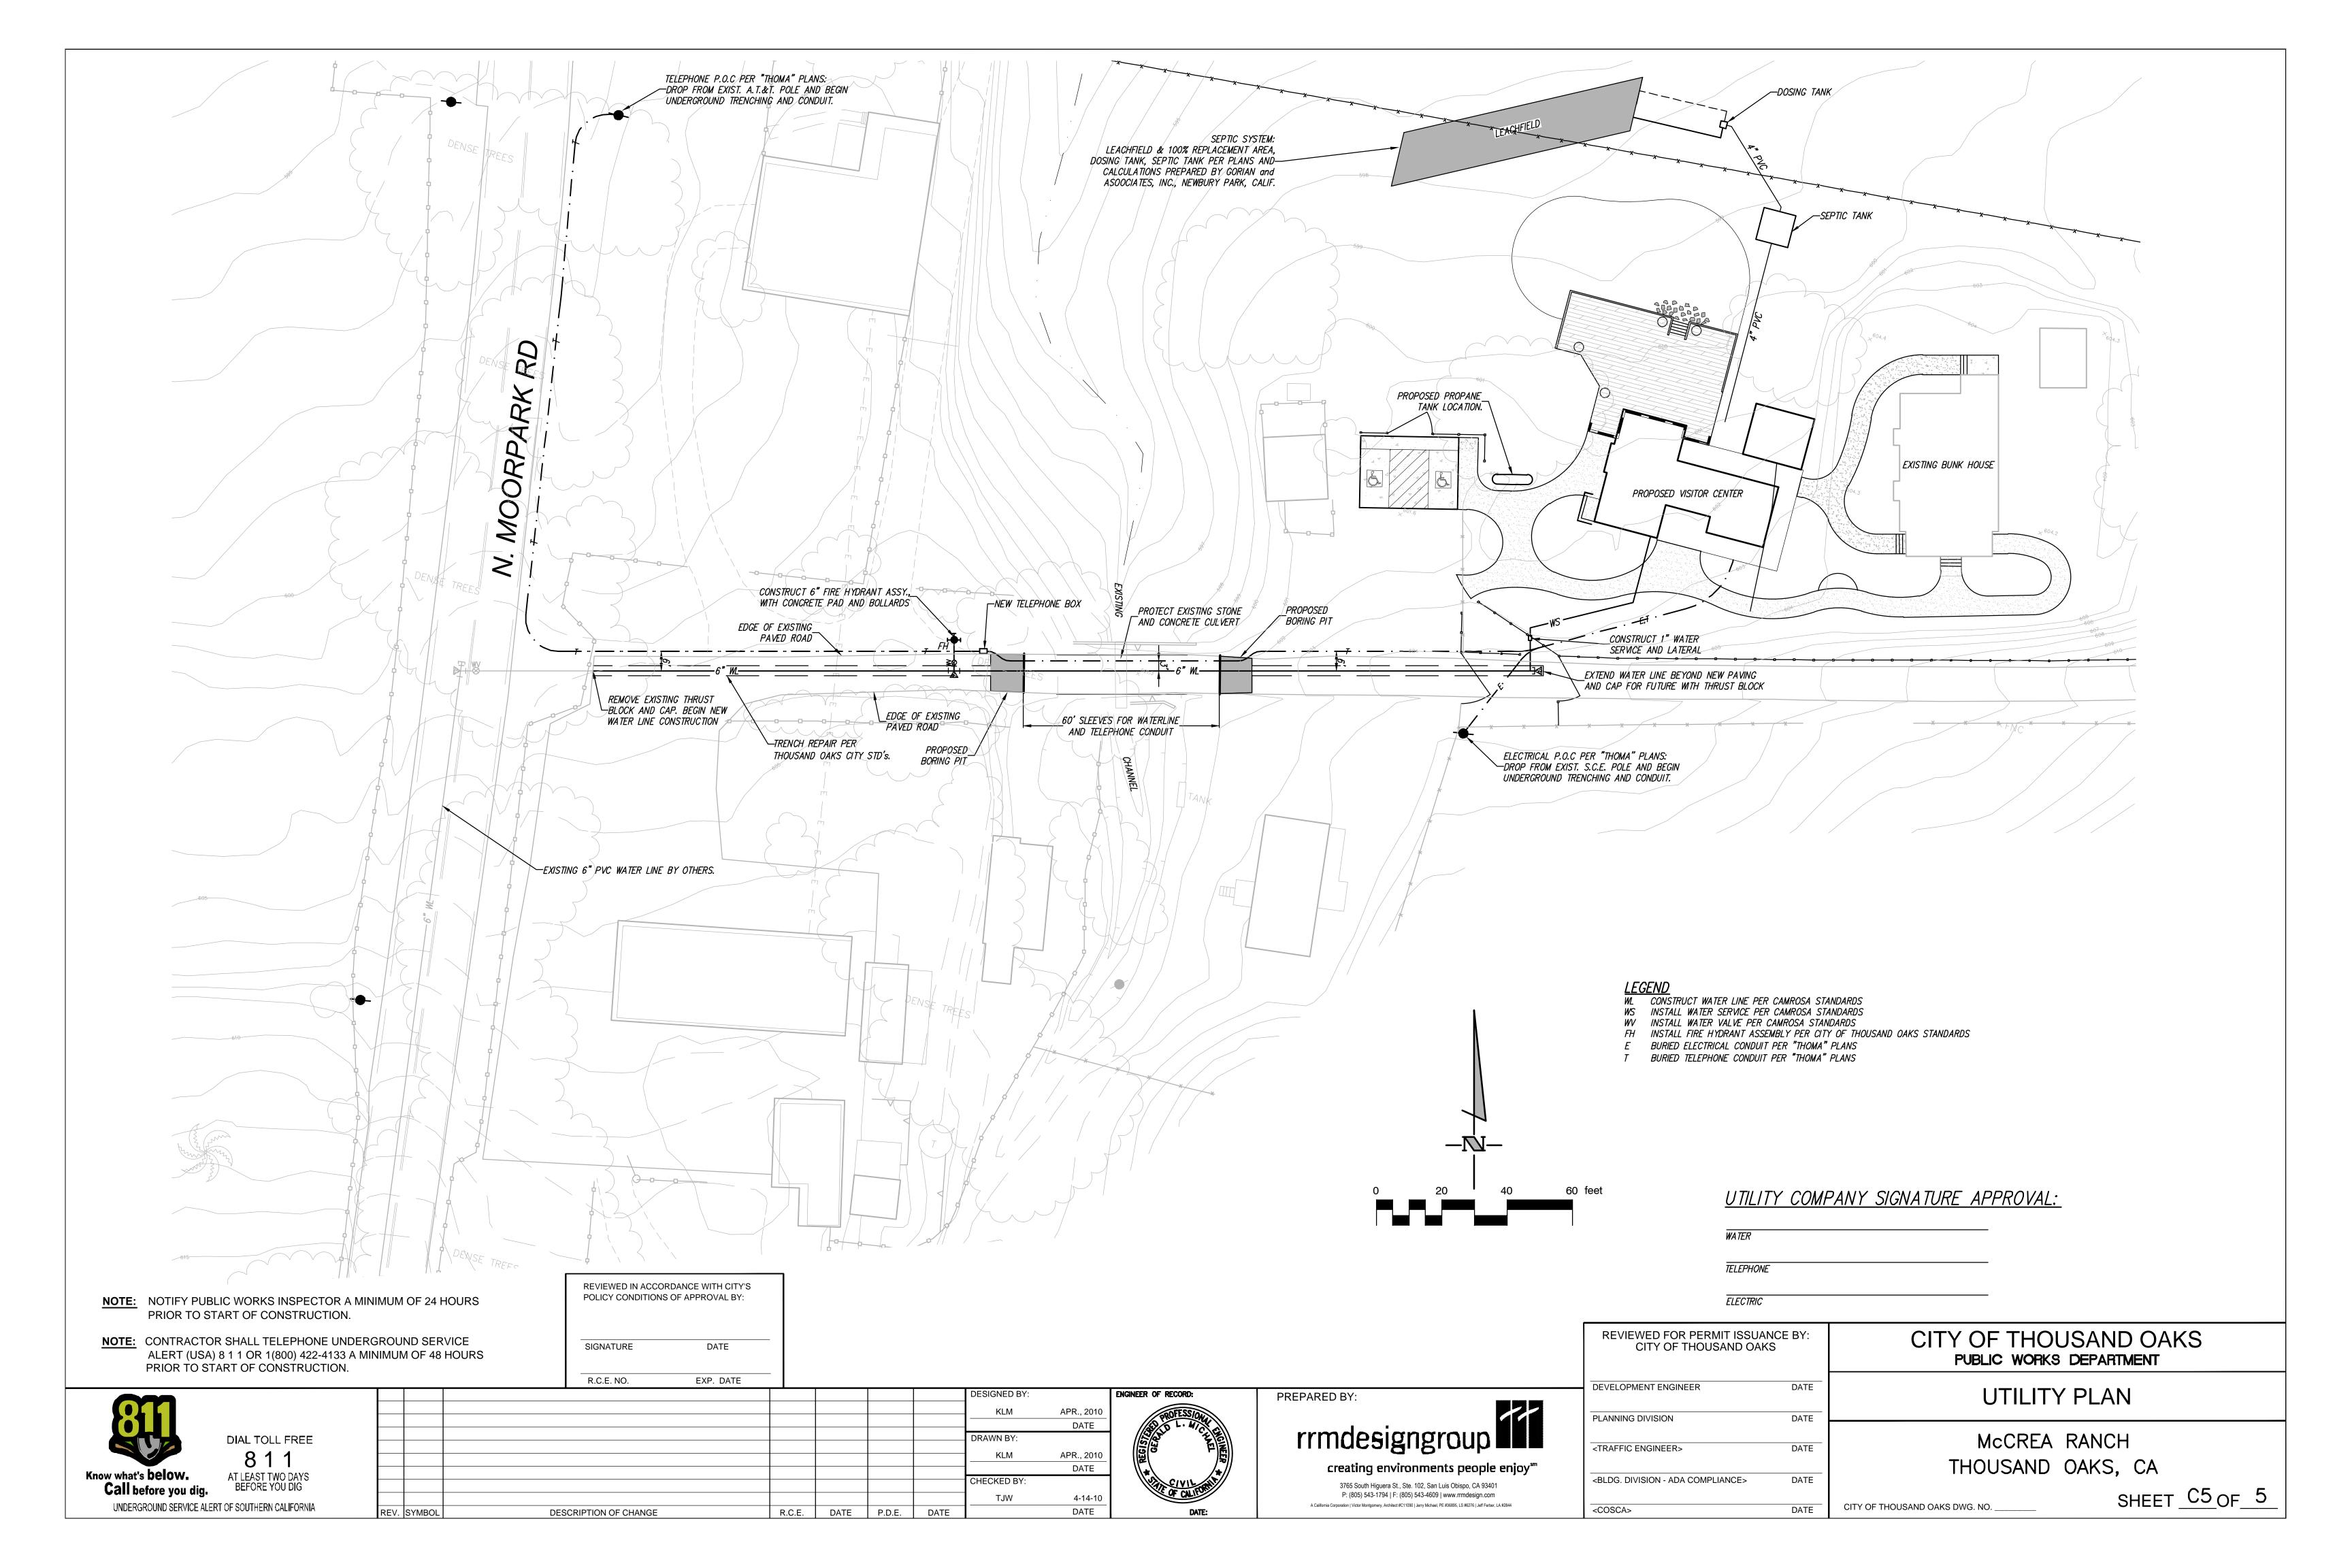

P.O.C. NUMBER:01 Water Source Information: See Sheet C-1

FLOW AVAILABLE Water Meter Size: 1" Flow Available: 37.50 gpm

PRESSURE AVAILABLE Static Pressure at POC: 100.00 psi Elevation Change: 4.00 ft Service Line Size: 6" Length of Service Line: 320.00 ft Pressure Available:98.00 psi

DESIGN ANALYSIS Maximum Multi-valve Flow: 38.00 gpm Flow Available at POC: 37.50 gpm Residual Flow Available: -0.50 gpm

Critical Station: 5 Pressure Req. at Critical Station: 36.56 psi Loss for Fittings: 0.51 psi Loss for Main Line: 5.14 psi Loss for POC to Valve Elevation: Loss for Backflow: 12.81 psi Loss for Master Valve: 2.39 psi Loss for Water Meter: 1.27 psi Critical Station Pressure at POC: Pressure Available:98.00 psi Residual Pressure Available: 41.71 psi

IRRIGATION NOTES

- 1. IRRIGATION PLAN IS DIAGRAMMATIC. FINAL LOCATION OF PIPING WILL BE DETERMINED AT THE TIME OF INSTALLATION. MAINLINE AND LATERALS SHALL BE PLACED IN THE SAME TRENCH WHEN POSSIBLE. ALL Q.C. VALVES ARE TO BE LOCATED 12" FROM SIDEWALKS, CURBS, ASPHALT & CONCRETE SURFACES.
- 2. ALL EQUIPMENT REQUIRED BUT NOT SPECIFIED ON THE DRAWING, TO COMPLETE THE WORK, SHALL BE PROVIDED BY THE IRRIGATION CONTRACTOR.
- 3. INSTALL ALL EQUIPMENT IN ACCORDANCE WITH MANUFACTURER'S INSTRUCTIONS AND/OR SPECIFICATIONS.
- 4. CONTRACTOR SHALL COORDINATE POWER TO CONTROLLERS AND DEDICATE ONE (1) 20 AMP BREAKER FOR EACH CONTROLLER. THE AUTHORIZED REPRESENTATIVE SHALL REVIEW CONTROLLER LOCATIONS PRIOR TO INSTALLATION. 120 VOLT SERVICE AND HOOK-UP TO THE CONTROLLER SHALI BE COMPLETED BY A LICENSED ELECTRICAL CONTRACTOR. THIS COST IS TO BE A PART OF THE LANDSCAPE CONTRACTOR'S BID.
- 5. CONTRACTOR SHALL BECOME FAMILIAR WITH THE PLANS AND SITE CONDITIONS PRIOR TO BEGINNING WORK. SHOULD CONFLICTING INFORMATION BE FOUND ON THE PLANS, THE CONTRACTOR SHALL NOTIFY THE PROJECT LANDSCAPE ARCHITECT BEFORE PROCEEDING WITH THE WORK IN QUESTION.
- 6. DO NOT WILLFULLY INSTALL THE IRRIGATION SYSTEM AS SHOWN ON THE DRAWINGS WHEN IT IS OBVIOUS IN THE FIELD THAT OBSTRUCTIONS, GRADE DIFFERENCES OR DIFFERENCES IN THE AREA DIMENSIONS EXIST THAT MIGHT NOT HAVE BEEN CONSIDERED IN THE ENGINEERING. SUCH OBSTRUCTIONS OR DIFFERENCES SHOULD BE BROUGHT TO THE ATTENTION OF THE LANDSCAPE ARCHITECT. IN THE EVENT THIS NOTIFICATION IS NOT PERFORMED, THE CONTRACTOR SHALL ASSUME FULL RESPONSIBILITY FOR ANY REVISIONS NECESSARY AT NO EXPENSE TO THE OWNER.
- 7. CONTRACTOR SHALL INCLUDE PCS SCREENS WHERE NECESSARY TO REDUCE RADIUS OF THROW.
- 8. CONTRACTOR SHALL SLEEVE UNDER PAVING PER PLANS AND SPECIFICATIONS. ALL SLEEVES UNDER PAVING SHALL RECEIVE IDENTIFYING MARK ON TOP OF CONCRETE. EXTEND ALL SLEEVES 18" BEYOND EDGE OF PAVING.
- 9. SPLICING OF 24 VOLT WIRES WILL NOT BE PERMITTED EXCEPT IN VALVE BOXES. LEAVE A 24" COIL OF EXCESS WIRE AT EACH SPLICE. LABEL ALL WIRES W/ WATERPROOF MARKERS AT ALL SPLICES AND VALVE MANIFOLDS.
- 10. CONTRACTOR SHALL BE RESPONSIBLE FOR THE INSTALLATION OF ALL MATERIAL APPEARING ON PLAN.
- 11. ALL EXISTING UTILITIES, WATER LINES AND FIRE HYDRANTS SHALL REMAIN CONNECTED AND IN FULL CONTINUOUS OPERATION DURING AND FOLLOWING ALL CONTRACT WORK.
- 12. LOCATE ALL VALVES OUTSIDE OF TURF AREAS WHERE POSSIBLE.
- 13. CONTRACTOR SHALL MAKE ALL NECESSARY ADJUSTMENTS TO THE IRRIGATION SYSTEM FOLLOWING A PRECIPITATION TEST PER THE OWNER. ADJUSTMENTS SHALL INCLUDE BUT WILL NOT BE LIMITED TO: HEAD RELOCATION, CHANGING NOZZLES, AND ADJUSTING ARC PATTERNS TO ATTAIN 65% EFFICIENT UNIFORMITY AS REQUIRED BY THE OWNER.
- 14. CONTRACTOR SHALL NOT INSTALL ANY PLANTING UNTIL THE FOLLOWING ARE COMPLETED:
 - 14.1. THE IRRIGATION SYSTEM SHALL BE FULLY OPERATIONAL.
 - 14.2. HYDROSTATIC PRESSURE TESTS SHALL BE PERFORMED ON MAIN
 - AND LATERAL LINES. 14.3. ALL ZONES SHALL PASS A COVERAGE TEST.
 - 14.4. CONTROLLERS SHALL BE FULLY OPERATIONAL.

IRRIGATION LEGEND

	<u>QTY</u>	ARC PSI GPM RADIUS	DETAIL REFERENCE
	3	360 30 1.60 16'	Detail G, Sheet IR-3.01
	10	180 30 0.80 16'	Detail G, Sheet IR-3.01
	2	90 30 0.40 16'	Detail G, Sheet IR-3.01
	1	120 30 0.53 16'	Detail G, Sheet IR-3.01
	1	270 30 1.20 16'	Detail G, Sheet IR-3.01
	10	360 20 0.50 1'	Detail J, Sheet IR-3.01
DESCRIPTION	QTY		
valve, 3/4" pressure si pressure regulator.	5		Detail I, Sheet IR-3.01
ensating drip emitter, barbed Ogph, Red=2.0gph. Cemitter. emitter. emitters.	6,548 s.f.		Detail K, Sheet IR-3.01
DESCRIPTION	QTY		
e	2		Detail F, Sheet IR-3.01
piece body, locking cover	4		Detail H, Sheet IR-3.01
	1		Detail D, Sheet IR-3.01
	1		Detail E, Sheet IR-3.01
er. Indoor, wall-mounted.	1		Detail A, Sheet IR-3.01
indoor model. Install per	1		Detail A, Sheet IR-3.01
Preventer	1		Detail B, Sheet IR-3.01
	1		See Civil Plans
Schedule 40 zes 1" and above are I others being 3/4" in size.	533 l.f.		Detail A, Sheet IR-3.02
edule 40	304 l.f.		Detail A, Sheet IR-3.02
40 ion pipe. Pipe sleeve size g and their related couplings ng material. Extend sleeves aving or construction.	32 l.f.		Detail A, Sheet IR-3.02
ċ	aving or construction.	aving or construction.	aving or construction.


VALVE SCHEDULE

Valve Size

NUMBER	MODEL	SIZE	<u>TYPE</u>	<u>PSI</u>	PSI @ POC	<u>GPM</u>	<u>PRECIP</u>
1	Rain Bird XCZ-LF-100-PRF	1"	Drip	26.69	38.85	1.23	0.66 in/h
2	Rain Bird XCZ-LF-100-PRF	1"	Drip	27.72	41.65	2.50	0.97 in/h
3	Rain Bird XCZ-LF-100-PRF	1"	Drip	26.82	41.26	1.39	0.67 in/h
4	Rain Bird XCZ-LF-100-PRF	1"	Drip	25.15	40.73	0.43	0.59 in/h
5	Rain Bird PEB	1"	Turf Rotary	34.18	56.29	15.33	0.57 in/h
6	Rain Bird XCZ-LF-100-PRF	1"	Drip	26.16	43.31	0.85	0.06 in/h
7	Rain Bird PEB	1"	Bubbler	23.19	42.45	5.00	15.32 in/h



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S S IRRIGATION LEG AND NOTES

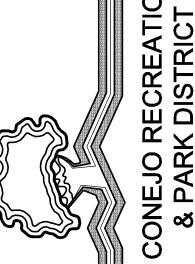RANCE


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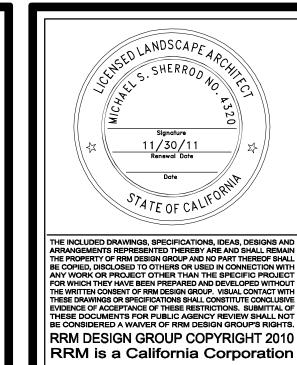
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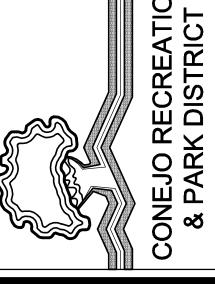
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JOB NUMBER

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reating environments p 3765 South Higuera St., Ste. 102, San Luis Ob

SITOR CENTER IRRIGATION PLAN

PROJECT MANAGER

DRAWN BY

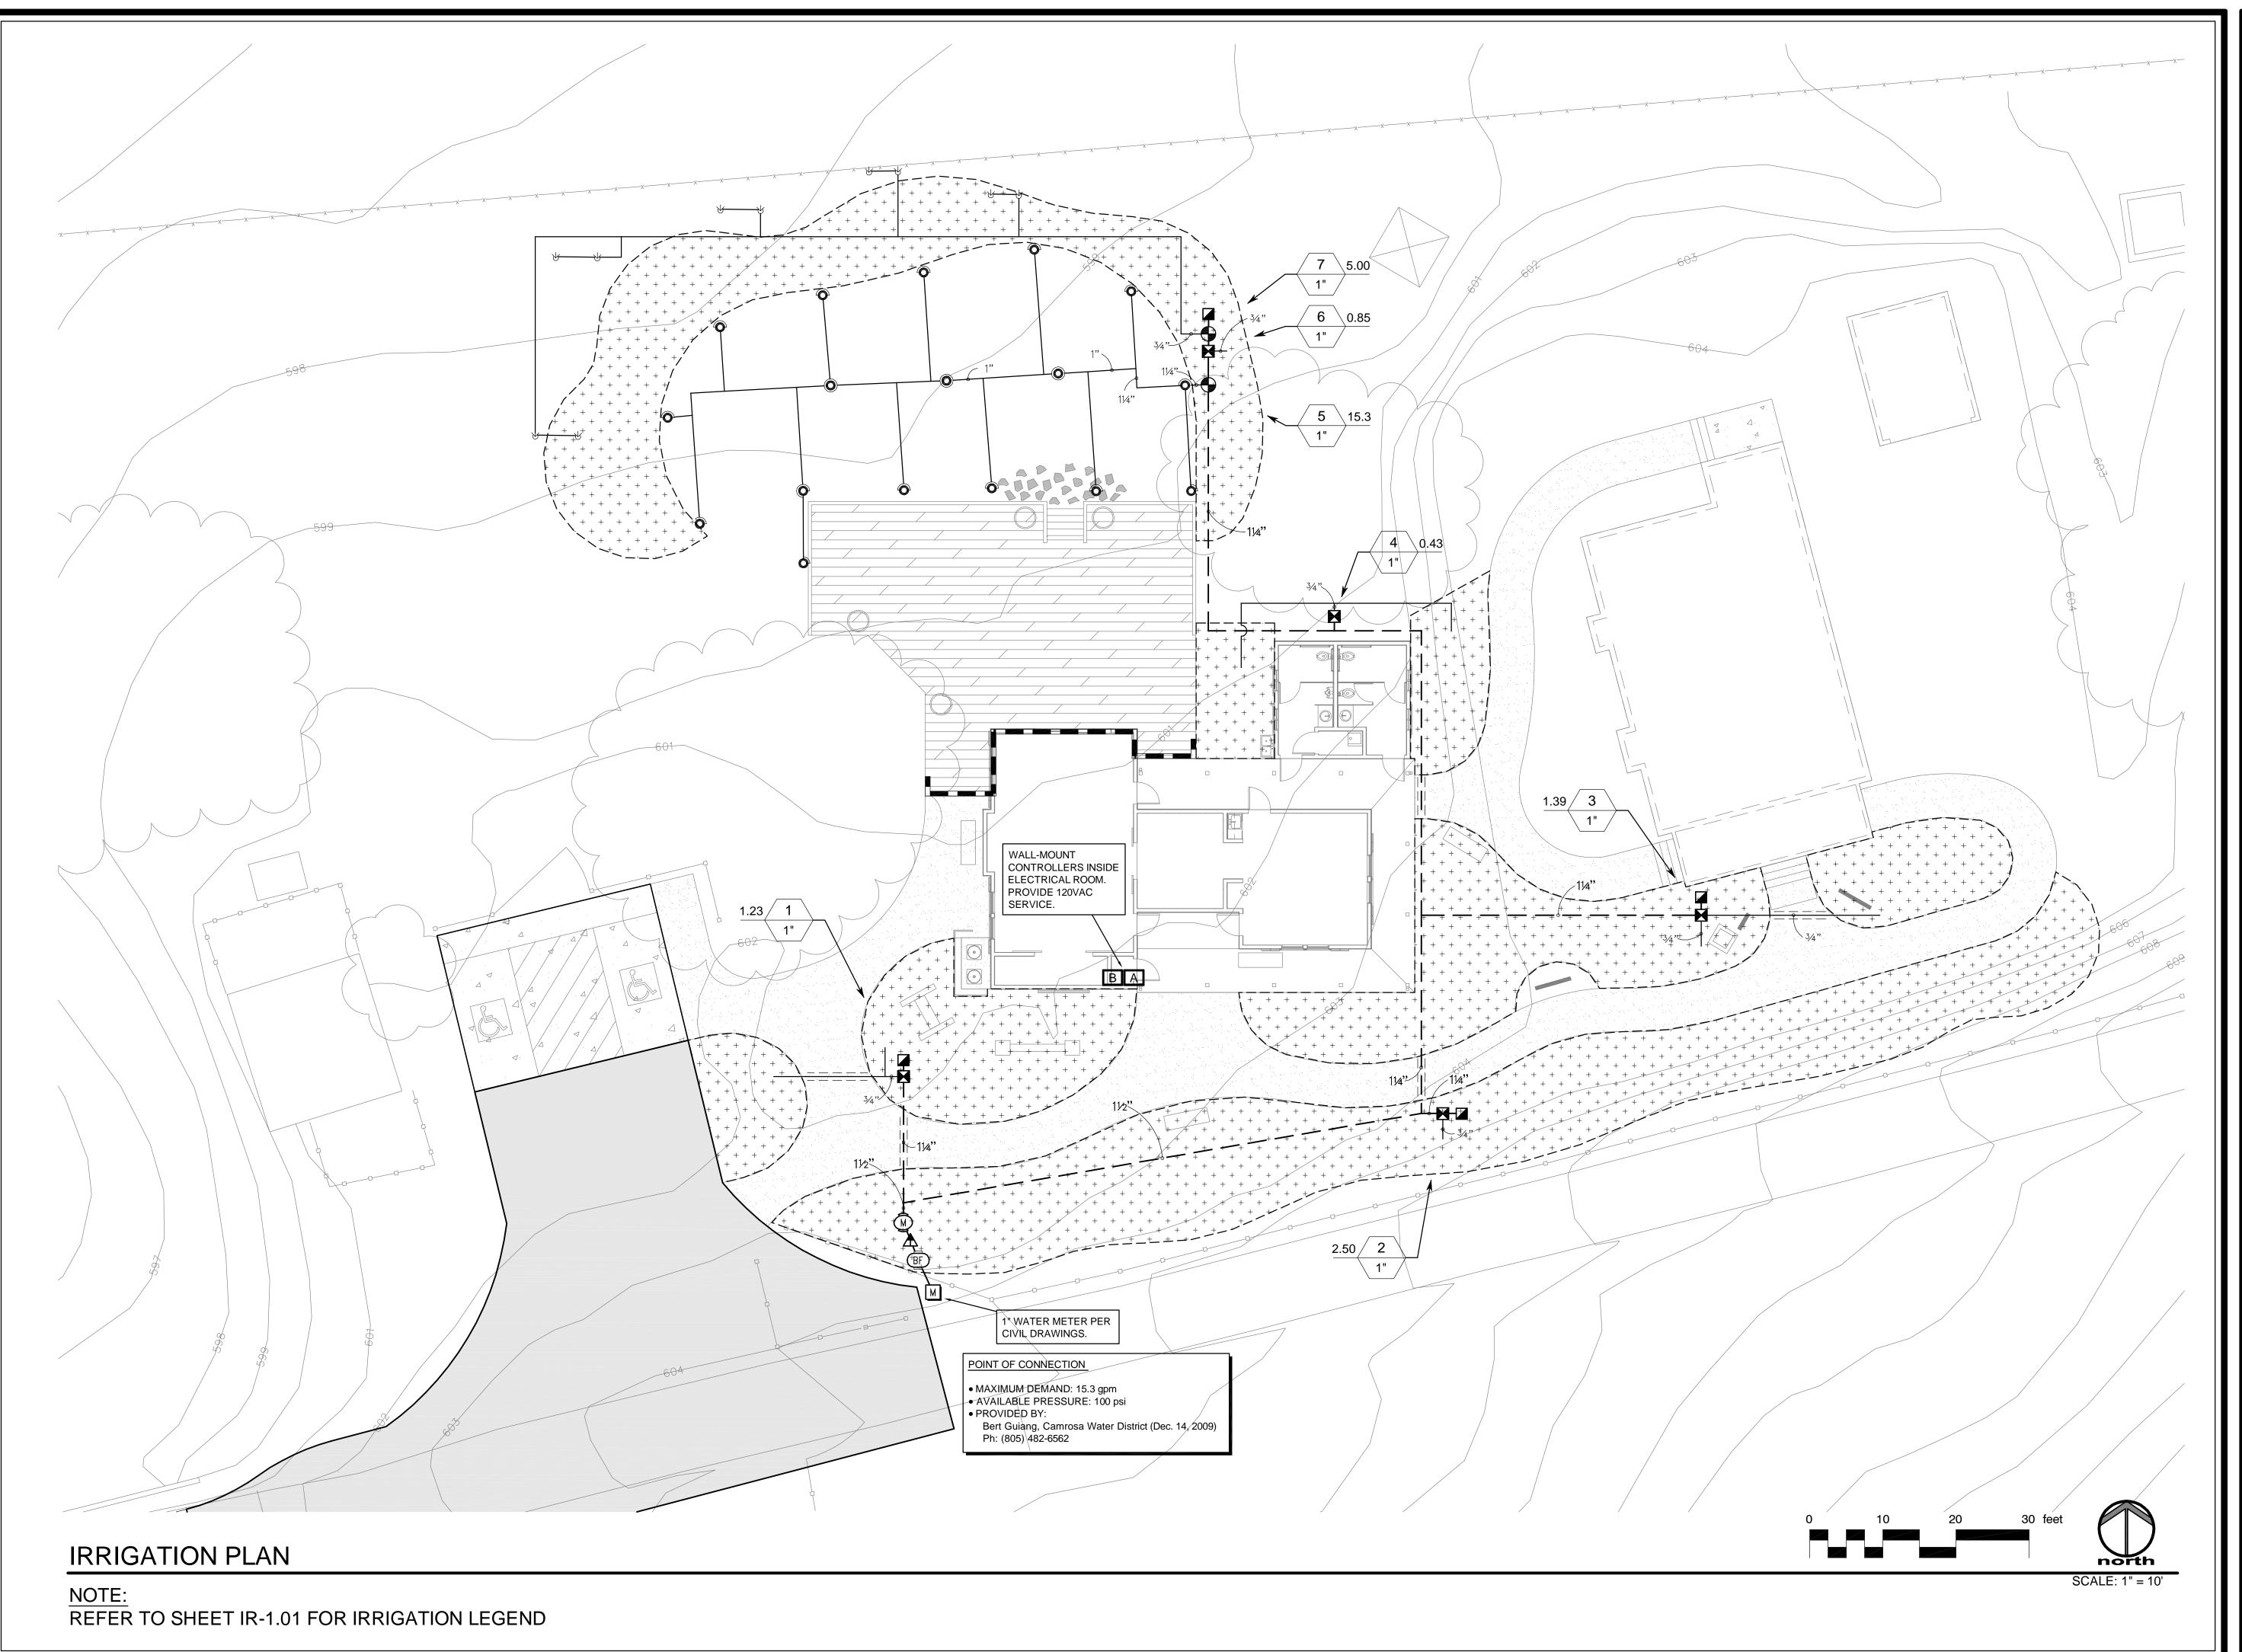CHECKED BY

DATE

April 23, 2010


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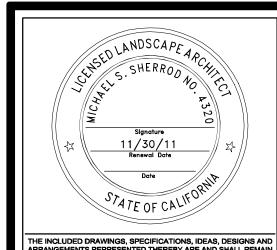
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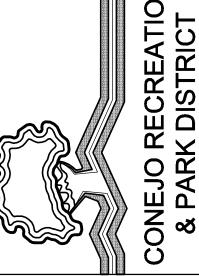
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SHEET






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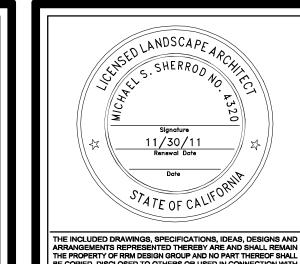



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MCCREA RANCH
//SITOR CENTER
IRRIGATION DETAILS

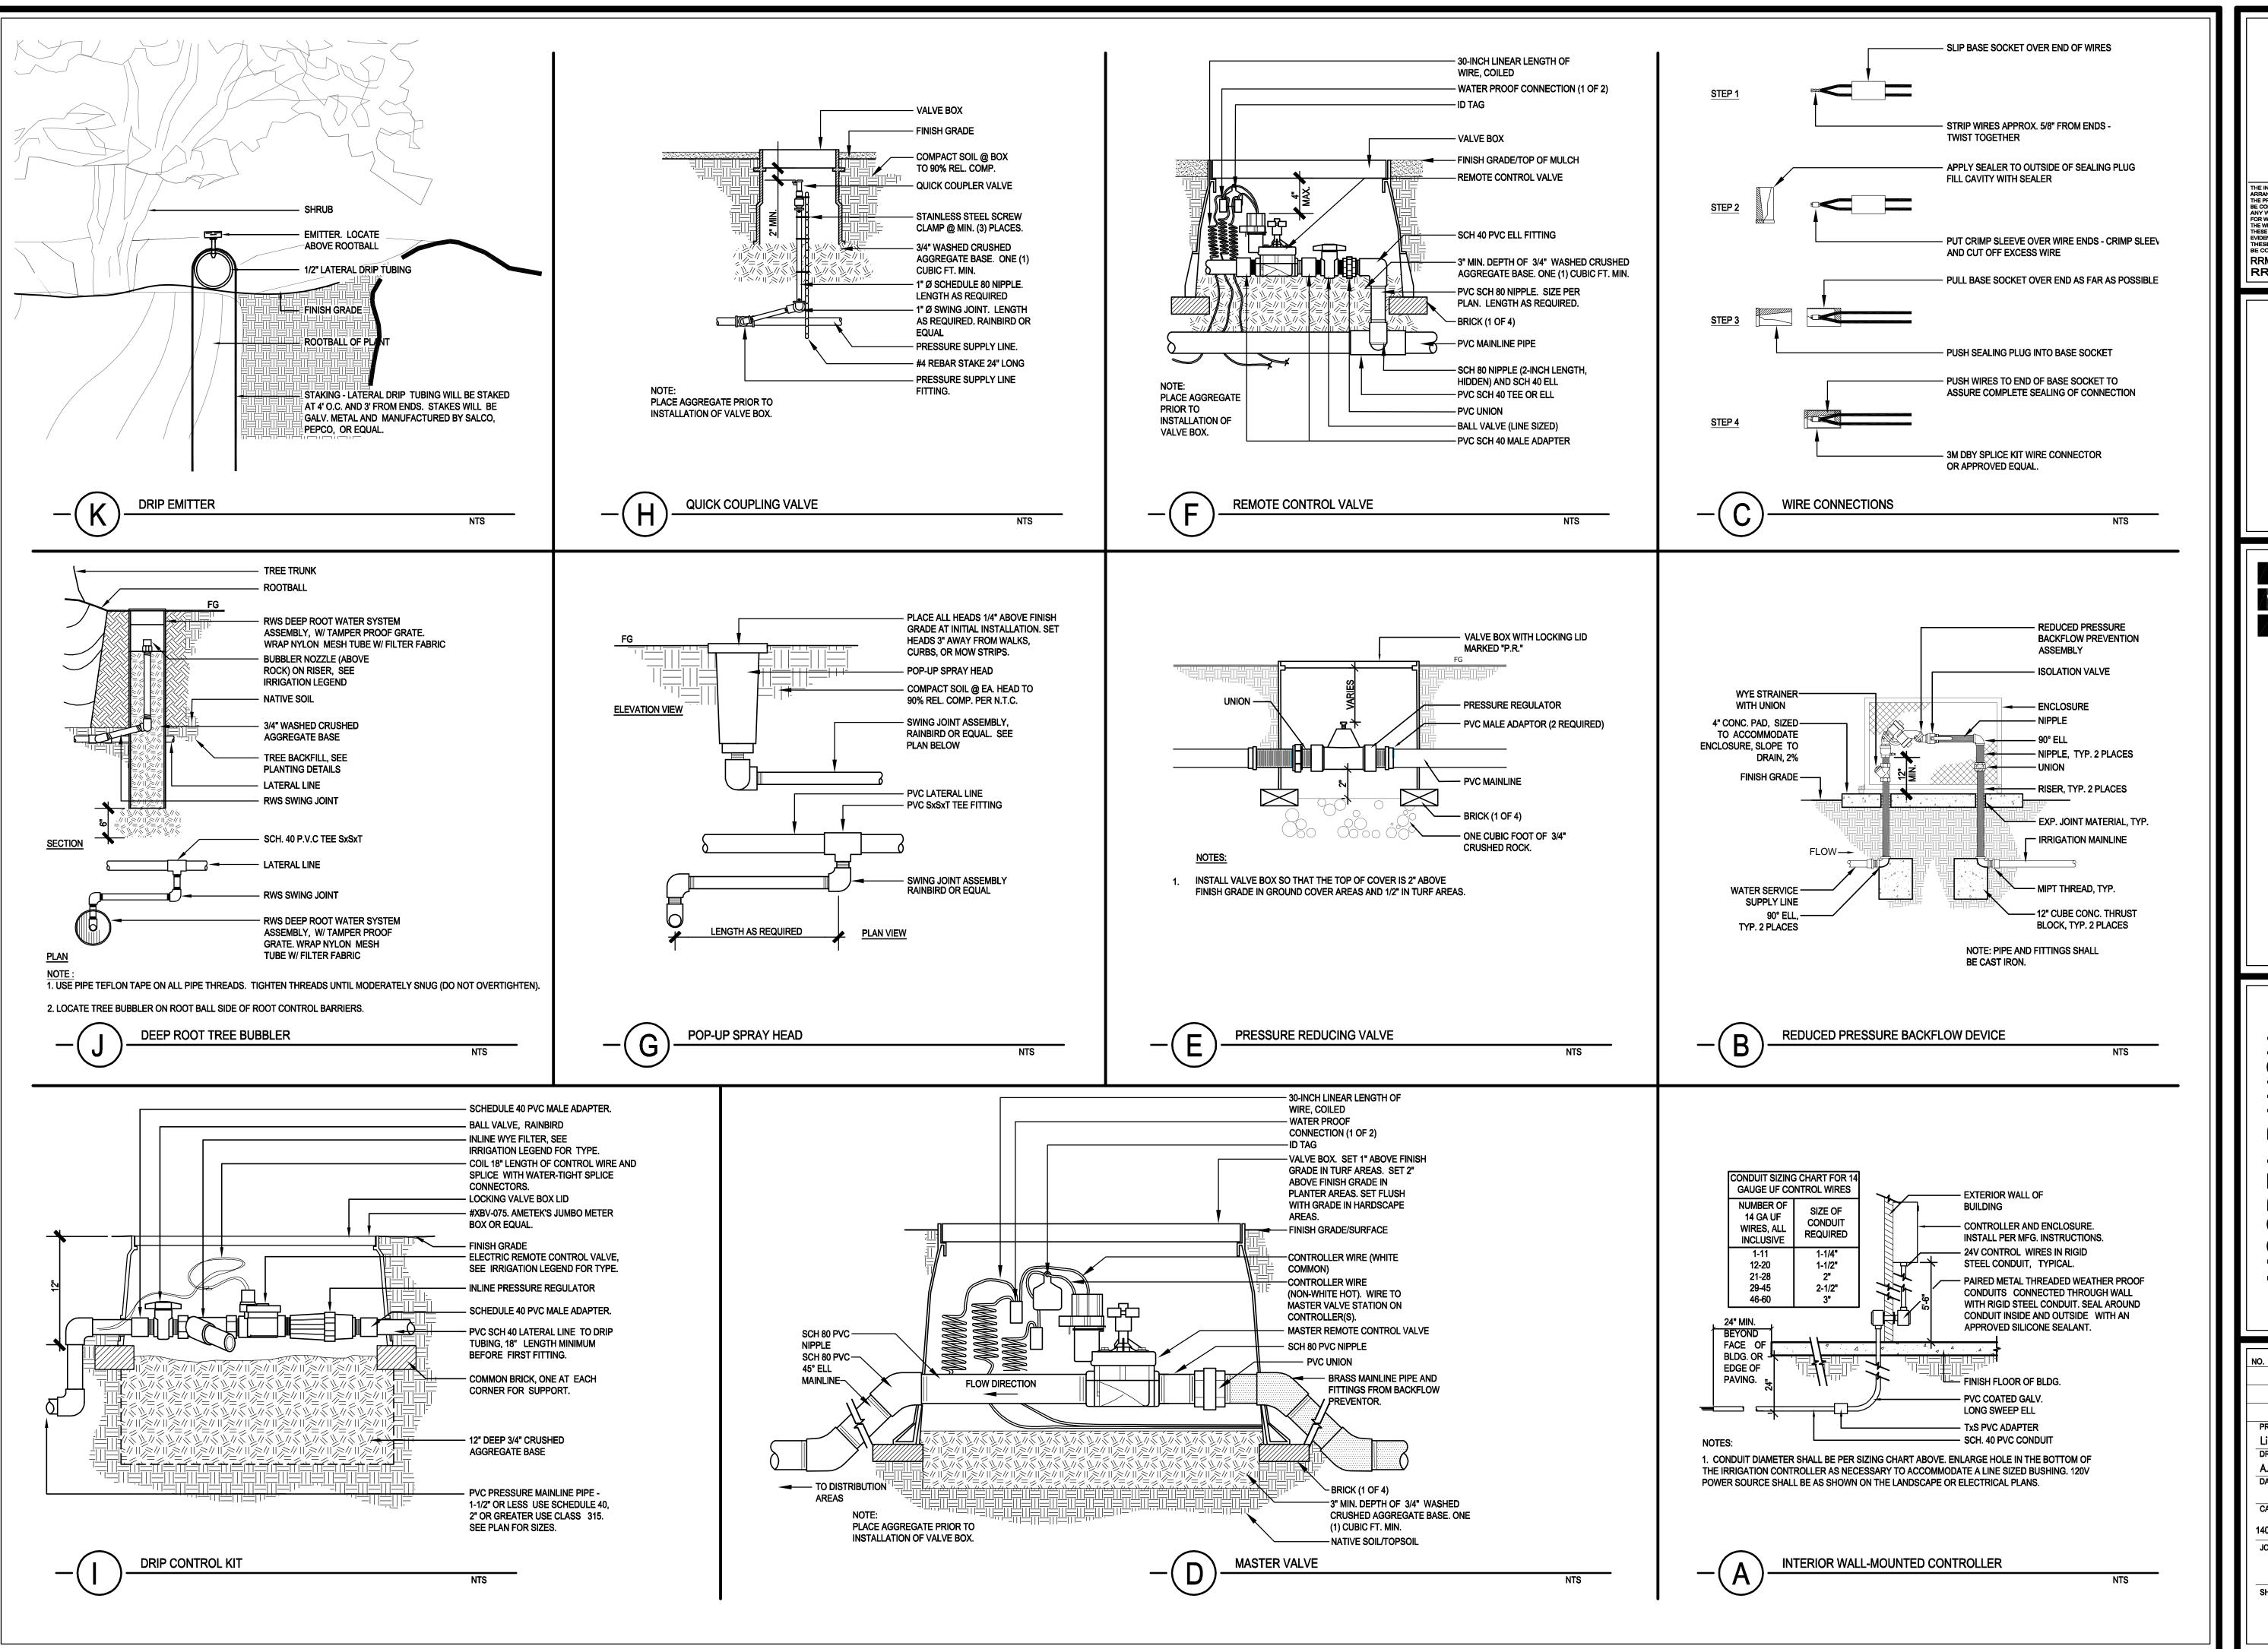PROJECT MANAGER
Lief McKay
DRAWN BY
A.K.
L.M.
DATE


April 23, 2010

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IR-3.02

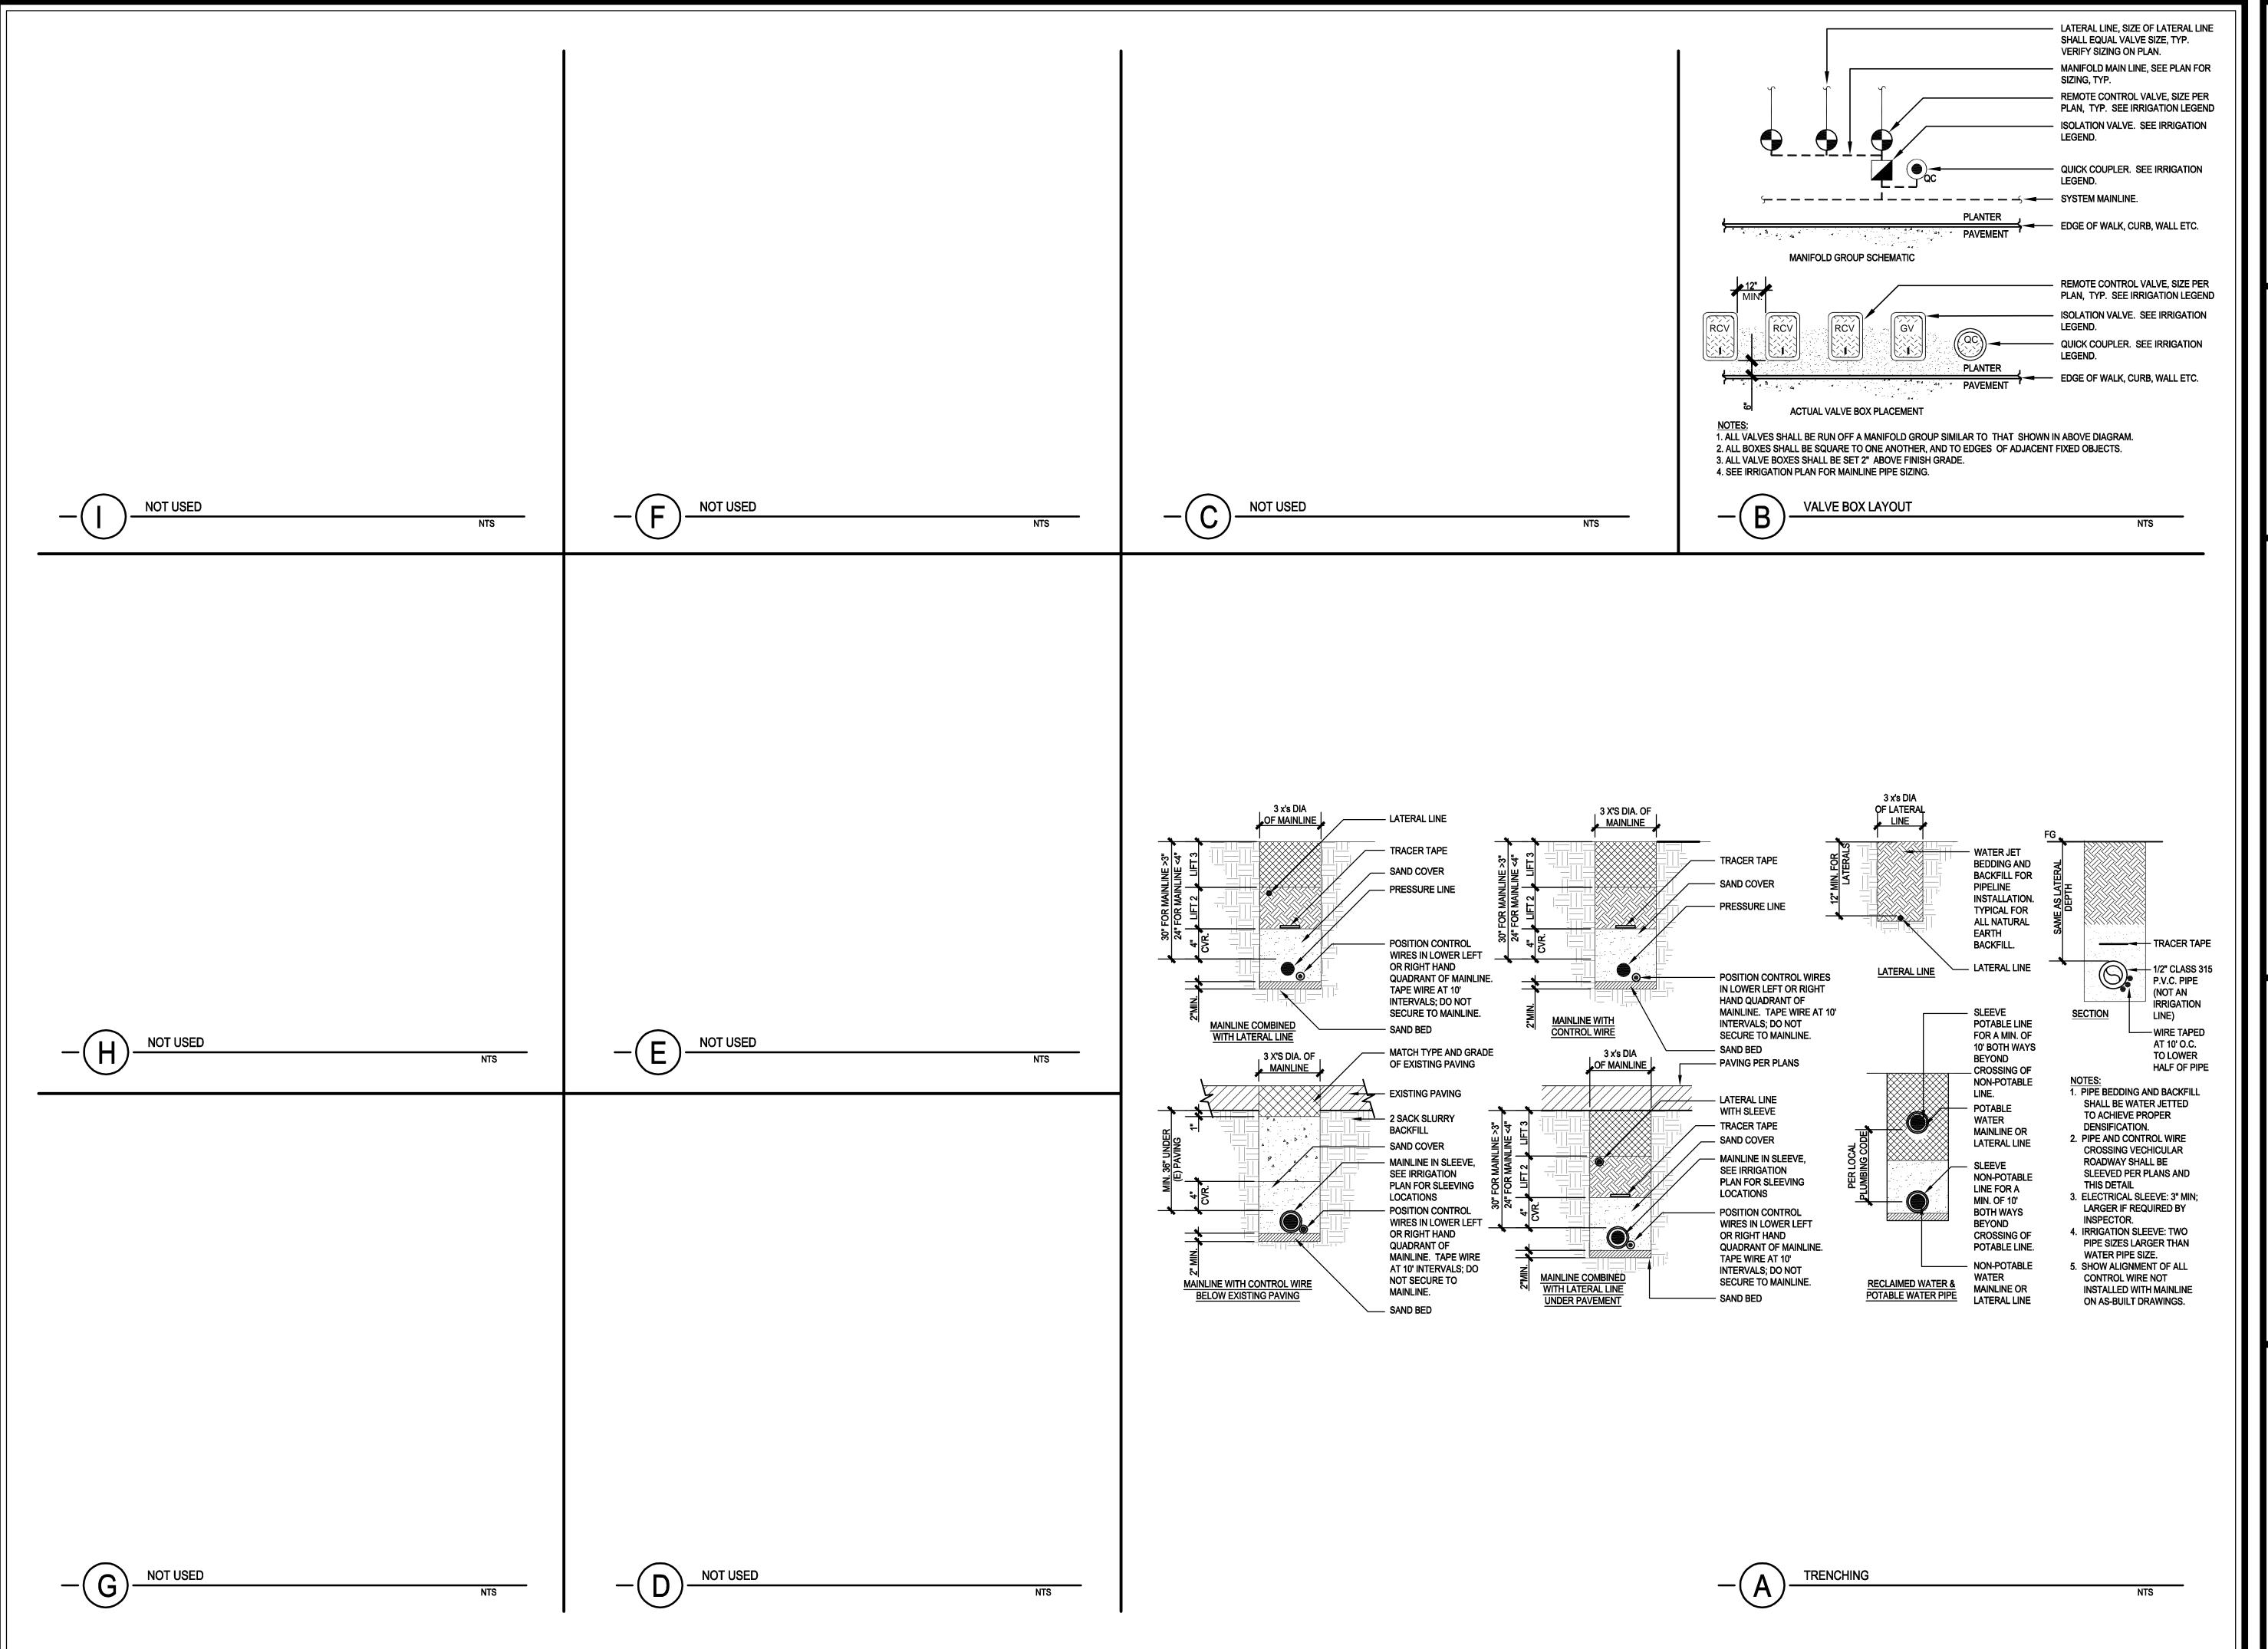

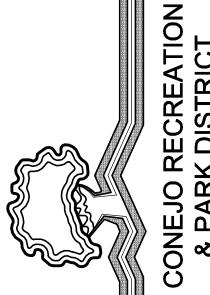PLANT SCHEDULE


LANT OUT					
TREES	BOTANICAL NAME	COMMON NAME	CONT	QTY	DETAIL
• • • • • • • • • • • • • • • • • • • •	Quercus agrifolia	Coast Live Oak Multi-Trunk	24"box	2	DETAIL E, THIS SHEE
	• Quercus lobata		24"box	3	DETAIL E, THIS SHEE
SHRUBS	BOTANICAL NAME	COMMON NAME	CONT	<u>QTY</u>	
	Eriogonum arborescens	Santa Cruz Island Buckwheat	5 gal	19	DETAIL A, THIS SHEE
	Rosa californica	California Wild Rose	5 gal	4	DETAIL A, THIS SHEE
	Salvia leucophylla	Purple Leaf Sage	5 gal	23	DETAIL A, THIS SHEE
ANNUALS/PERENNIALS	BOTANICAL NAME	COMMON NAME	CONT	<u>QTY</u>	
	Romneya coulteri	Matilija Poppy	5 gal	15	DETAIL A, THIS SHEE
GRASSES	BOTANICAL NAME	COMMON NAME	CONT	<u>QTY</u>	
	Muhlenbergia rigens	Deer Grass	5 gal	81	DETAIL A, THIS SHEE
\\\\\\\\\\\\\\\\\\\\\\\\\\\\\\\\\\\\\\	Stipa cernua	Nodding Needlegrass	1 gal	155	DETAIL A, THIS SHEE
	Stipa pulchra	Purple Needle Grass	1 gal	204	DETAIL A, THIS SHEE
SUCCULENTS	BOTANICAL NAME	COMMON NAME	CONT	<u>QTY</u>	
	Agave attenuata	Agave	5 gal	17	DETAIL A &
VINE/ESPALIER	BOTANICAL NAME	COMMON NAME	CONT	<u>QTY</u>	
Δ	Rosa banksiae `Lutea`	Yellow Banks Rose Espalier	5 gal	11	DETAIL D, THIS SHEE
GROUND COVERS	BOTANICAL NAME	COMMON NAME	CONT	<u>QTY</u>	
	Arctostaphylos densiflora `Emerald Carpet`	Emerald Carpet Manzanita	1 gal@ 36" oc	93	DETAIL B, THIS SHEE
SOD/SEED	BOTANICAL NAME	COMMON NAME	CONT	QTY	
	Buchloe dactyloides `Prestige`	Prestige Buffalo Grass	Sod	2,257 9	sf
MULCH			(QTY_	
	Oak Leaf Mulch		1	,067 sf	

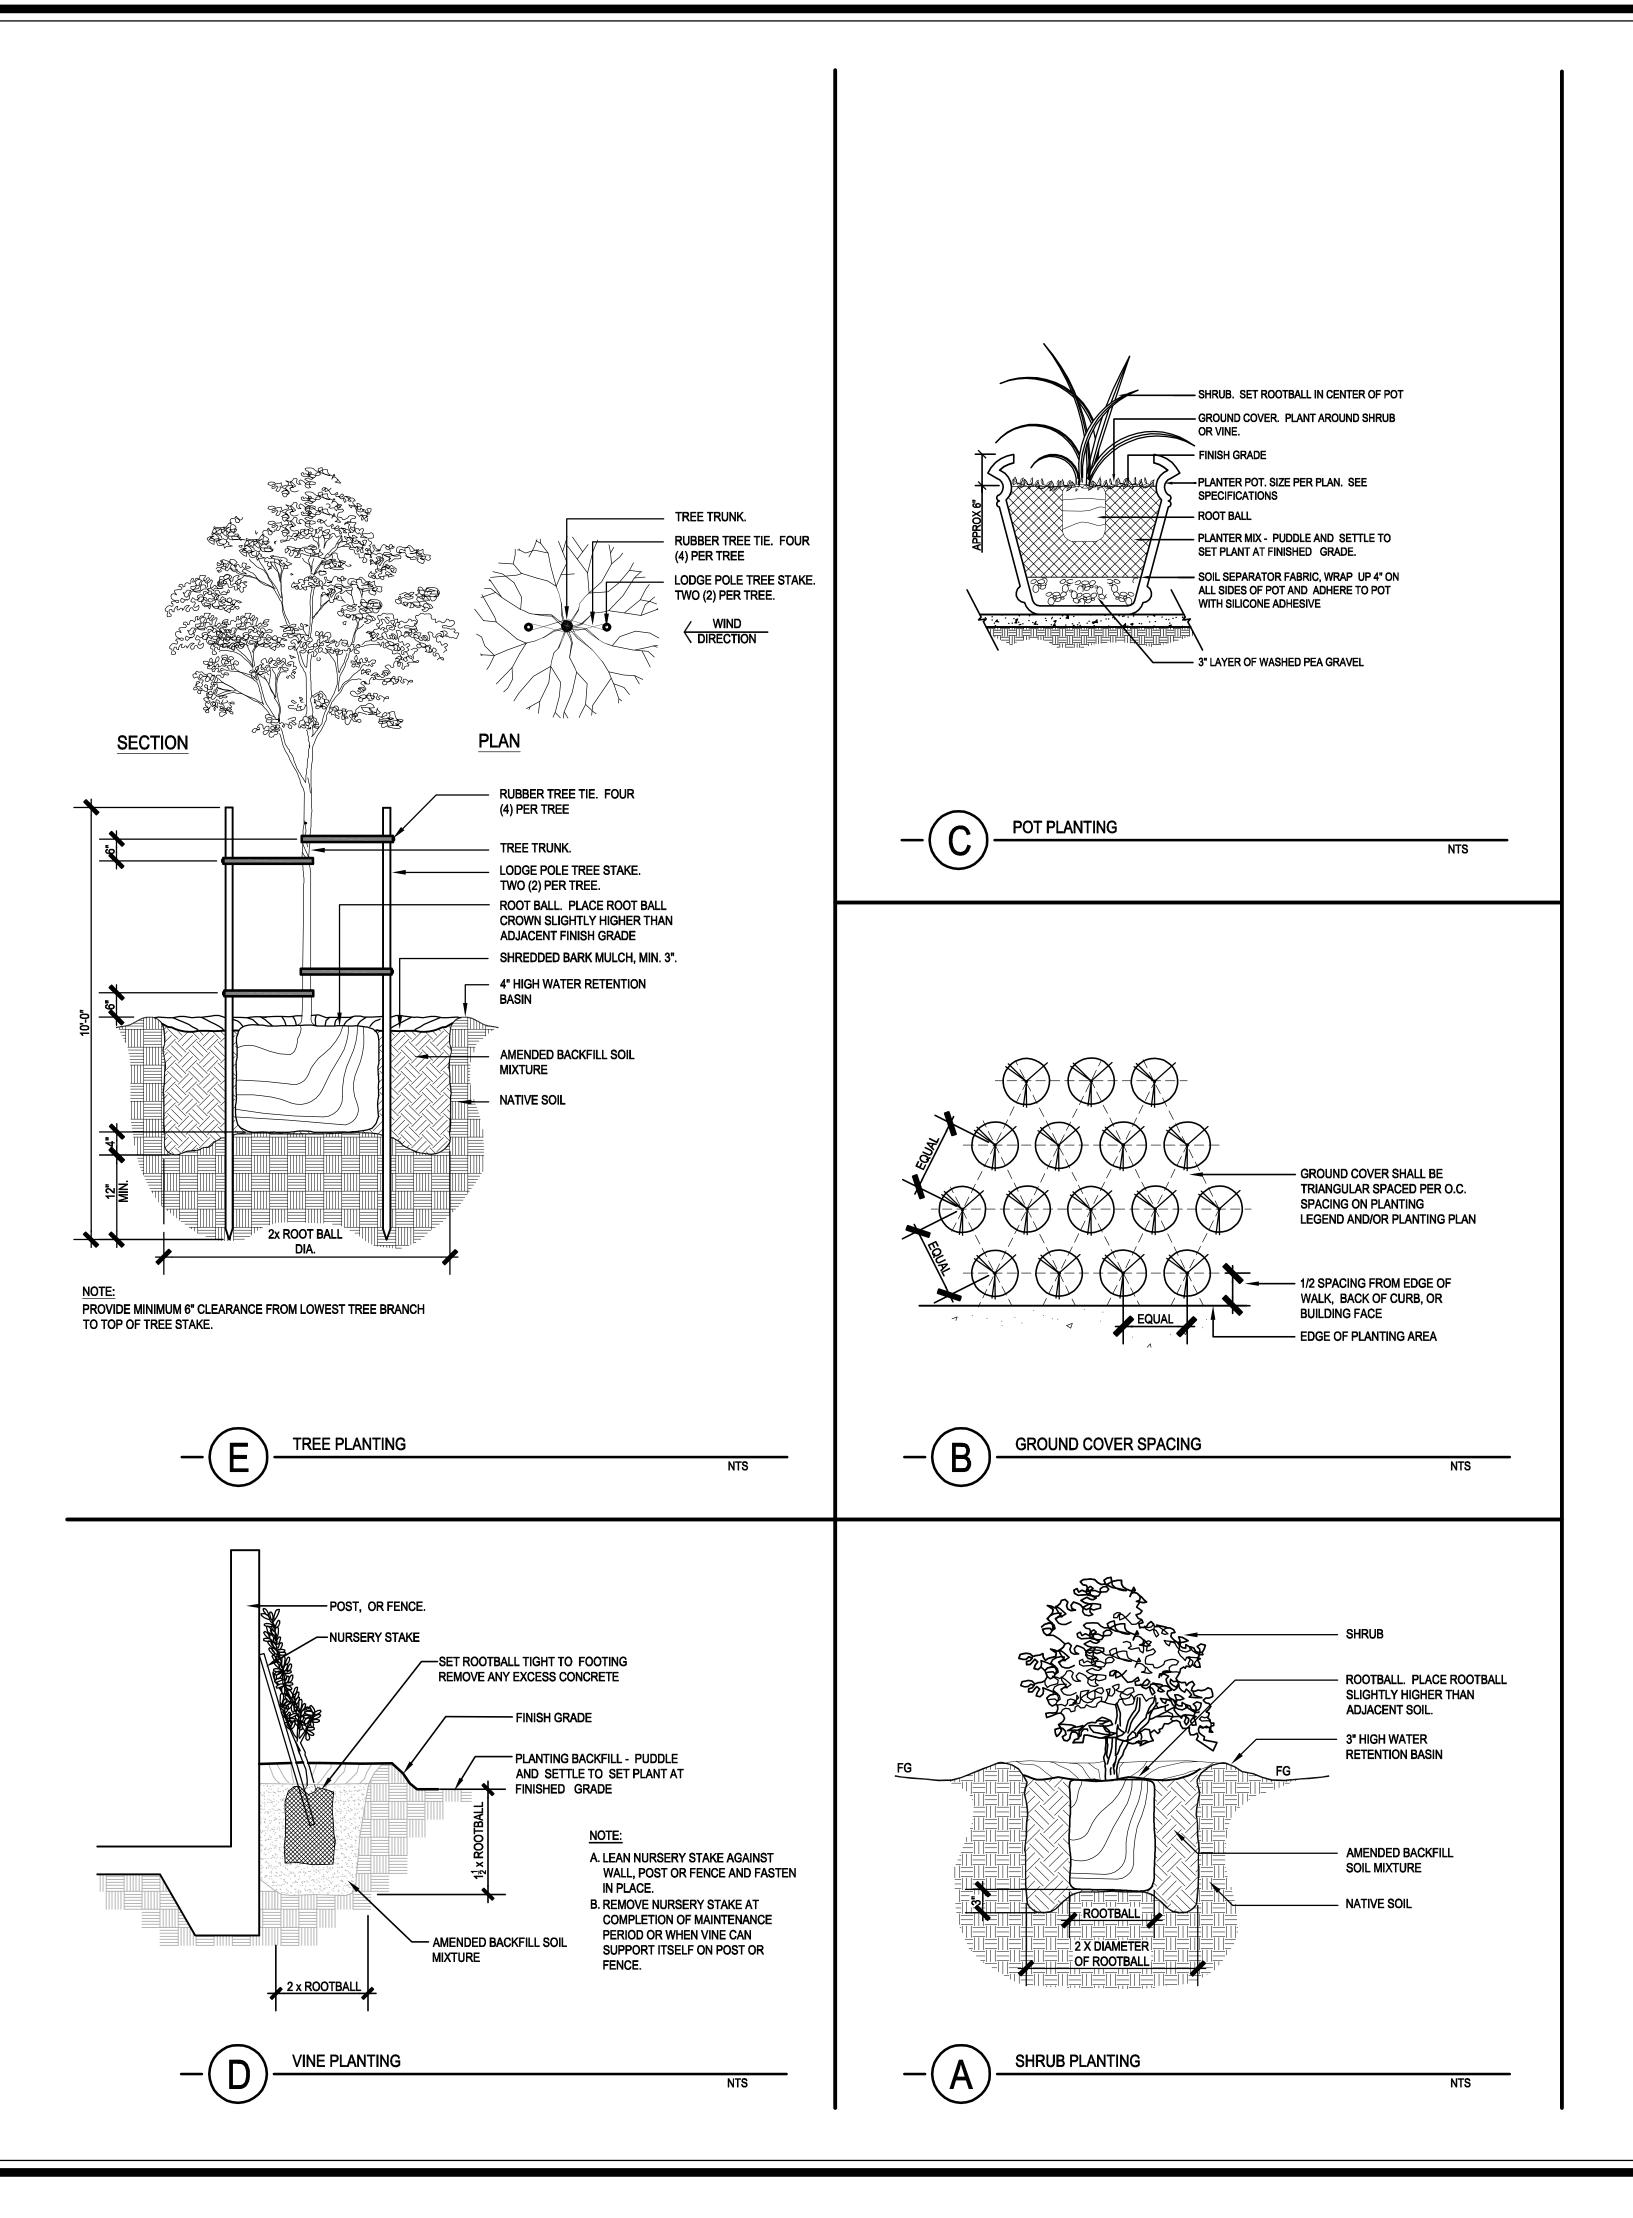PLANTING NOTES

- 1. PLANT LIST IS FOR CONVENIENCE OF CONTRACTOR ONLY. IN CASE OF DISCREPANCIES BETWEEN THE PLANS AND THE LIST, PLANS
- SHALL PREVAIL.

 2. PLANT LOCATIONS SHOWN ON THE PLANS ARE DIAGRAMMATIC. CONTRACTOR SHALL LOCATE ALL PLANT MATERIAL UNDER THE DIRECTION OF THE AUTHORIZED REPRESENTATIVE PRIOR TO PLANTING HOLE EXCAVATION.

 THE AUTHORIZED REPRESENTATIVE RESERVES THE RIGHT TO MAKE SUBSTITUTIONS, ADDITIONS, AND DELETIONS TO THE PLANTING
- LAYOUT AS WORK PROGRESSES.
- 4. ALL GROUNDCOVER SHALL BE TRIANGULARLY SPACED UNLESS OTHERWISE NOTED.
- 5. CONTRACTOR SHALL INSTALL A 3" LAYER OF 'STRINGY CEDAR BARK' MULCH IN ALL PLANTING AREAS.
- 6. OAK LEAF MULCH SHALL BE 5" THICK.

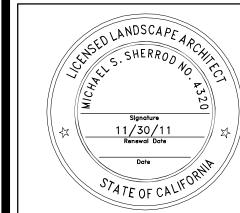


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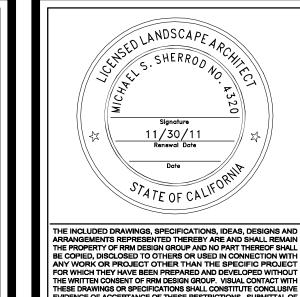


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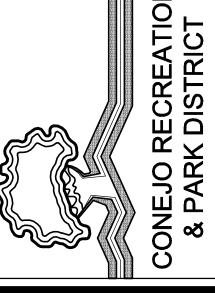




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PROJECT MANAGER
Lief McKay
DRAWN BY
A.M.

CHECKED BY
L.M.

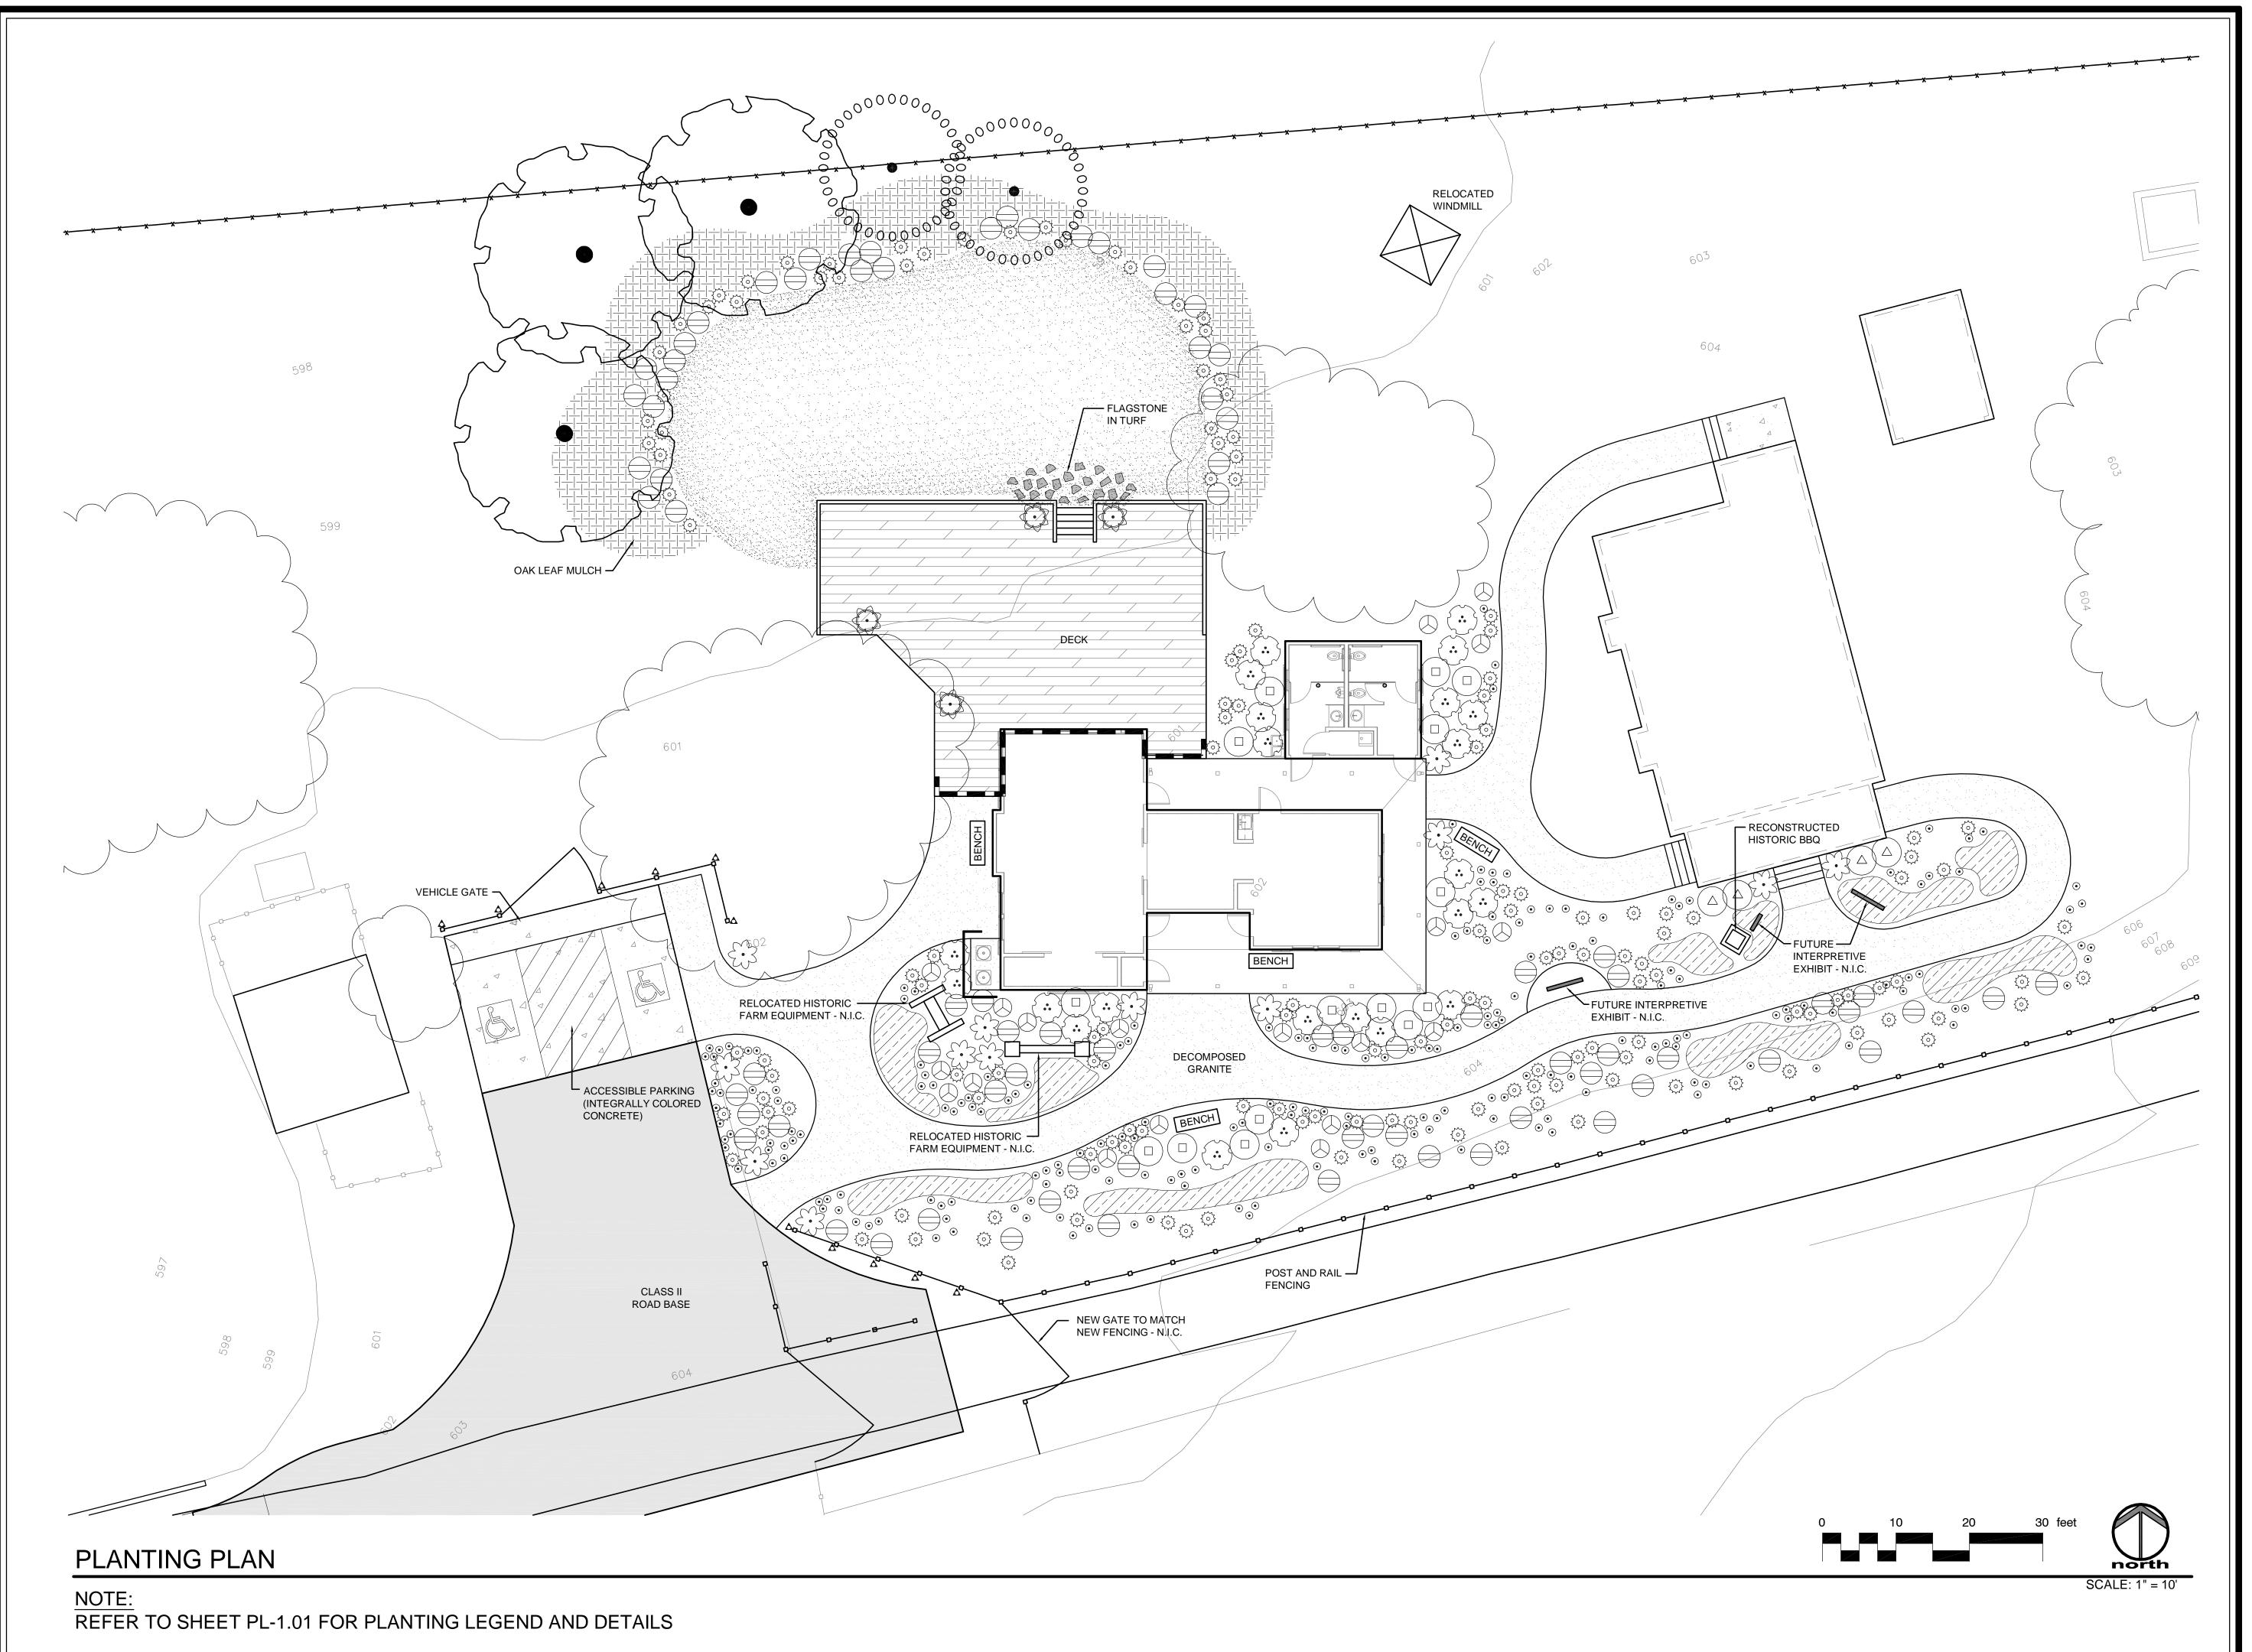DATE

April 23, 2010


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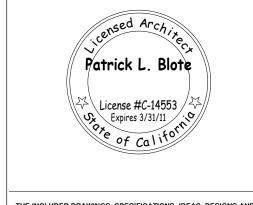
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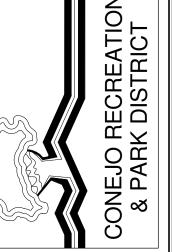
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MCCREA RANCH VISITOR CENTER
4500 N. MOORPARK RD.
THOUSAND OAKS, CALIFORNIA
ARCHITECTURAL SITE PLAN

NO. REVISION DATE

1 PLAN CHECK RESUBMITTAL 05/14/10

PROJECT MANAGER


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DATE

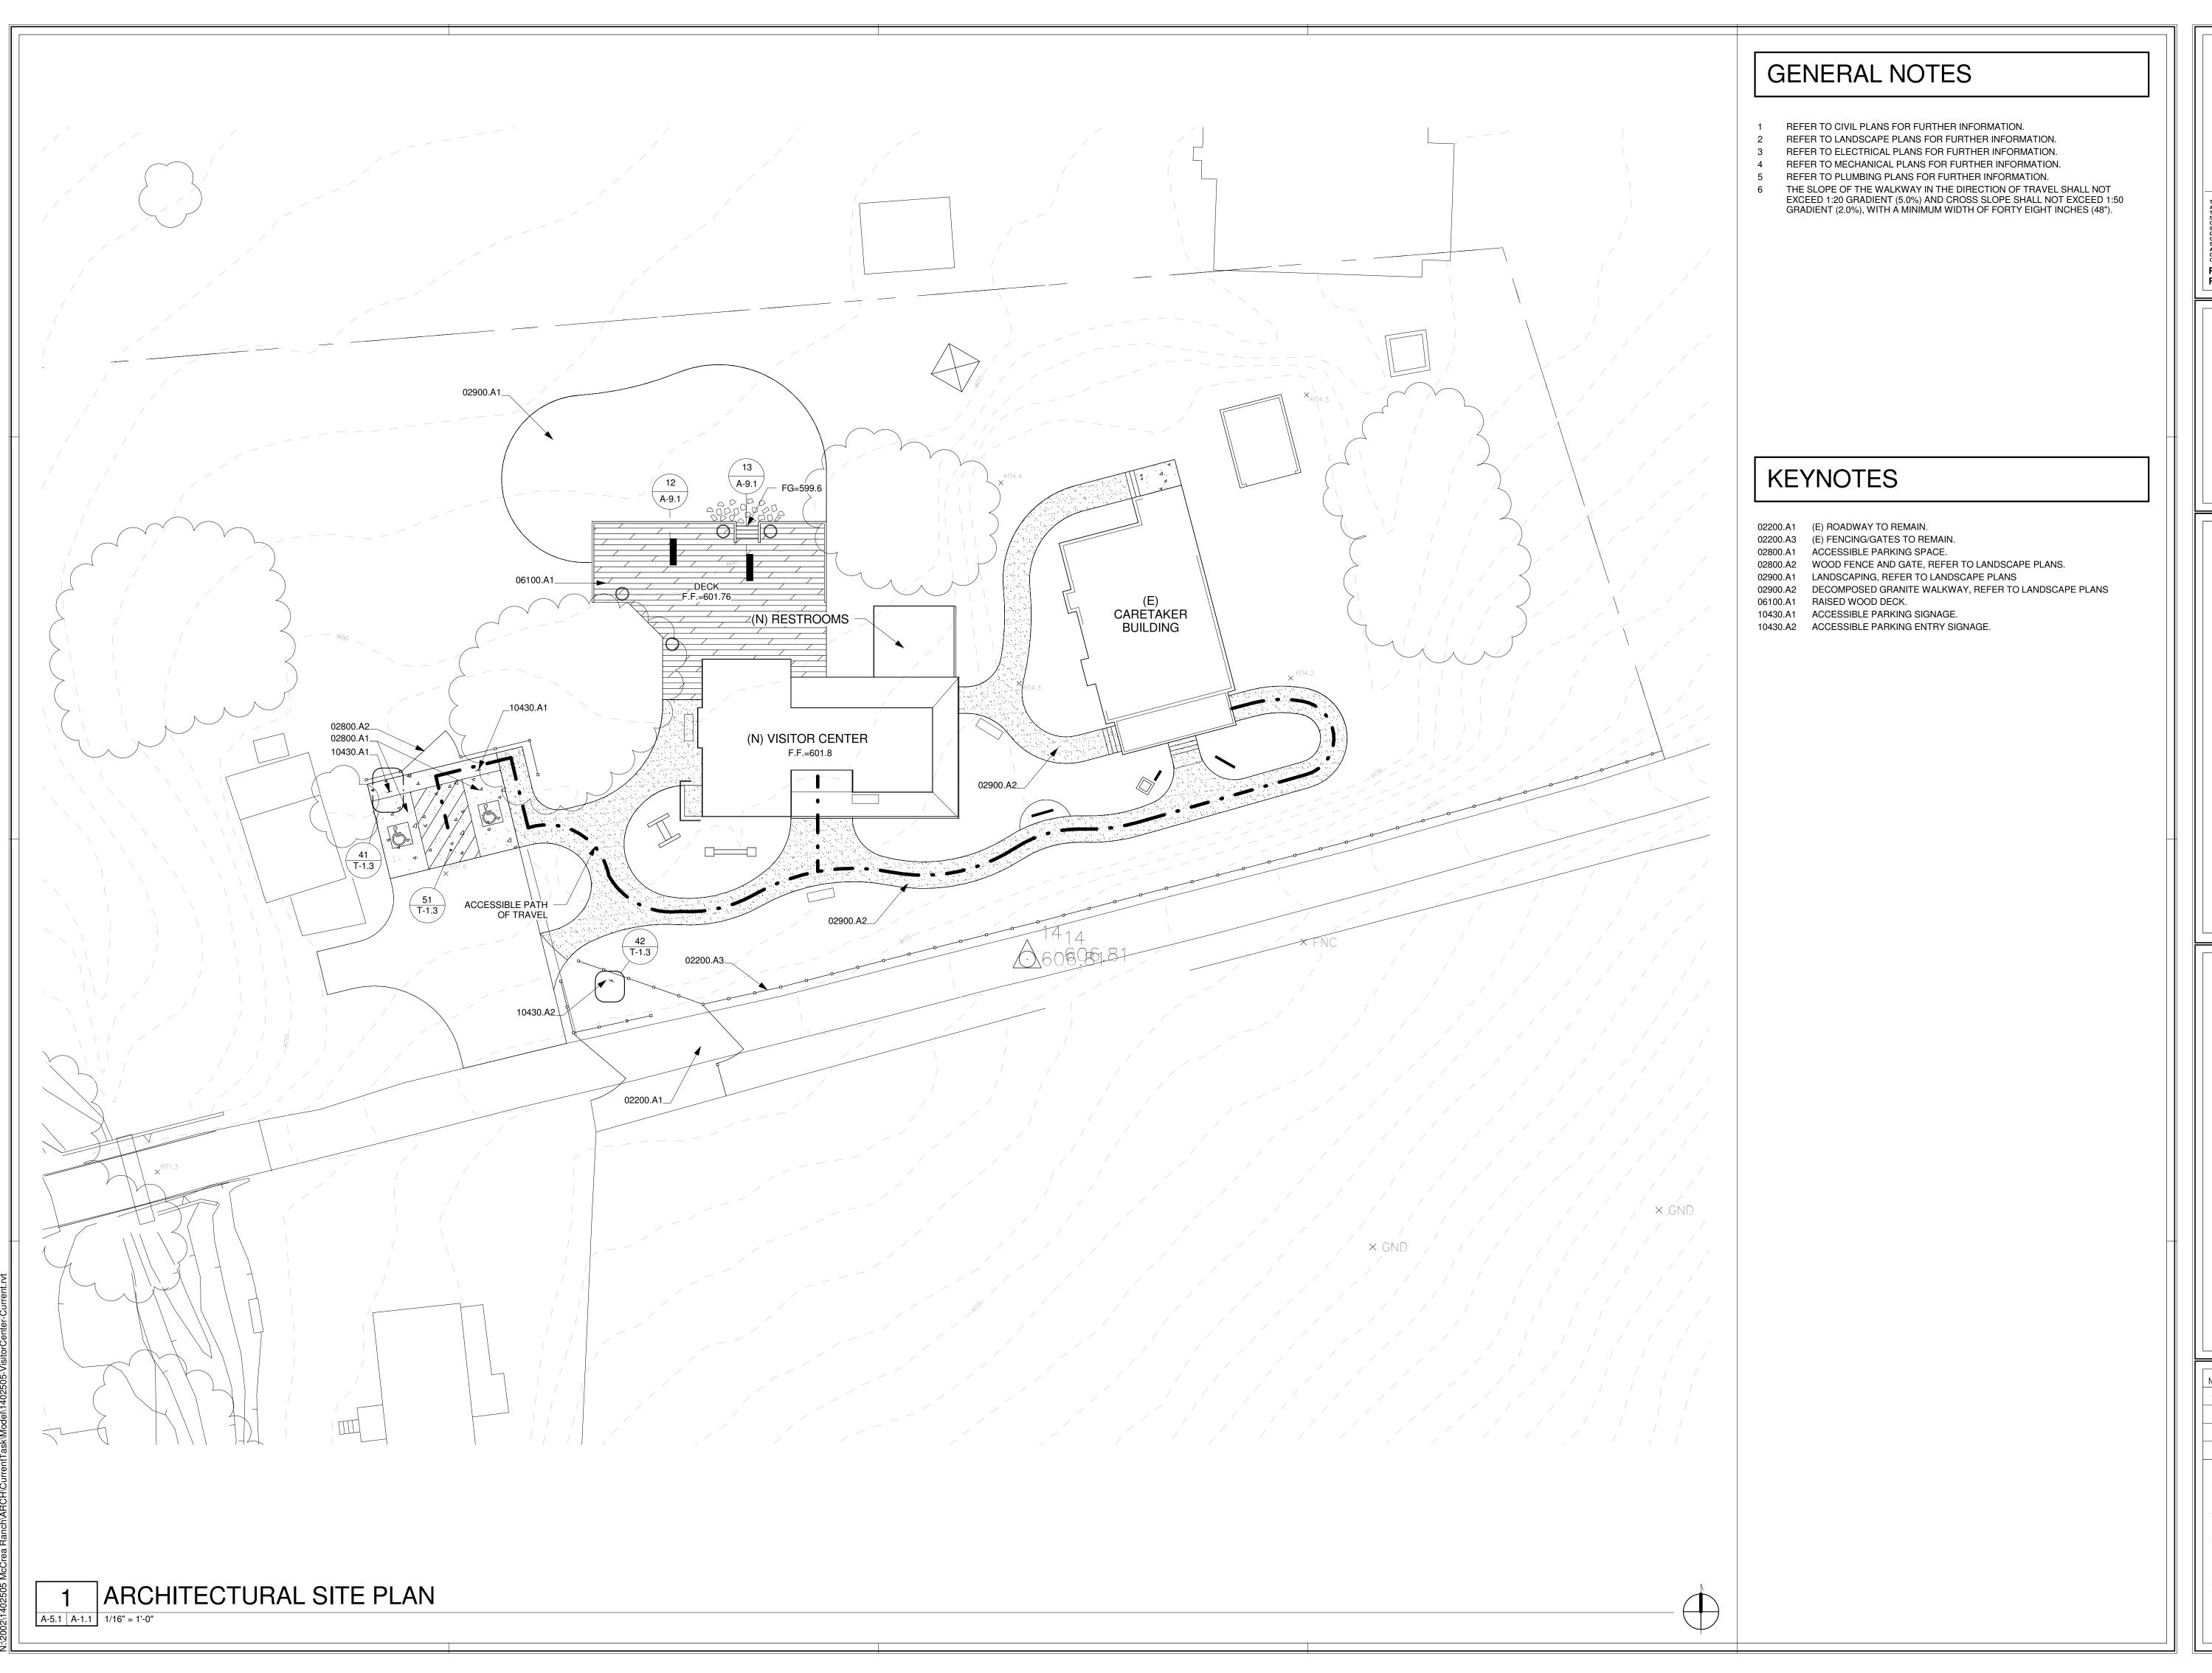FERRIJARY 01, 2010

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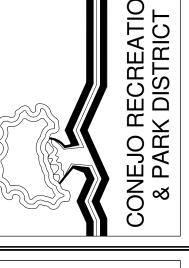
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Patrick L. Blote $^{ackslash}ackslash$ License #C-14553 $_{/}$ Expires 3/31/11

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RANCH VISITOR (4500 N. MOORPARK RD. THOUSAND OAKS, CALIFORNIA


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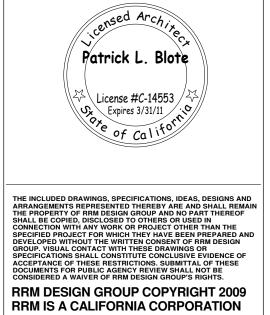
FLOOR PLAN

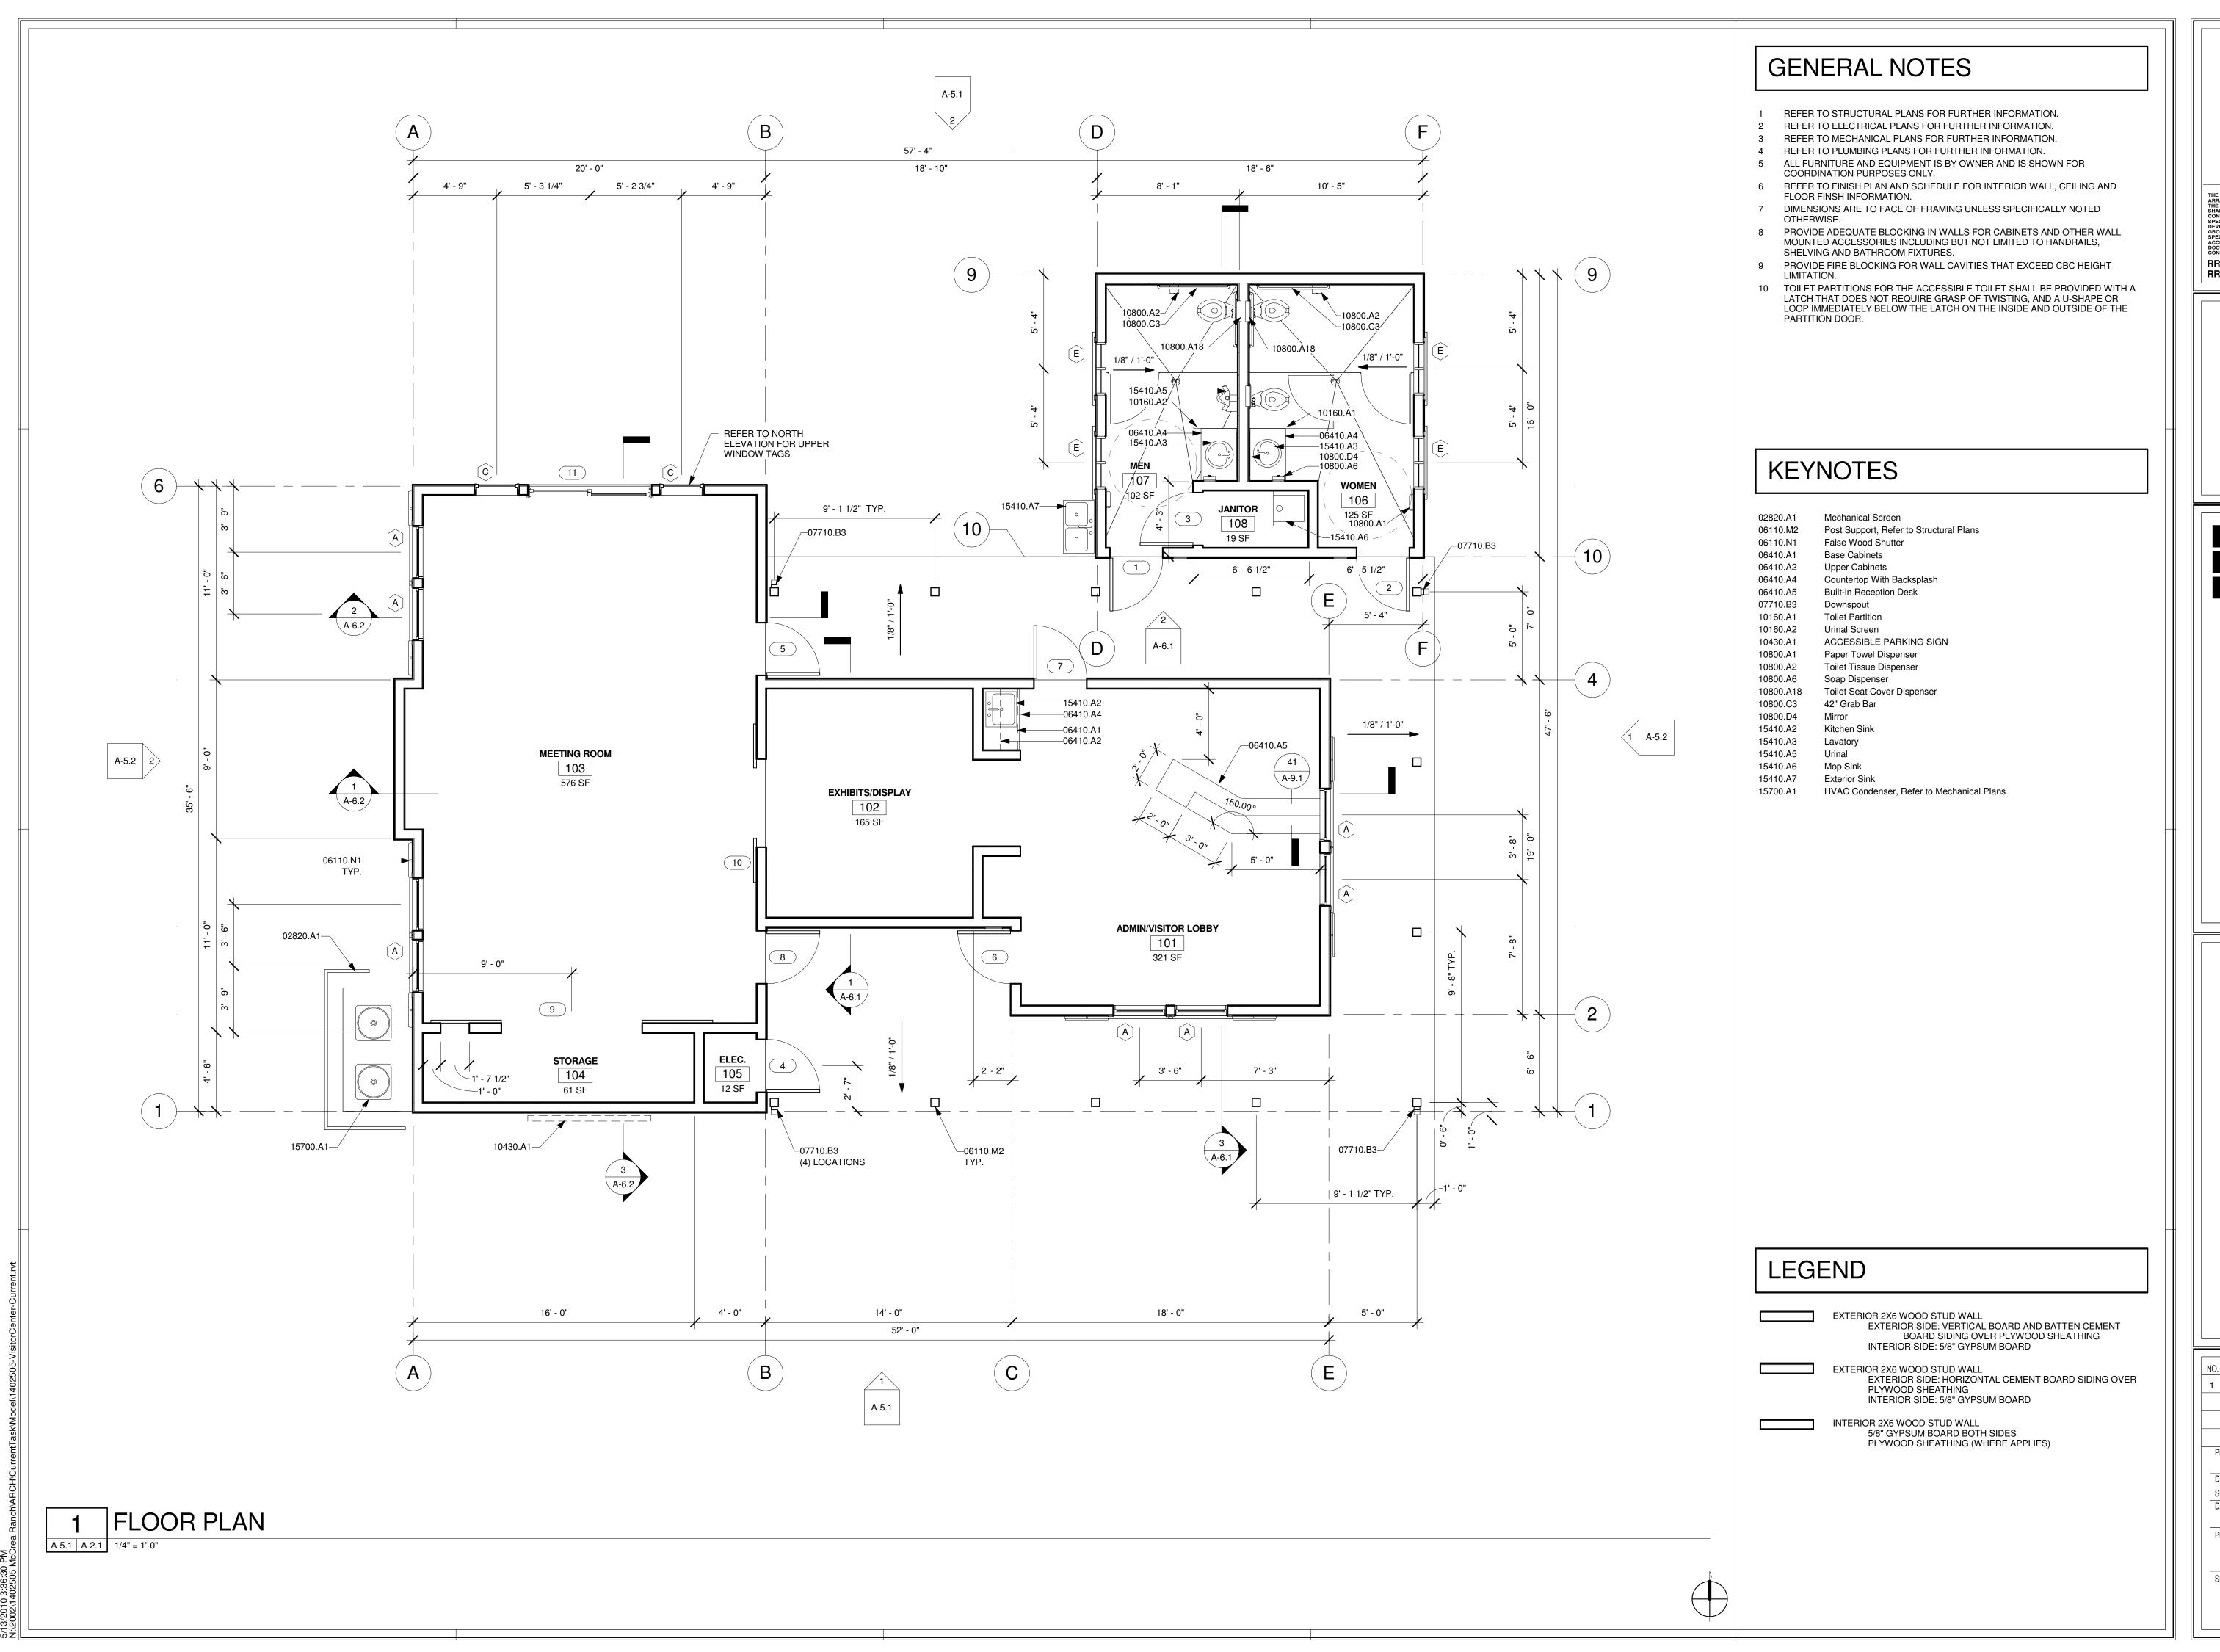
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CHECKED BY DATE

FEBRUARY 01, 2010 PROJECT NUMBER





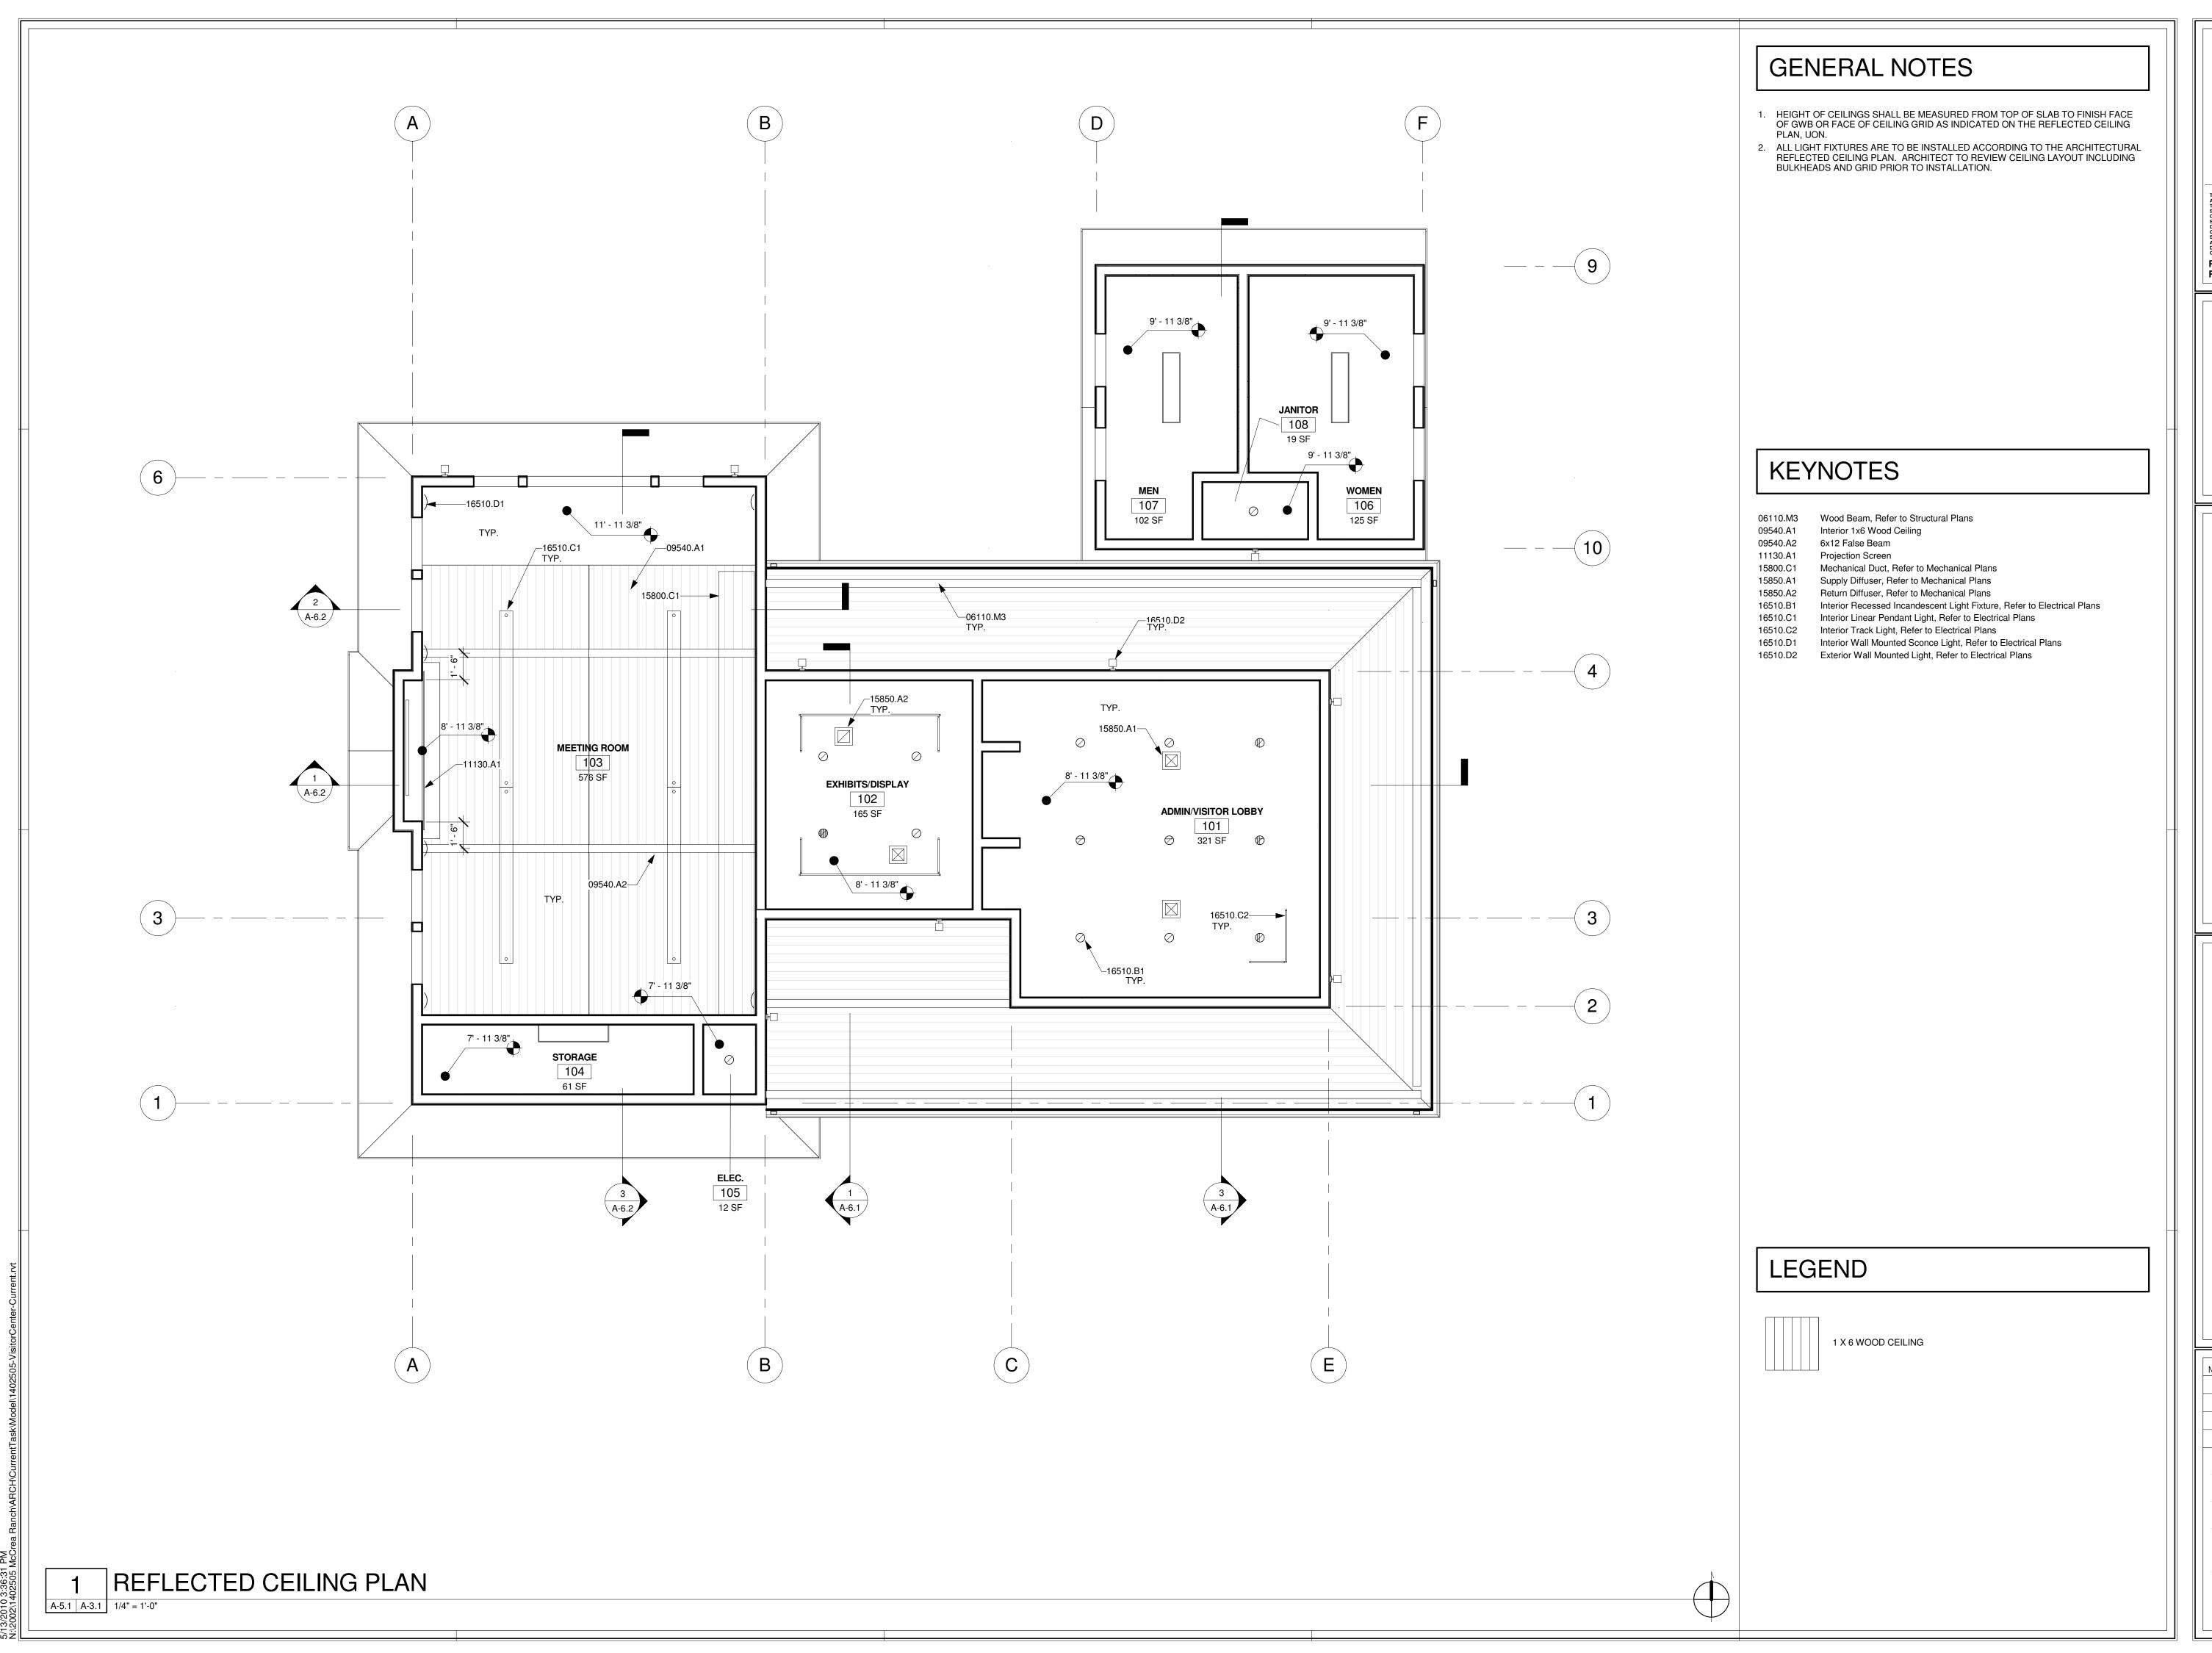

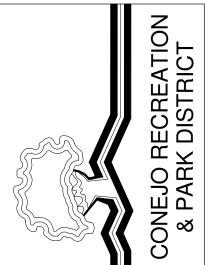


REFLECTED CEILING PLAN

MCCREA RANCH VISITOR CENTER
4500 N. MOORPARK RD.
THOUSAND OAKS, CALIFORNIA

NO. REVISION

FEBRUARY 01, 2010

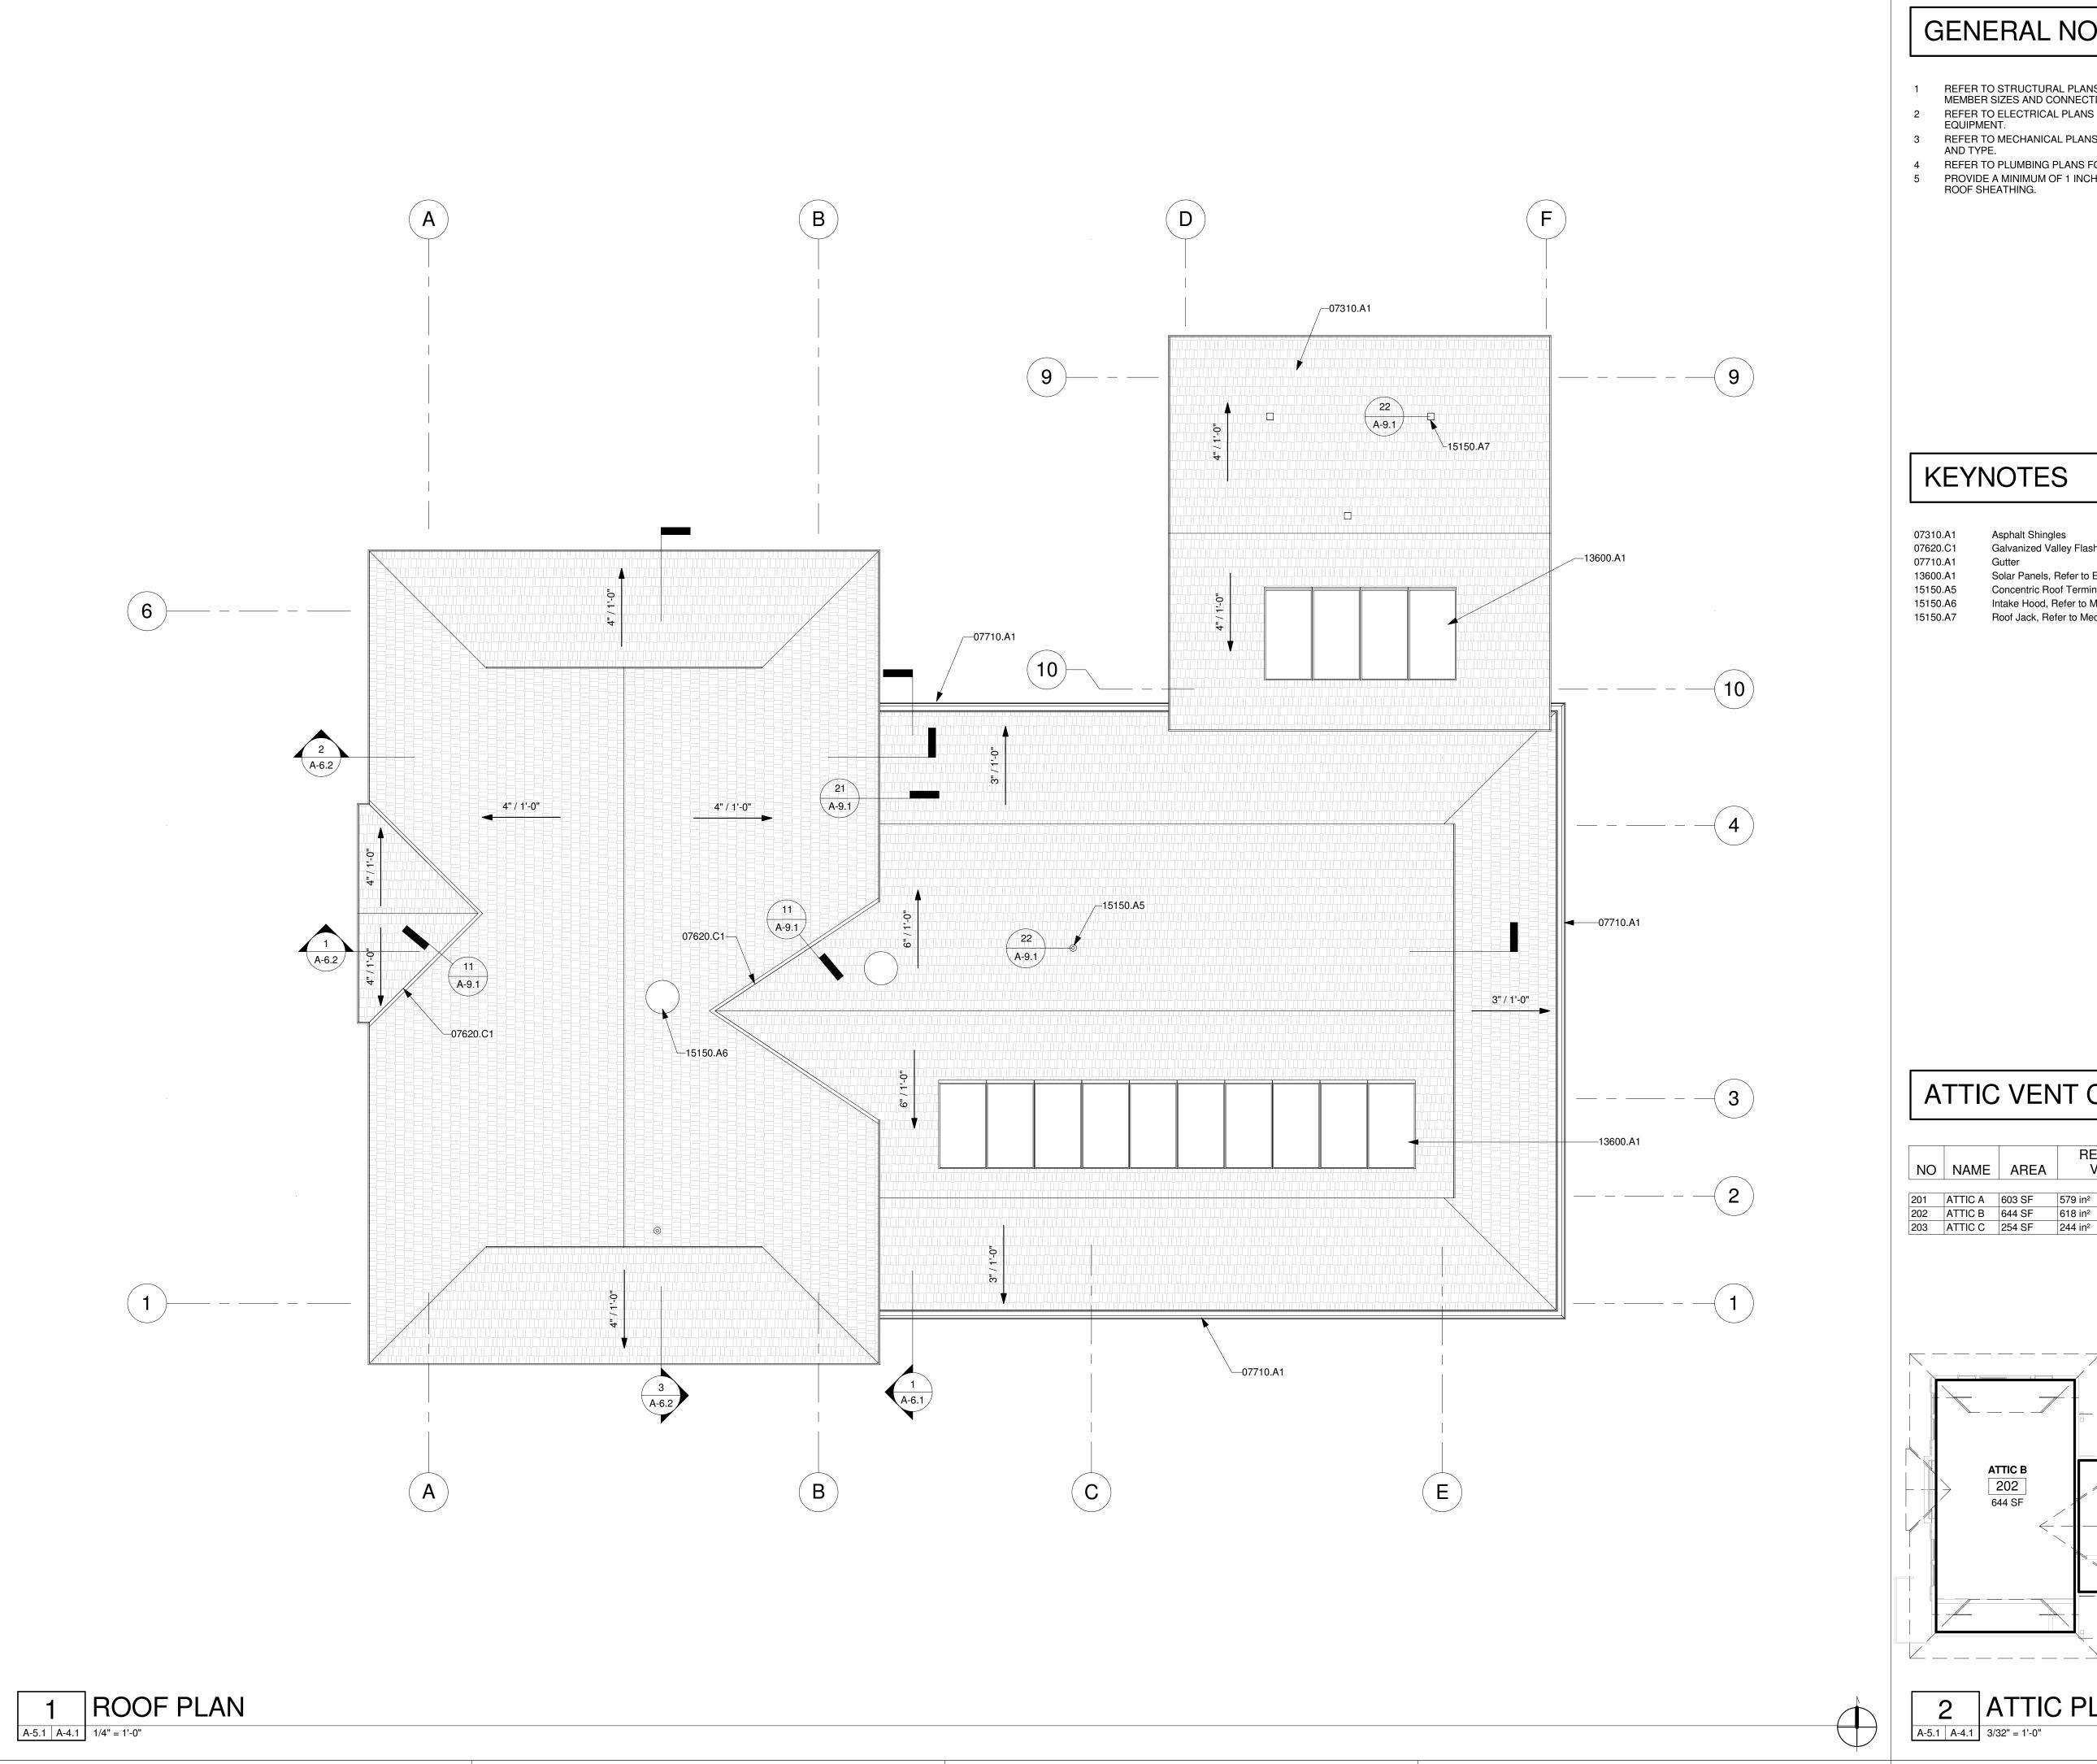

- REFER TO STRUCTURAL PLANS FOR ROOF FRAMING INFORMATION INCLUDING
- MEMBER SIZES AND CONNECTION HARDWARE. 2 REFER TO ELECTRICAL PLANS FOR POWER DISTRIBUTION TO ROOF MOUNTED
- REFER TO MECHANICAL PLANS FOR ROOF MOUNTED EQUIPMENT LOCATION
- 4 REFER TO PLUMBING PLANS FOR ROOF VENT PENETRATION. PROVIDE A MINIMUM OF 1 INCH OF AIRSPACE BETWEEN THE INSULATION AND ROOF SHEATHING.

Asphalt Shingles Galvanized Valley Flashing


Solar Panels, Refer to Electrical Plans

Concentric Roof Termination, Refer to Mechanical Plans. Intake Hood, Refer to Mechanical Plans.

Roof Jack, Refer to Mechanical Plans.

ATTIC VENT CALCULATIONS

NO	NAME	AREA	REQD ATTIC VENTING	REQD UPPER ATTIC VENTING
			T==	
201	ATTIC A	603 SF	579 in ²	289 in ²
202	ATTIC B	644 SF	618 in ²	309 in ²
203	ATTIC C	254 SF	244 in ²	122 in ²

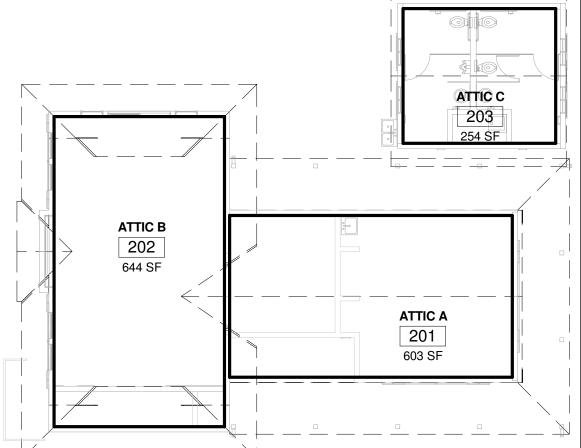

2 ATTIC PLAN

A-5.1 A-4.1 3/32" = 1'-0"

MCCREA RANCH VISITOR CENTER
4500 N. MOORPARK RD.
THOUSAND OAKS, CALIFORNIA ROOF PLAN


Patrick L. Blote

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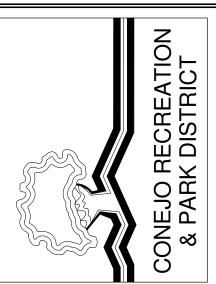
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EXTERIOR ELEVATIONS -VISITOR CENTER

MCCREA RANCH VISITOR CENTER
4500 N. MOORPARK RD.
THOLISAND DAKS CALIFORNIA

NO. REVISION DATE


PROJECT MANAGER

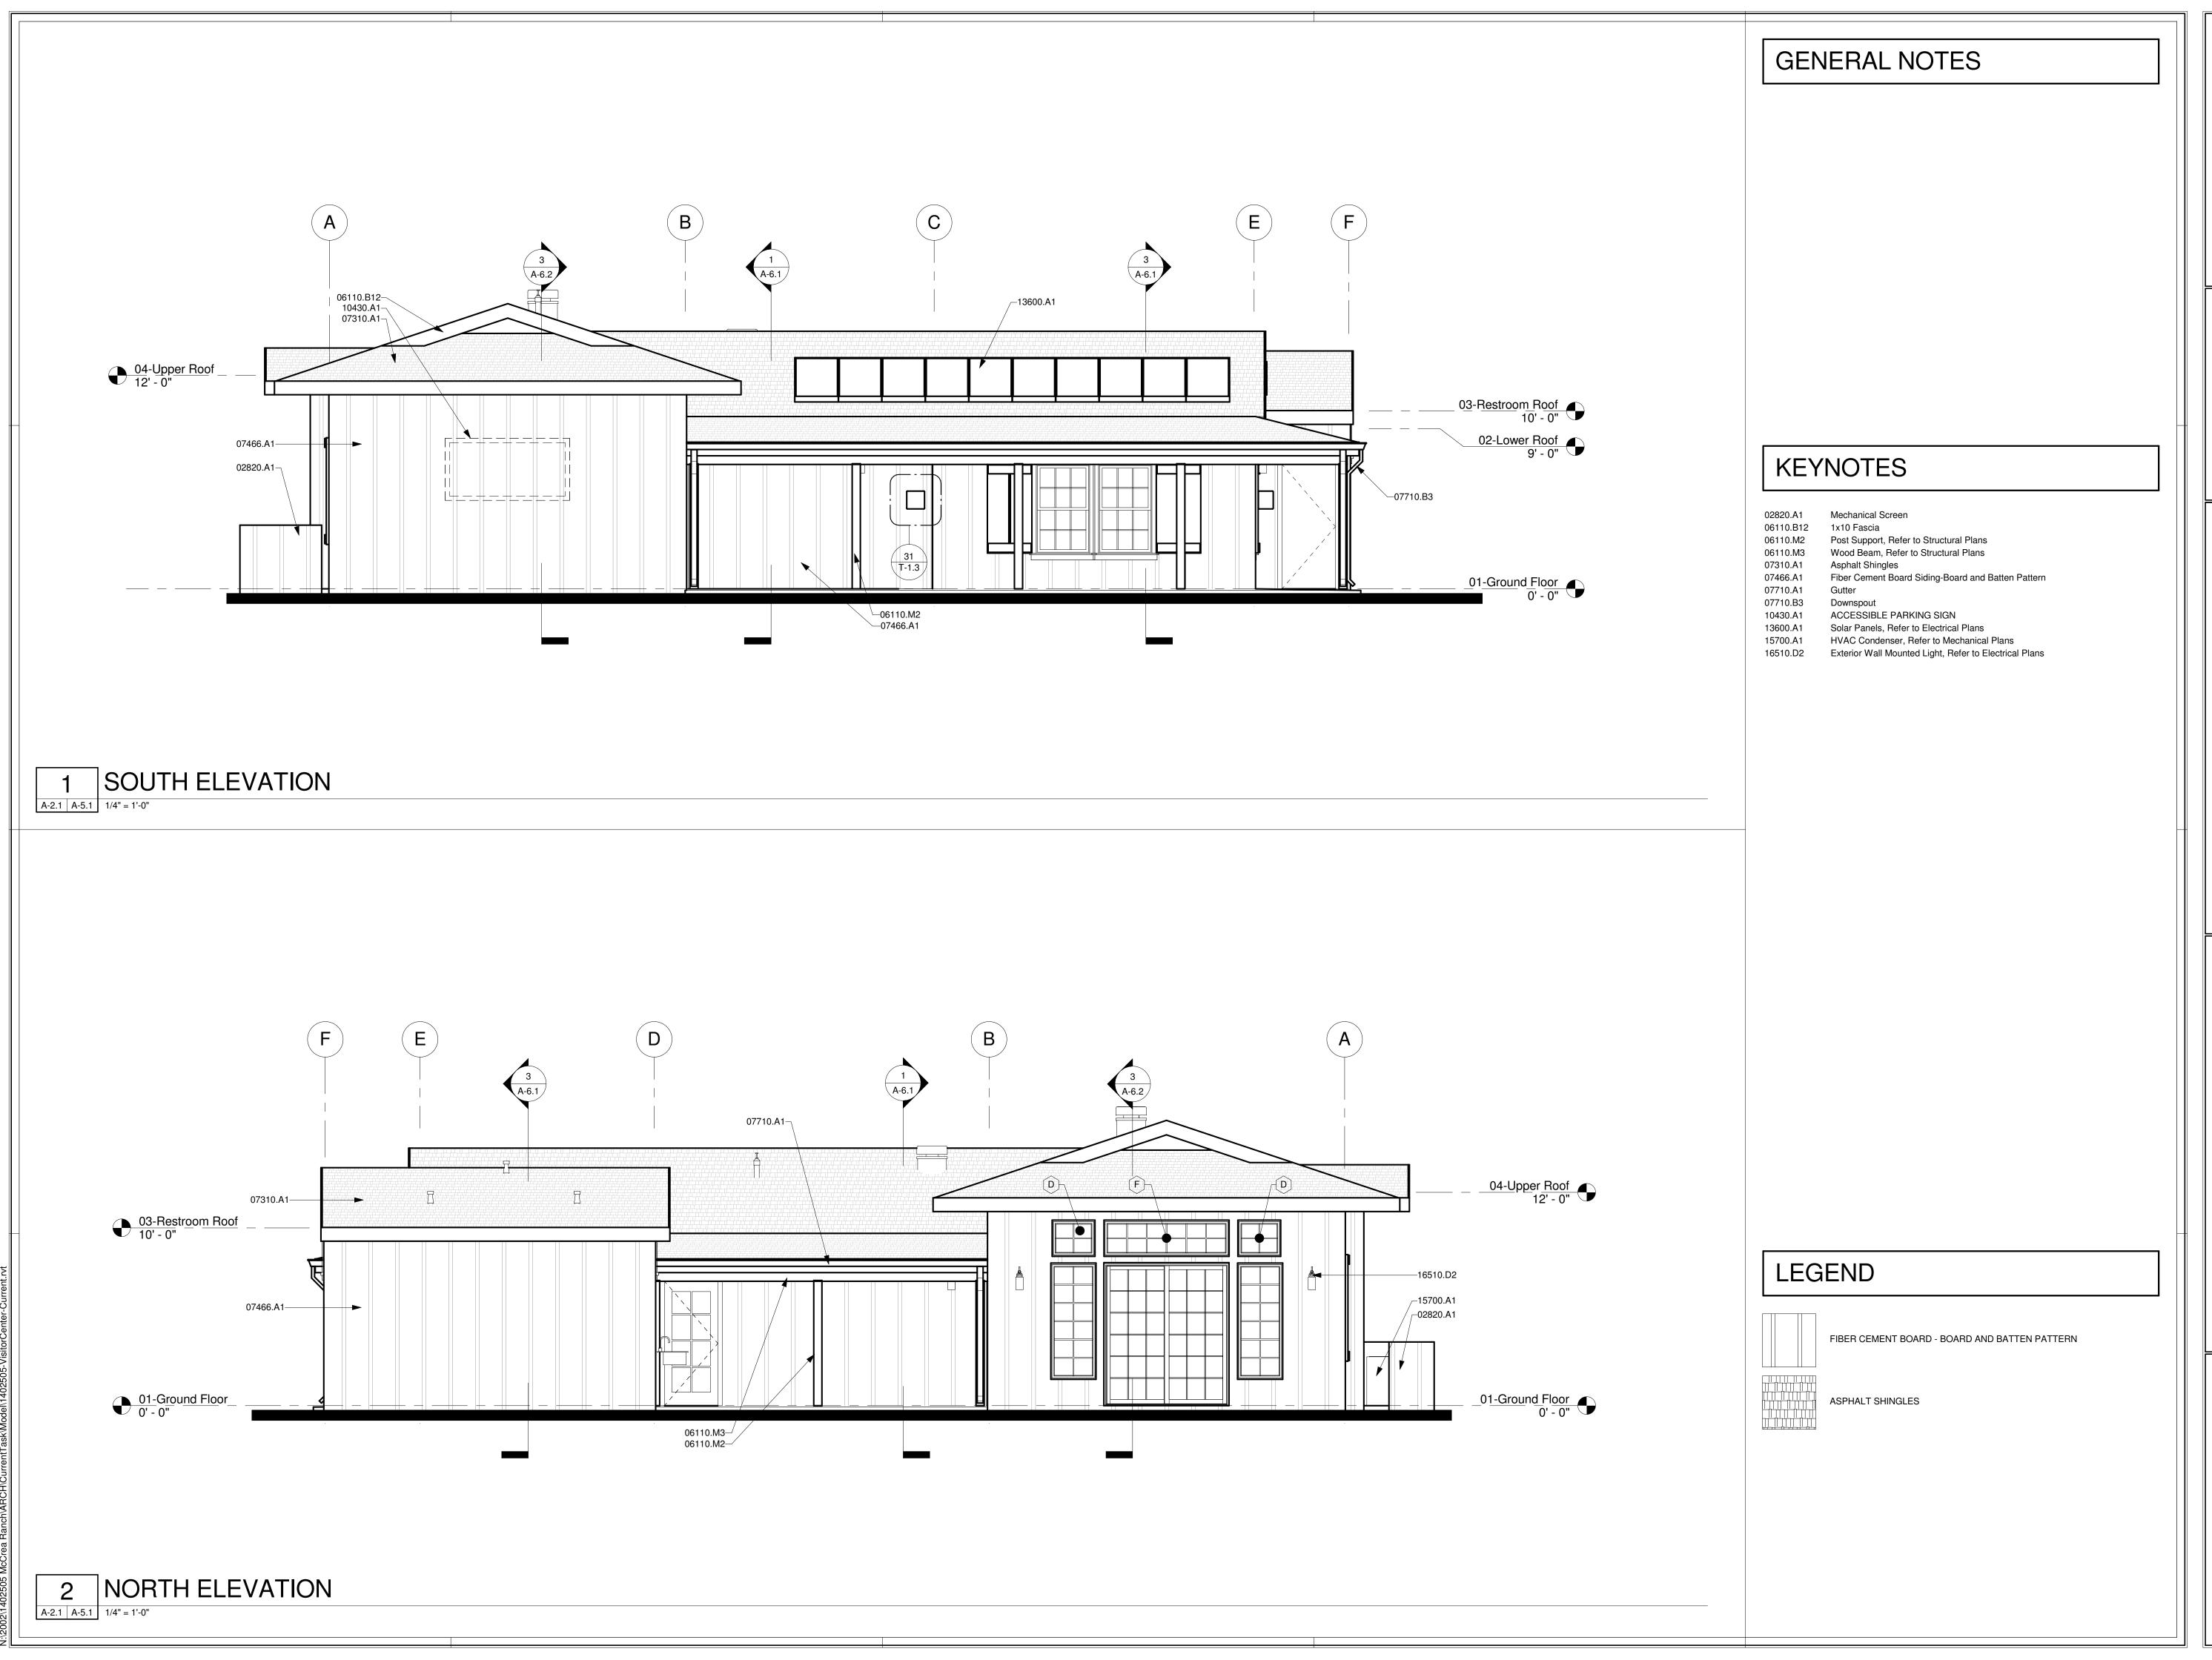DRAWN BY CHECKED BY SDR PLB
DATE

FEBRUARY 01, 2010

PROJECT NUMBER

A-5.1

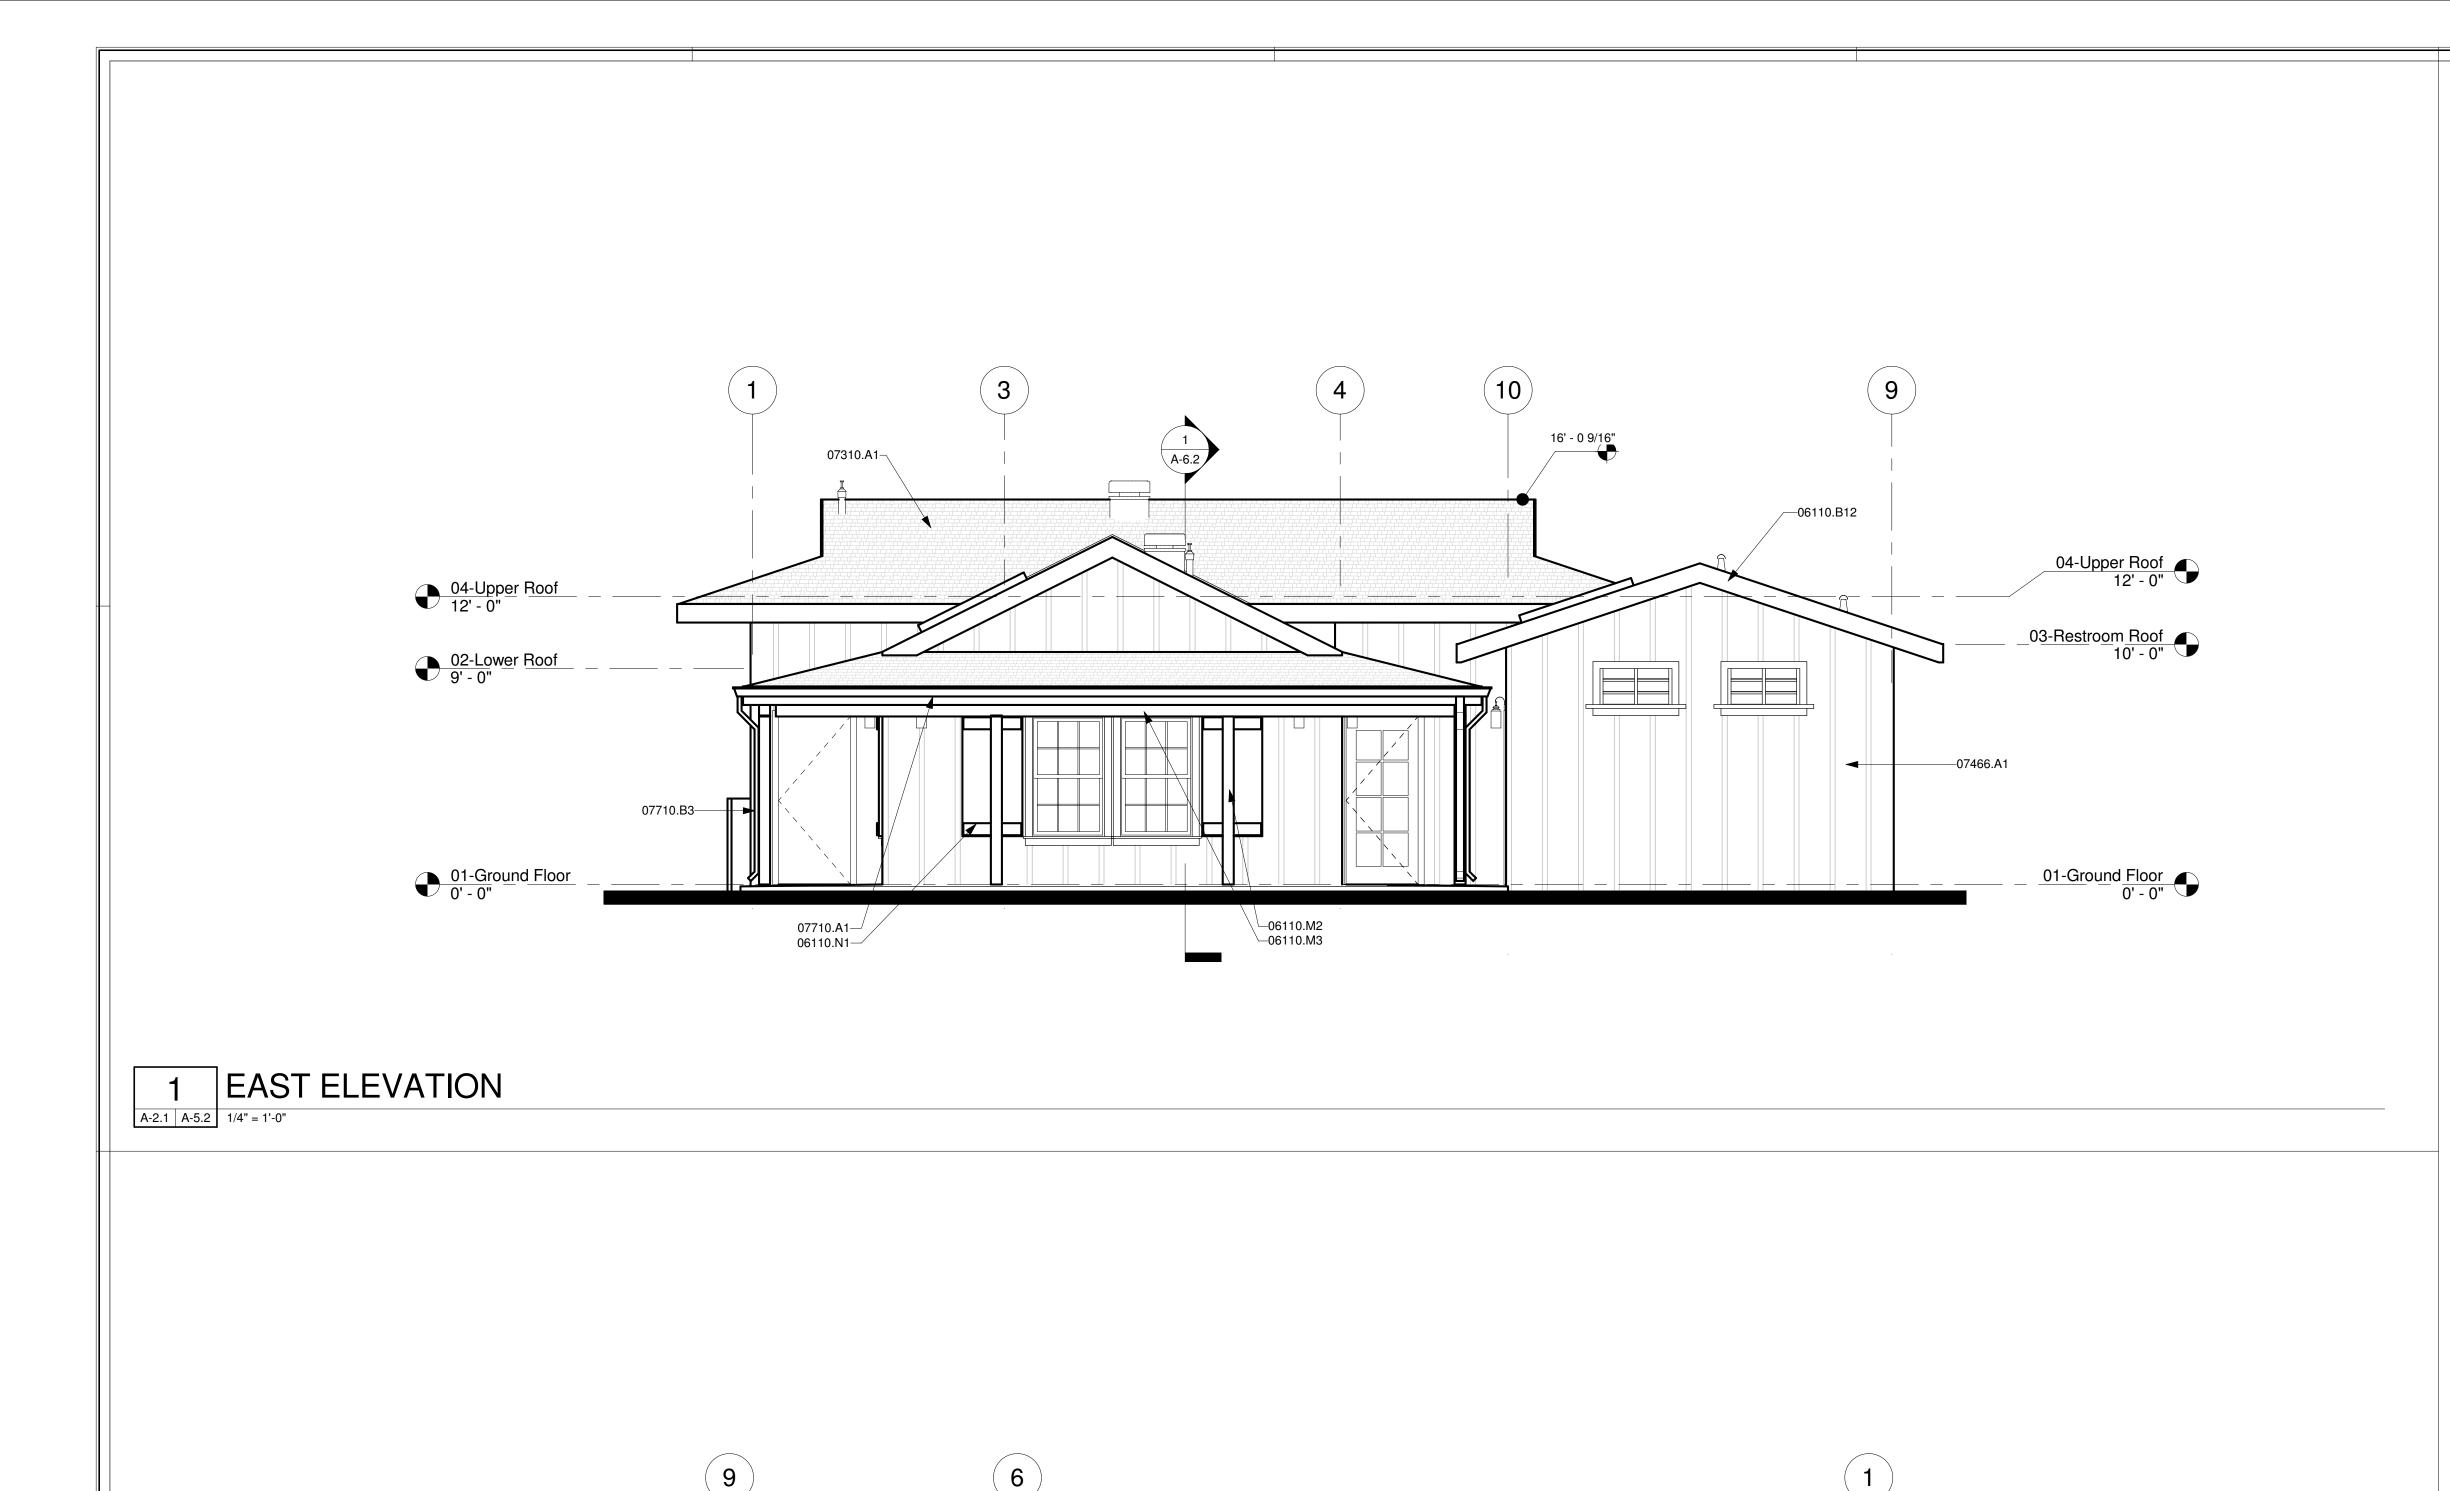

07310.A1-

GENERAL NOTES

KEYNOTES

06110.B12 06110.M2

06110.M3

06110.N1

07310.A1

07466.A1

07710.A1

07710.B3

15700.A1

Mechanical Screen 1x10 Fascia

False Wood Shutter

Asphalt Shingles


Downspout


Post Support, Refer to Structural Plans

Wood Beam, Refer to Structural Plans

Fiber Cement Board Siding-Board and Batten Pattern

HVAC Condenser, Refer to Mechanical Plans

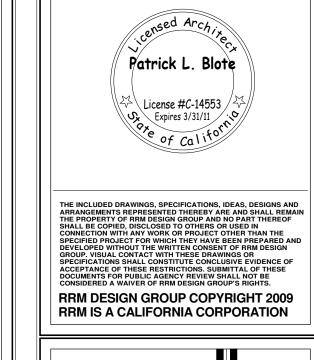

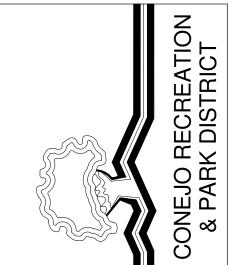

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EXTERIOR ELEVATIONS VISITOR CENTER

MCCREA RANCH VISITOR CENTER
4500 N. MOORPARK RD.
THOLISAND DAKS CALIFORNIA

NO. REVISION

FEBRUARY 01, 2010

LEGEND

FIBER CEMENT BOARD - BOARD AND BATTEN PATTERN

04-Upper Roof 12' - 0"

01-Ground Floor 0' - 0"

---07466.A1

(BEHIND SCREEN) 15700.A1 / 02820.A1


ASPHALT SHINGLES

2 WEST ELEVATION

A-2.1 | A-5.2 | 1/4" = 1'-0"

03-Restroom Roof 10' - 0"

01-Ground Floor 0' - 0"

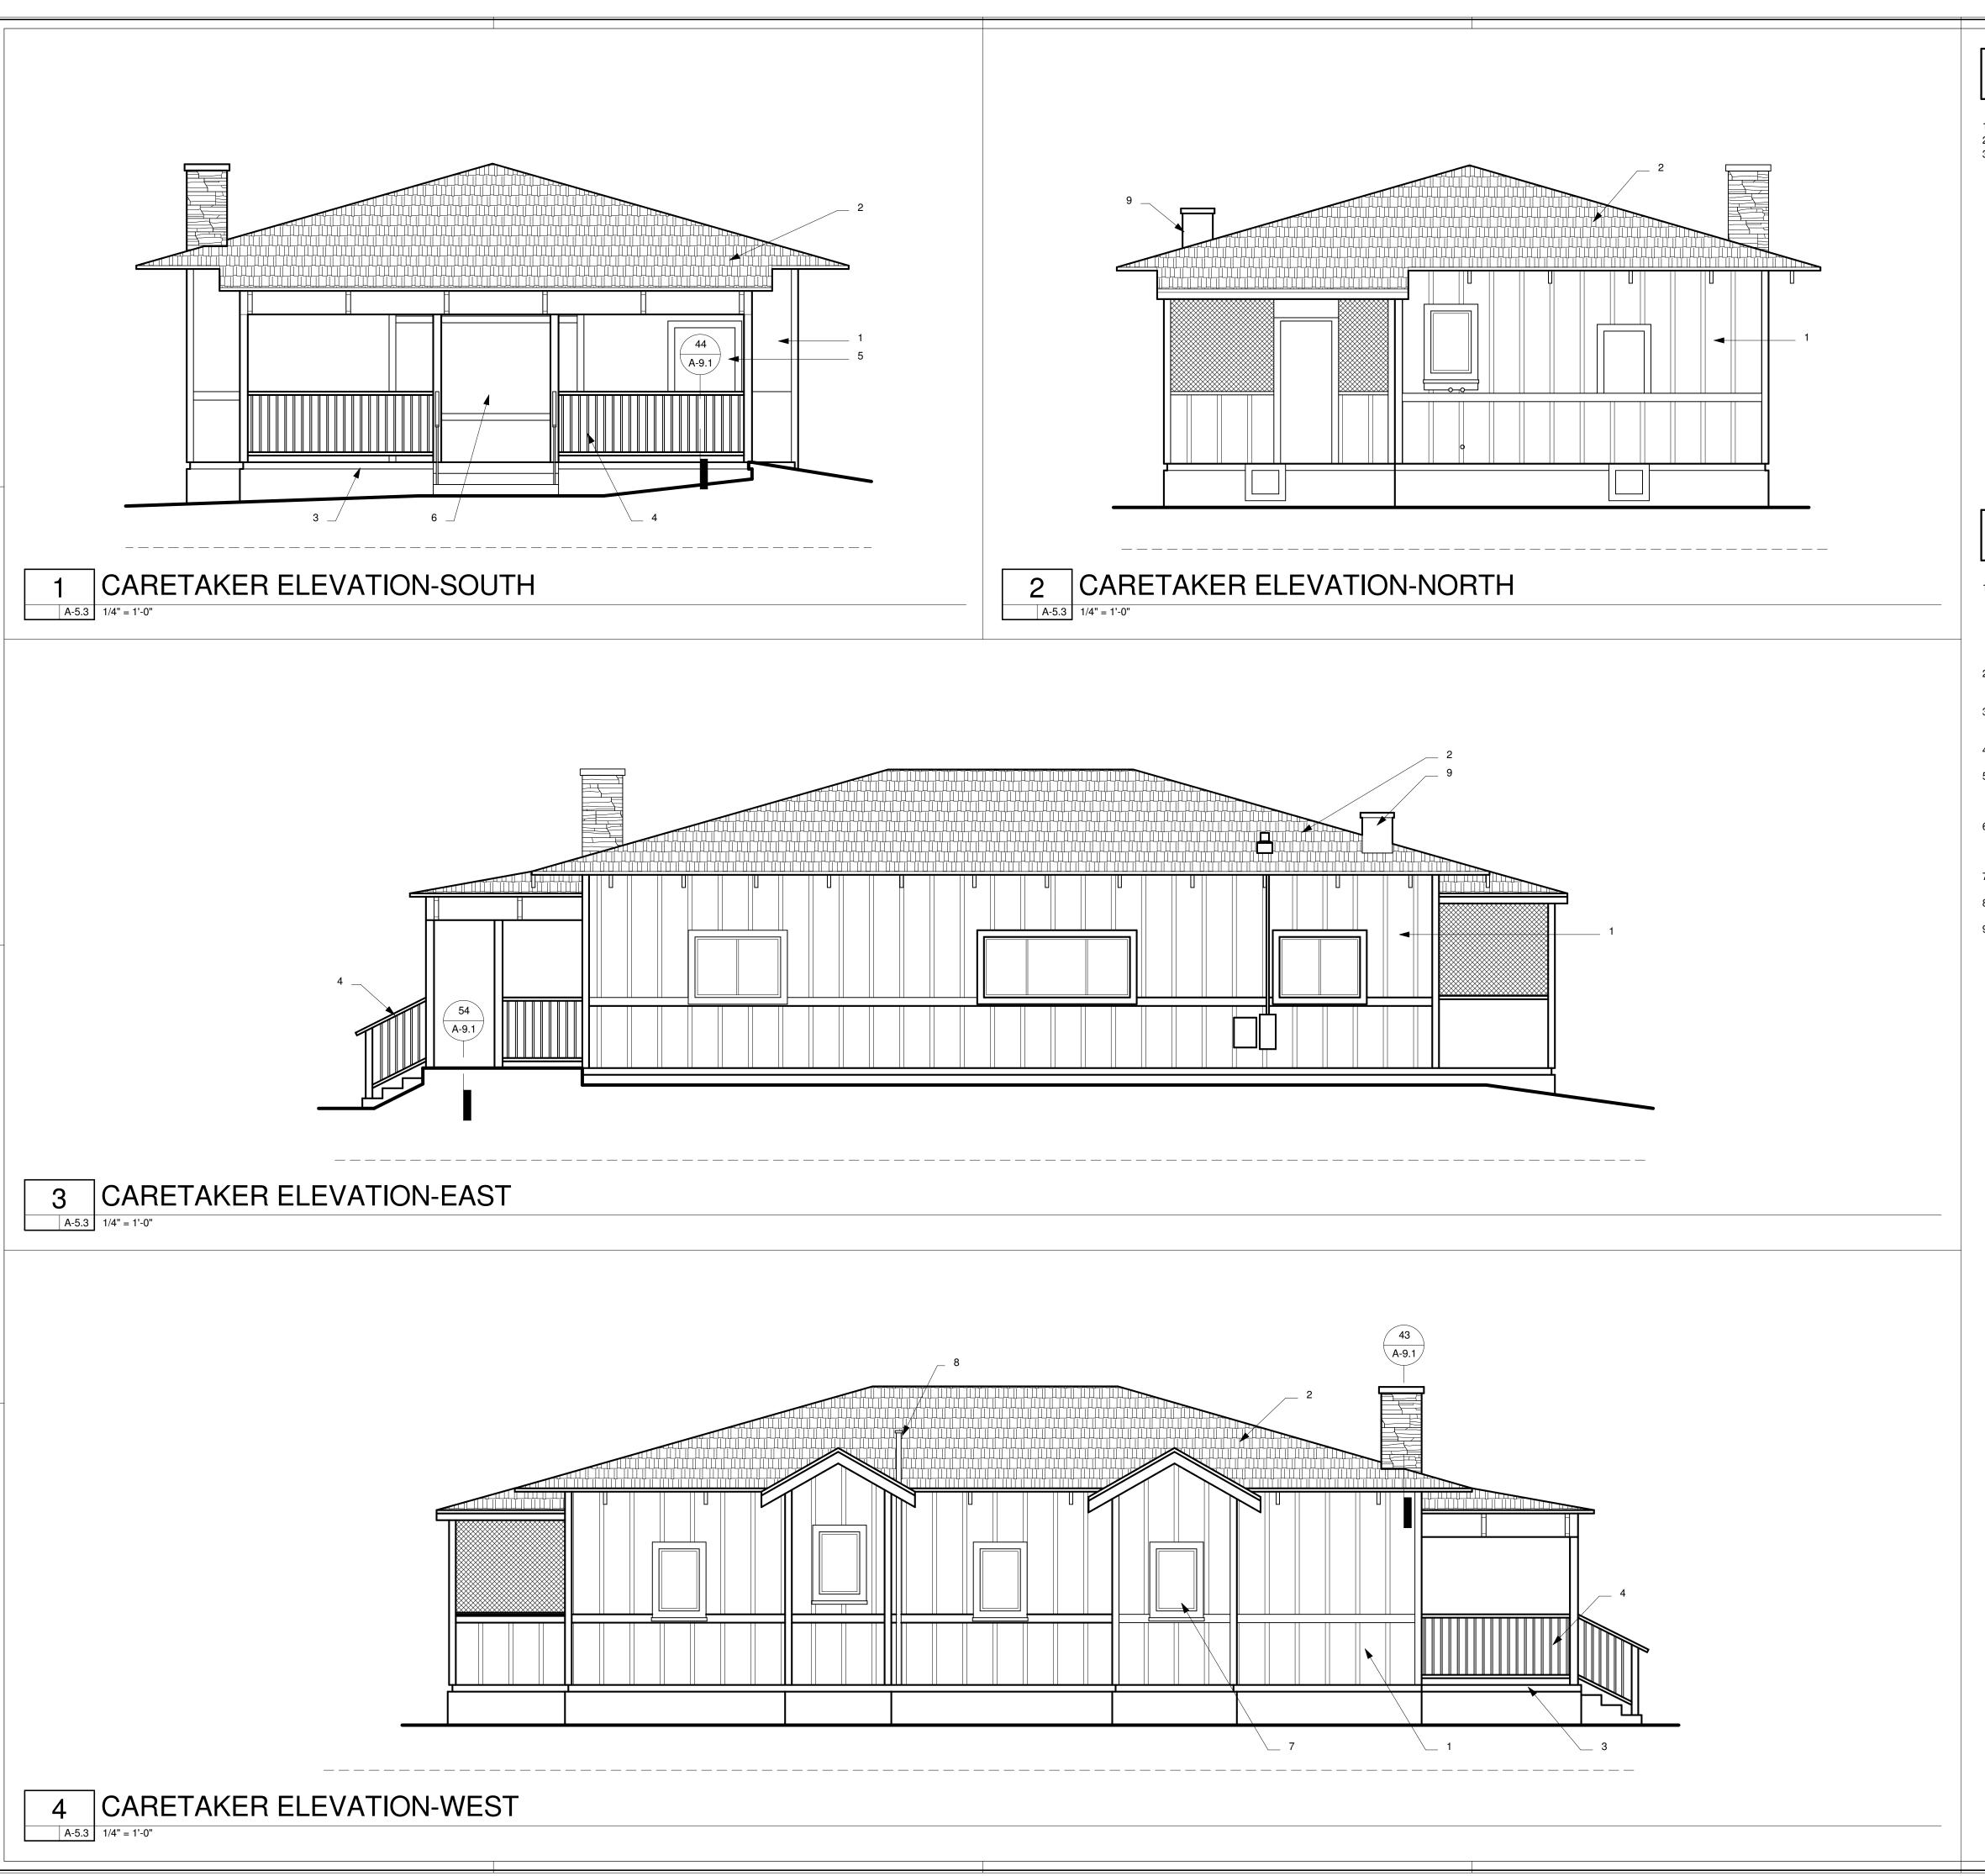

KEYNOTES

NEW PAINT FINISH.

WOOD RAILING AND STEPS.

REPLACE EXISTING INSECT SCREENS.

REVIEW/APPROVAL.

"FAUX" CHIMNEY.

EXTERIOR SURFACES;
-PATCH AND REPAIR ANY VOIDS OR OPENINGS IN EXISTING EXTERIOR WALL

-REPLACE ANY MISSING BATTENS OR TRIM BOARDS ON EXTERIOR WALLS. -POWER-WASH ALL EXTERIOR WALLS AND EAVES AND PREP SURFACE FOR

PORCH DECK – REMOVE EXISTING PLYWOOD SHEATHING AND INSTALL NEW "COMPOSITE" 2X6 DECKING ATTACHED TO EXITING JOISTS WITH VINYL COATED

PORCH RAILING & STEPS; REMOVE EXISTING RAILING, AND CONSTRUCT NEW

FRONT WINDOW; REMOVE EXISTING WINDOW AND REPLACE WITH VINYL CLAD WOOD FRAME WINDOW, INCLUDING DUAL-PANE FIXED GLASS. PRIOR TO INSTALLATION CONTRACTOR SHALL SUBMIT MANUFACTURER'S DATA FOR A/E

WEST WALL WINDOWS; REPAIR WOOD WINDOW FRAMES, REMOVE AND

PLUMBING VENTS; ANY EXPOSED PLUMBING PIPES SHALL BE CONCEALED WITH WOOD SIDING, VENTS THROUGH SHALL BE CLEANED AND REPAINTED CHIMNEY; REMOVE ANY LOOSE MASONRY UNITS FROM TOP OF EXISTING CHIMNEY, CAP FIREPLACE FLUE, AND CONSTRUCT FRAMED WALL FOR NEW

FRONT DOOR; REMOVE EXISTING DOOR AND REPLACE WITH RESIDENTIAL GRADE PANEL TYPE WOOD DOOR, INCLUDING NEW WOOD TRIM, NEW HINGES AND LOCKING HARDWARE. PRIOR TO INSTALLATION CONTRACTOR SHALL


SUBMIT MANUFACTURER'S DATA FOR A/E REVIEW/APPROVAL.

ROOFING; APPLY NEW ROOFING AND EDGE FLASHING OVER EXISTING COMPOSITION SHINGLES, REFER TO SPECIFICATION SECTION 07310 FOR

-PAINT ALL SURFACES TO MATCH NEW VISITOR CENTER.

MATERIAL TO MATCH NEW VISITOR CENTER.

- POWER WASH ALL SURFACES AND PREPARE FOR PAINT.
- PATCH AND REPAIR ANY VOIDS OR WALL OPENINGS. 3. PAINT AND MATERIALS TO MATCH NEW VISITOR CENTER.

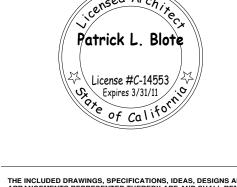


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KEYNOTES

2x6 Framing

Asphalt Shingles

REFER TO ELEVATIONS FOR EXTERIOR FINISH MATERIALS.
 REFER TO FINISH SCHEDULE FOR INTERIOR FINISH MATERIALS.

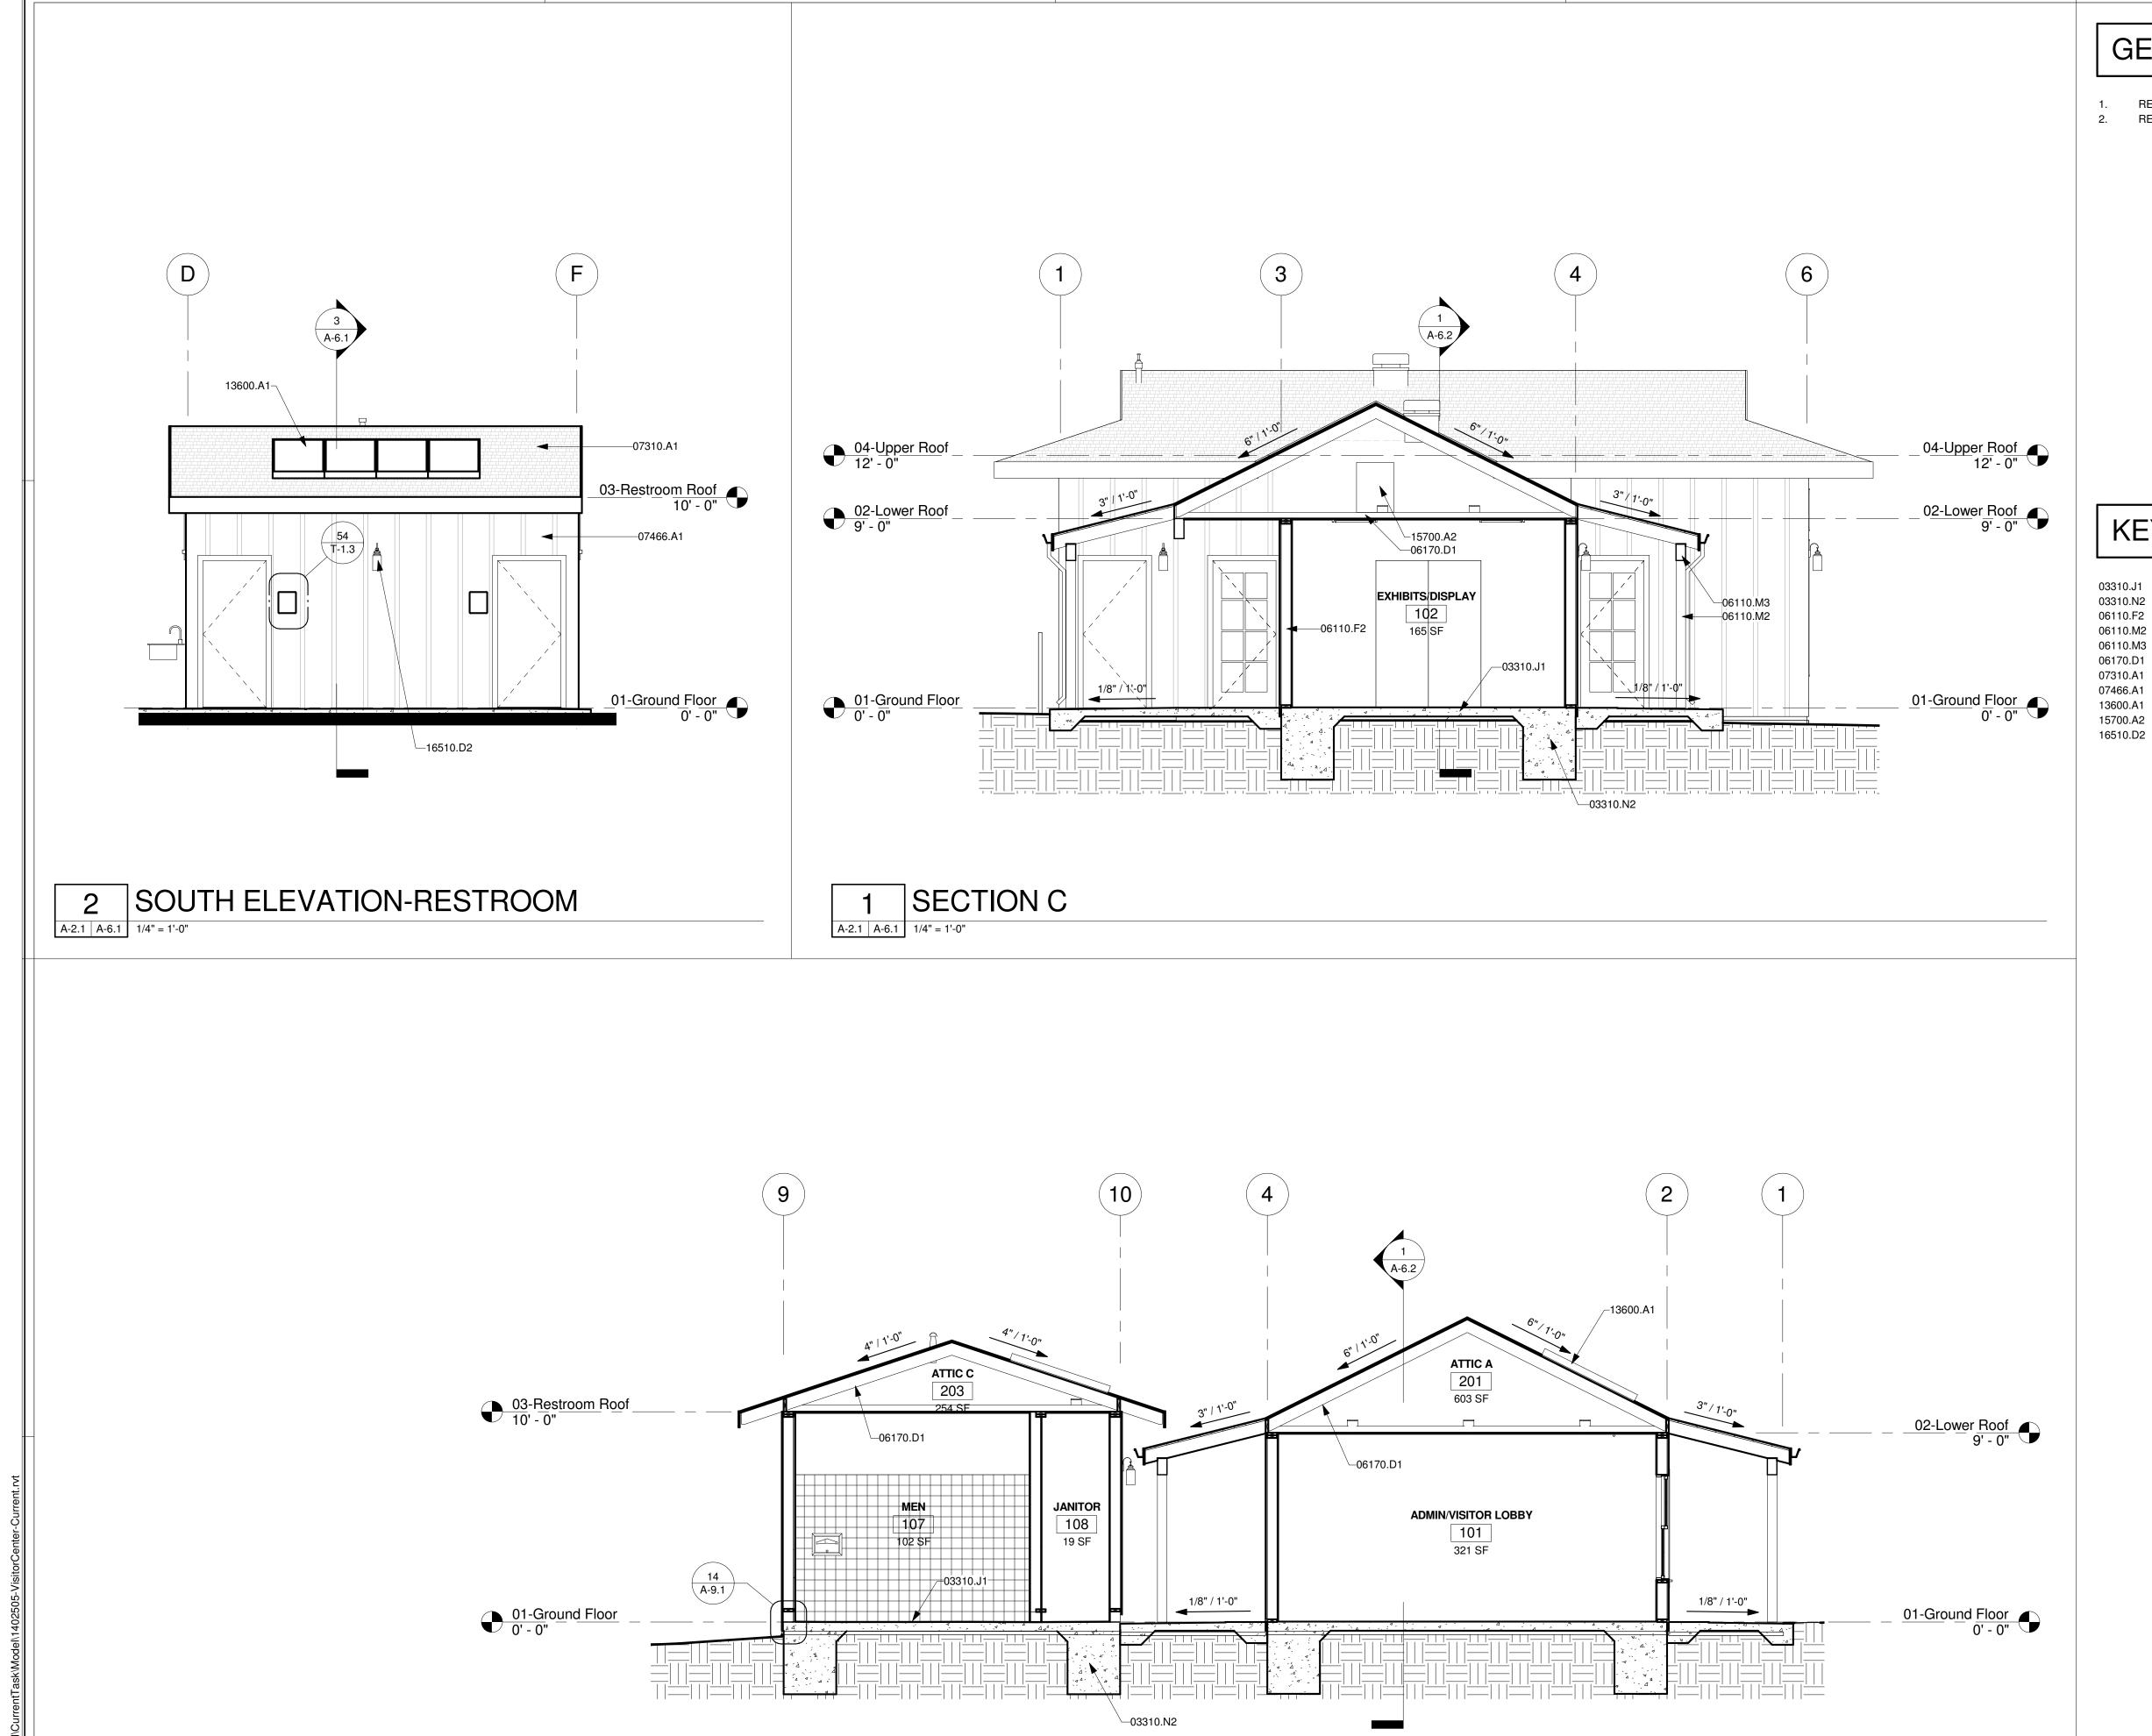Concrete Slab, Refer to Structural Drawings

Foundation, Refer to Structural Drawings

Post Support, Refer to Structural Plans

Wood Beam, Refer to Structural Plans


Solar Panels, Refer to Electrical Plans FAU, Refer to Mechanical Plans

Premanufactured Wood Truss, Refer to Structural Drawings

Fiber Cement Board Siding-Board and Batten Pattern

Exterior Wall Mounted Light, Refer to Electrical Plans



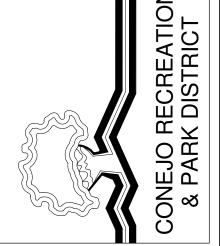

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ONS 37

MCCREA RANCH VISITOR CENTER
4500 N. MOORPARK RD.
THOUSAND OAKS, CALIFORNIA
BUILDING SECTIONS

NO. REVISION DATE

1 PLAN CHECK RESUBMITTAL 05/14/10

PROJECT MANAGER

DRAWN BY CHECKED BY PLB

DATE
FEBRUARY 01, 2010


PROJECT NUMBER

1/02505


SHEET **A-6.1**


3 SECTION E

A-2.1 A-6.1 1/4" = 1'-0"

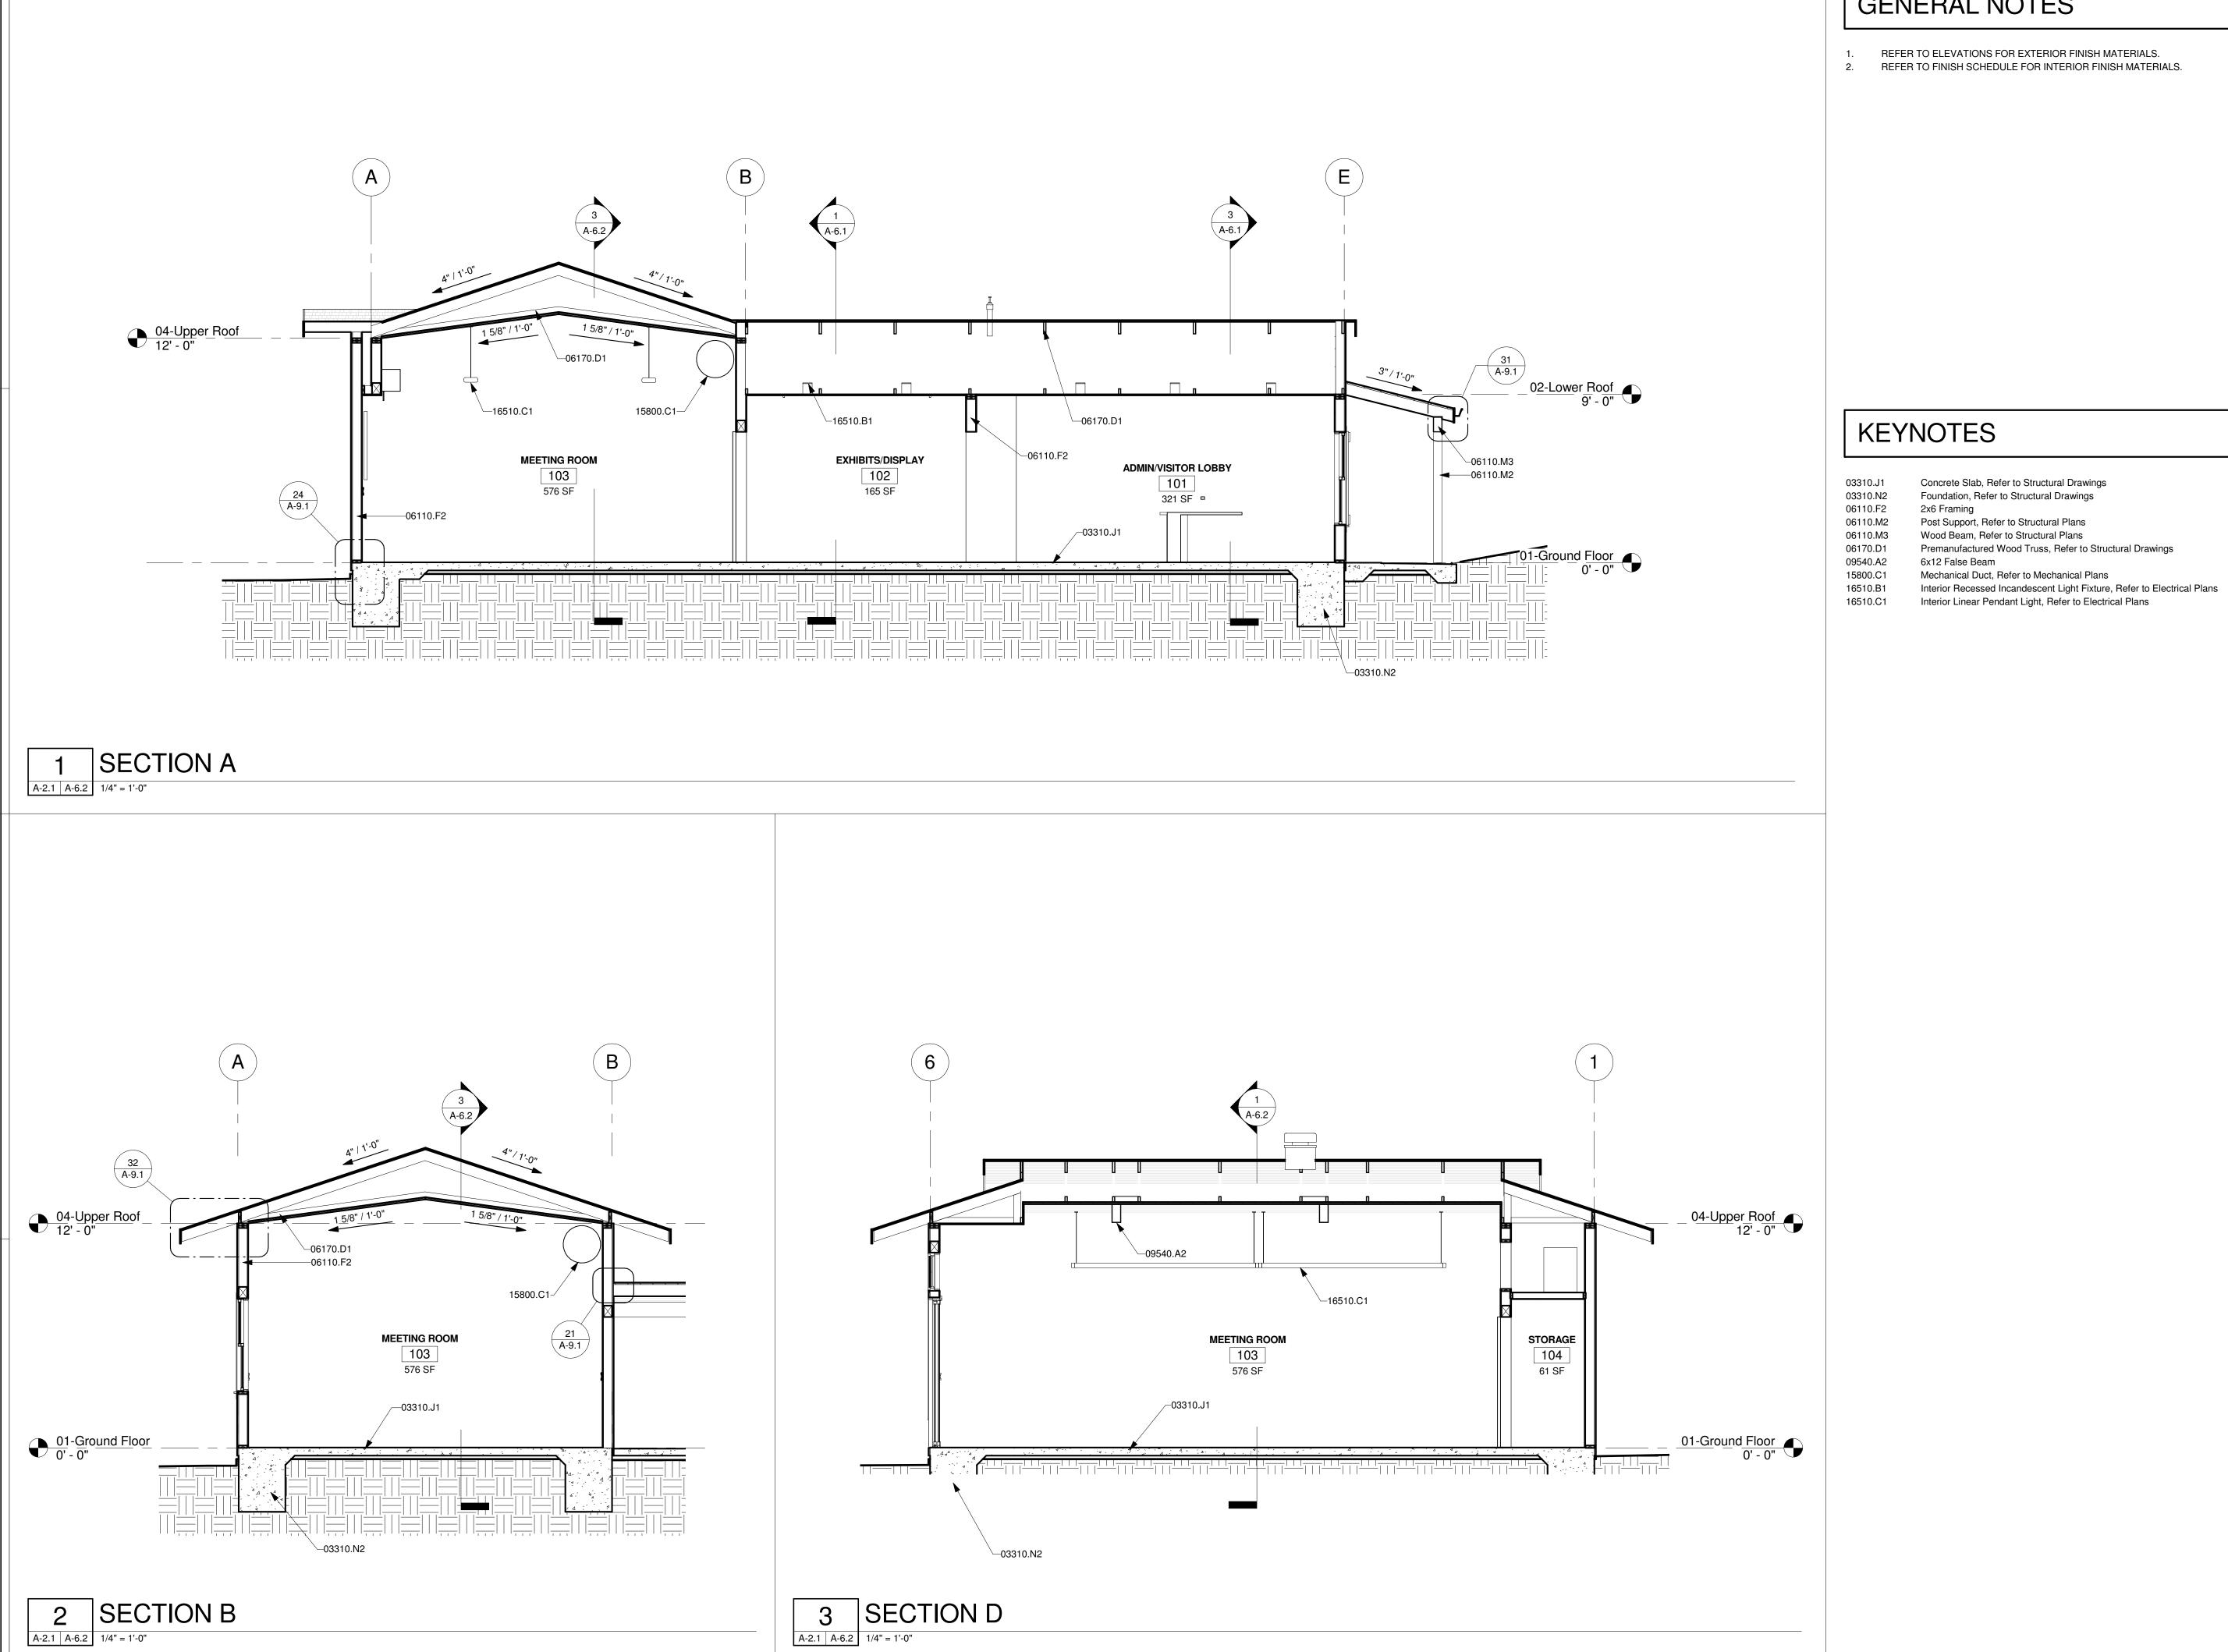

- REFER TO ELEVATIONS FOR EXTERIOR FINISH MATERIALS.
- 2. REFER TO FINISH SCHEDULE FOR INTERIOR FINISH MATERIALS.

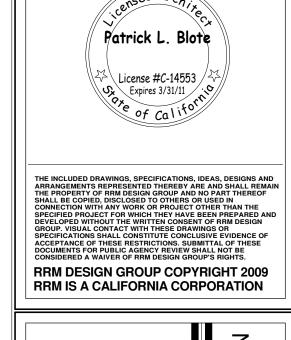

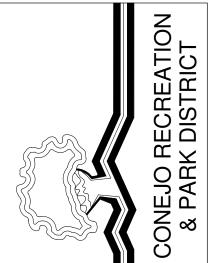


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BUILDING SECTIONS

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NO. REVISION FEBRUARY 01, 2010



"THE SURFACE OF FLOORS SHALL BE SLIP RESISTANT. WHEN TESTED IN ACCORDANCE WITH ASTM C1028B TEST PROCEDURE FOR COEFFICIENT OF FRICTION, TILE MUST ACHIEVE A WET AND DRY VALUE OF NOT LESS THAN 0.60. PRIOR TO THE INSTALLATION OF THE FLOOR COVERING, A WRITTEN STATEMENT FROM THE FLOORING MANUFACTURER MUST BE SUBMITTED TO THE BUILDING DIVISION, COMMUNITY DEVELOPMENT DEPARTMENT STATING THAT THE PRODUCT TO BE INSTALLED MEETS CURRENT INDUSTRY STANDARDS FOR SLIP RESISTANCE." PROVIDE TEST INFORMATION OR SAMPLES OF THE FLOORING.

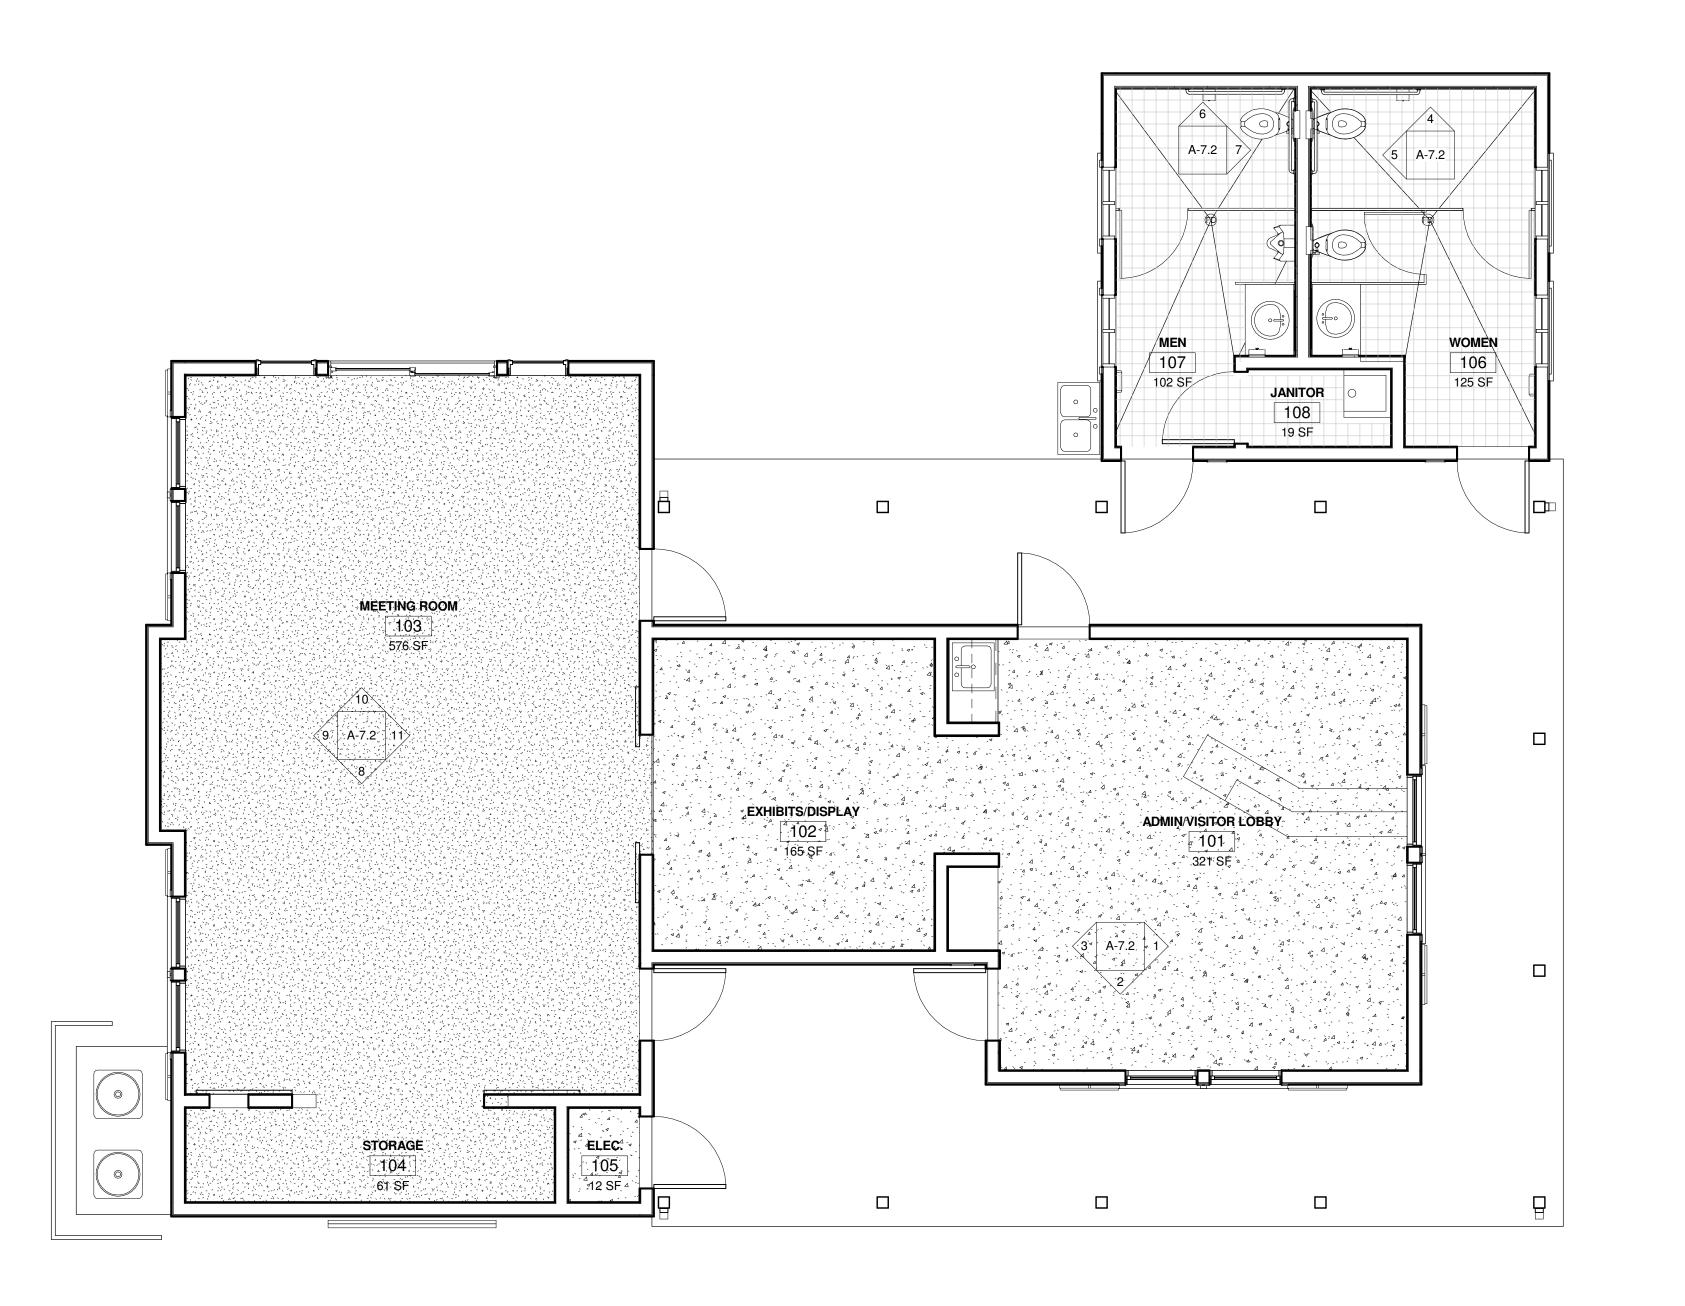FINISH NOTES

CT CERAMIC TILE, 6" COVED UNGLAZED FINISH. MDF MEDIUM DENSITY FIBERBOARD, 1X4 BLACK MALAMINE FINISH.

RBT RUBBER TOPSET 4" HIGH.

GB GYPSUM BOARD, PAINT FINISH.

WD 1X6 TONGUE & GROOVE, STAIN FINISH.

CPT CARPET TILES, 18" SQUARE W/ METAL TRANSITION STRIPS AT EXPOSED

CT CERAMIC TILE, 6X6 UNGLAZED FINISH. EC EXPOSED CONCRETE, CLEAR SEAL FINISH.

SC STAINED CONCRETE.

WAINSCOT BB MEDIUM DENSITY FIBERBOARD BEADBOARD HIGH, PAINT FINISH.

GB GYPSUM BOARD, PAINT FINISH.

CT CERAMIC TILE, GLAZED FINISH.

Patrick L. Blote

 $^{\sim}ackslash$ License #C-14553 $^{\prime}$

Expires 3/31/11 COX Expire

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FINISH PLAN


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FINISH PLAN A-5.1 A-7.1 1/4" = 1'-0"

FINISH SCHEDULE

		Floor	Ceiling	Base		South Wall		West Wall	
Number	Name	Finish	Finish	Finish	Finish	Finish	Finish	Finish	Comments
101	ADMIN/VISITOR LOBBY	SC	GB	MDF	GB	GB	GB	GB	
102	EXHIBITS/DISPLAY	SC	GB	MDF	GB	GB	GB	GB	
103	MEETING ROOM	CPT	WD	BB	GB	GB	GB	GB	48" BEADBOARD WAINSCOT ALL WALLS
104	STORAGE	CPT	GB	RBT	GB	GB	GB	GB	
105	ELEC.	EC	GB	RBT	GB	GB	GB	GB	
106	WOMEN	СТ	GB	CT	GB	GB	GB	GB	72" HIGH CERAMIC TILE WAINSCOT ALL WALLS
107	MEN	СТ	GB	CT	GB	GB	GB	GB	72" HIGH CERAMIC TILE WAINSCOT ALL WALLS
108	JANITOR	EC	GB	RBT	GB	GB	GB	GB	



DOOR SCHEDULE

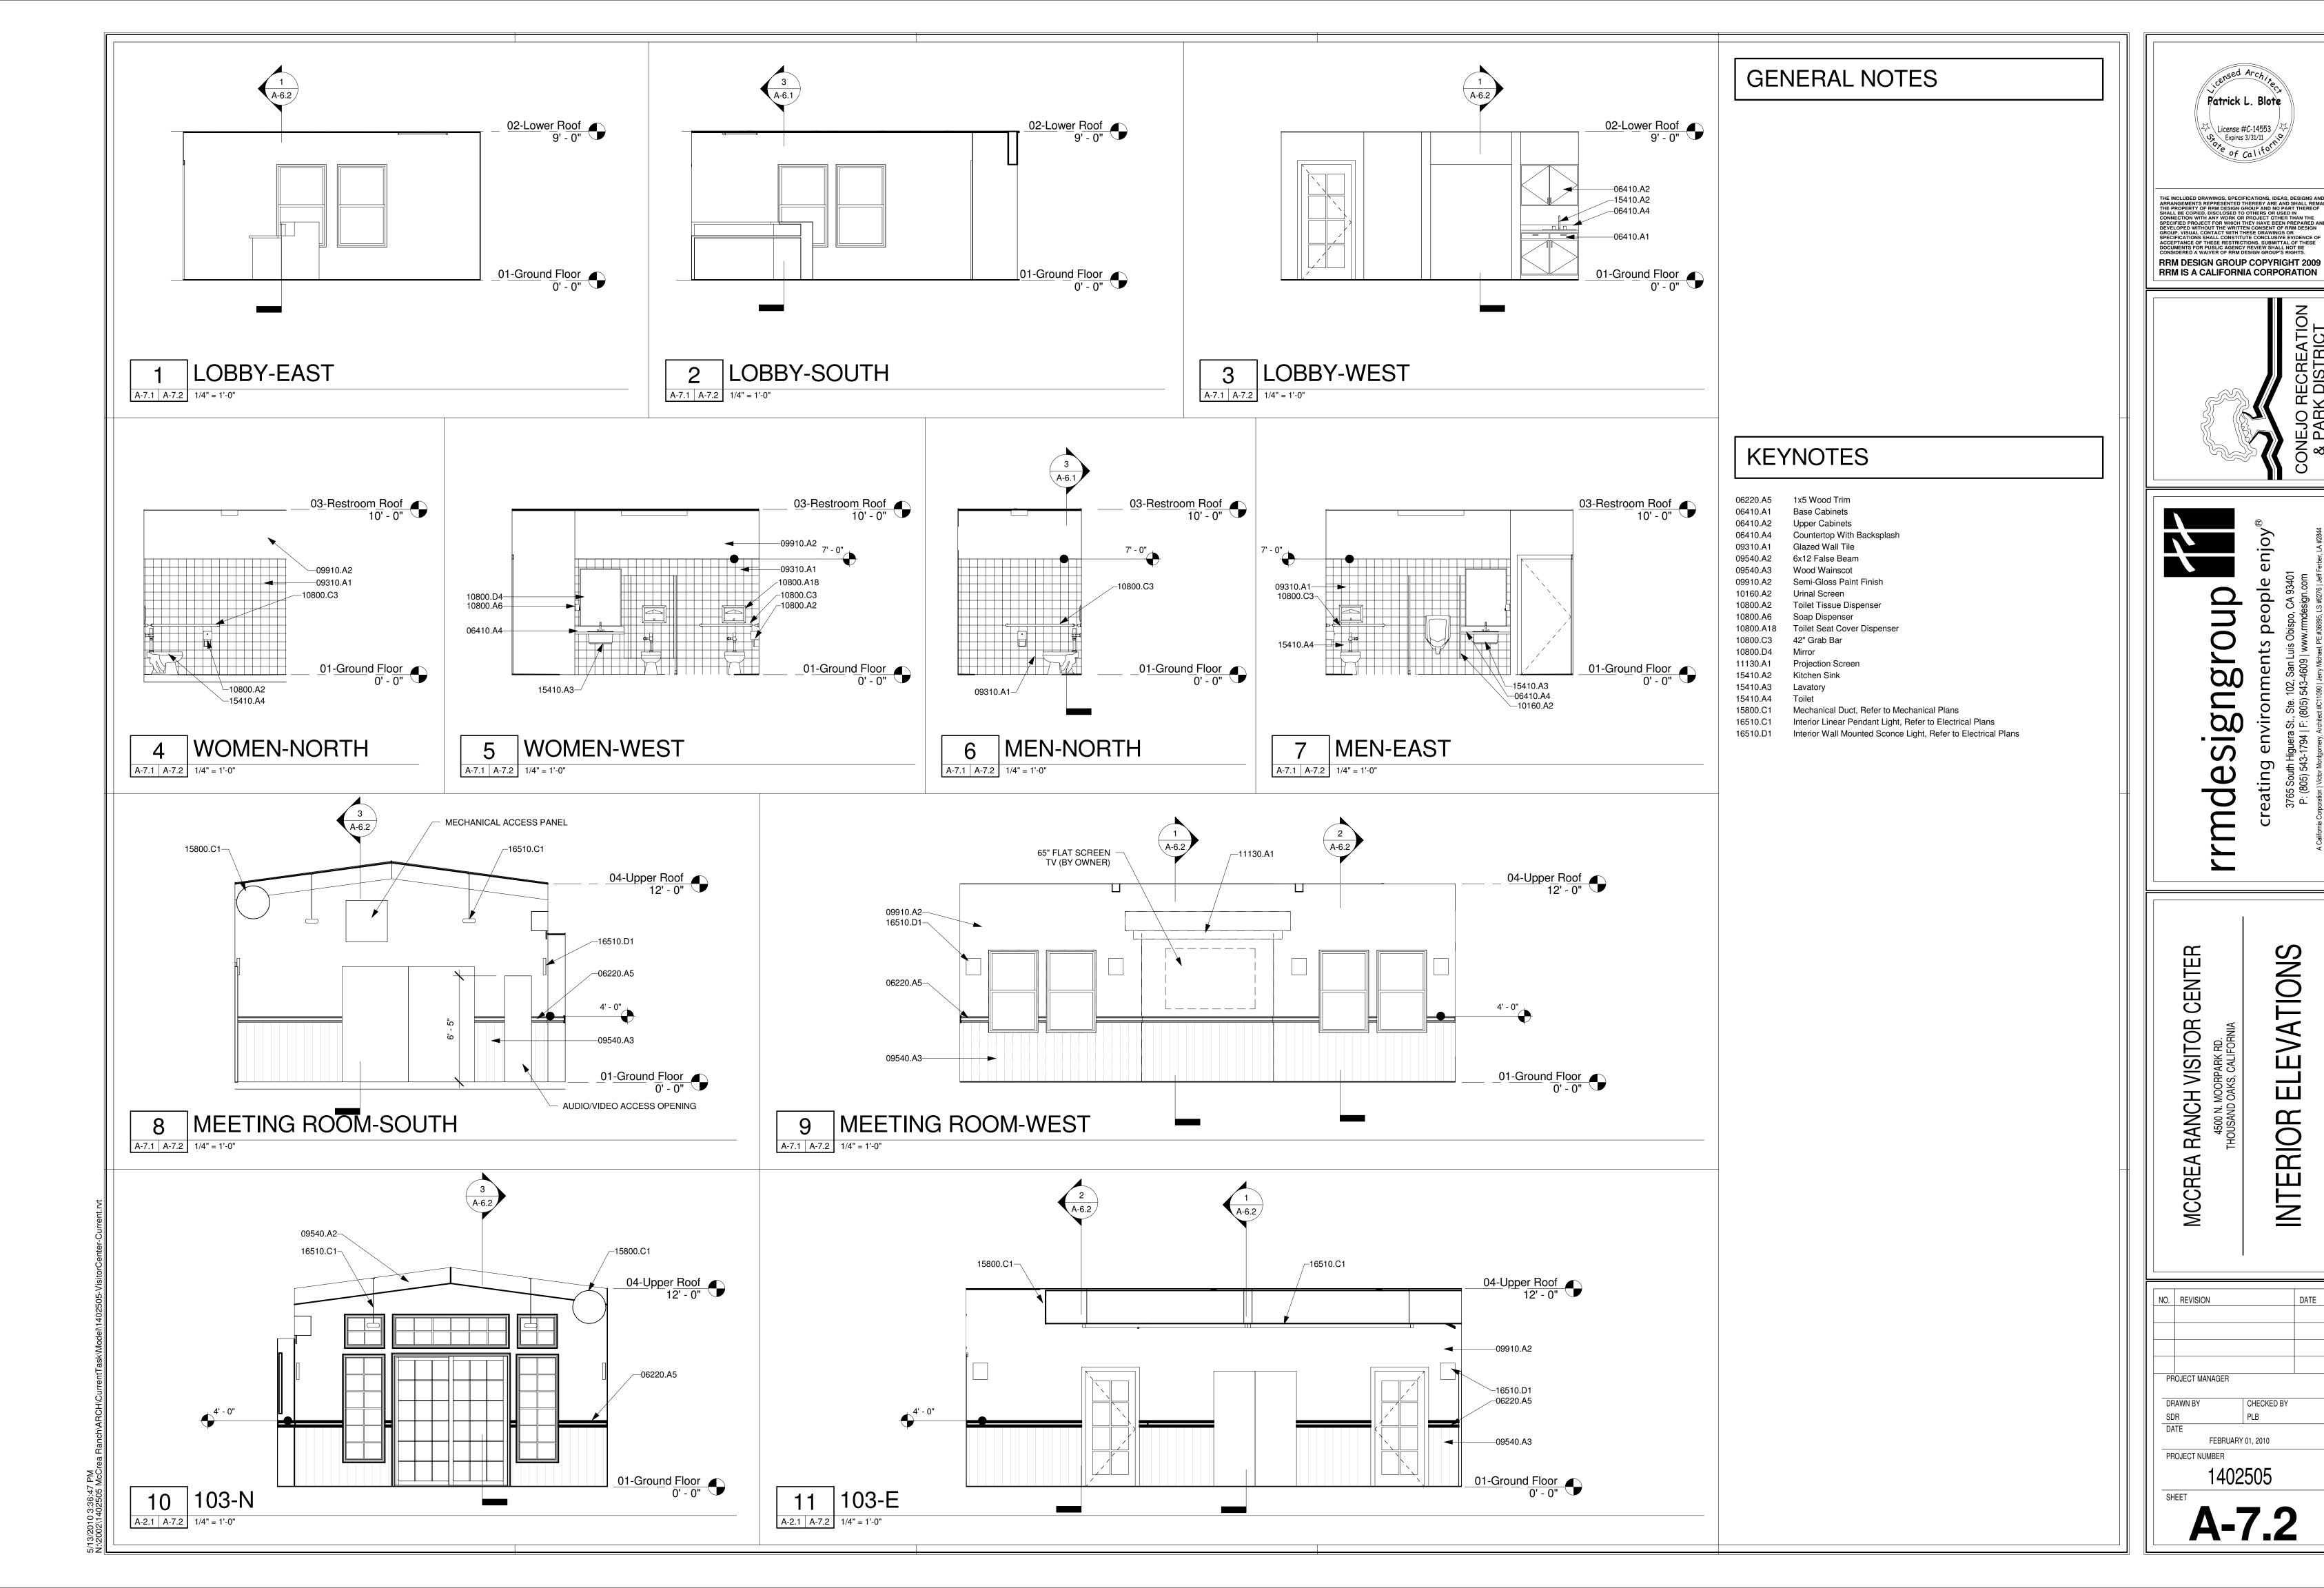SIZE					DETAIL				
				FRAME	PANEL			THRES	
NO.	TYPE	WIDTH	HEIGHT	MATERIAL	MATERIAL	HEAD	JAMB	HOLD	NOTES
1	Α	3' - 0"	7' - 0"	MTL	WD	21/A-9.2	22/A-9.2	23/A-9.2	8
2	Α	3' - 0"	7' - 0"	MTL	WD	21/A-9.2	22/A-9.2	23/A-9.2	8
3	Α	3' - 0"	7' - 0"	MTL	WD	11/A-9.2	11/A-9.2	11/A-9.2	4
4	Α	3' - 0"	7' - 0"	MTL	WD	21/A-9.2	22/A-9.2	23/A-9.2	4
5	С	3' - 0"	7' - 0"	MTL	WD	21/A-9.2	22/A-9.2	23/A-9.2	6, 7, 9
6	С	3' - 0"	7' - 0"	MTL	WD	21/A-9.2	22/A-9.2	23/A-9.2	6, 7, 9
7	С	3' - 0"	7' - 0"	MTL	WD	21/A-9.2	22/A-9.2	23/A-9.2	6, 7, 9
8	С	3' - 0"	7' - 0"	MTL	WD	21/A-9.2	22/A-9.2	23/A-9.2	6, 7, 9
9	D	8' - 0"	7' - 0"		WD	12/A-9.2	12/A-9.2	12/A-9.2	
10	E	5' - 0"	7' - 0"		WD	12/A-9.2	12/A-9.2	12/A-9.2	
11	F	7' - 0"	8' - 0"		WD	41/A-9.2	43/A-9.2	44/A-9.2	5

DOOR NOTES

- ALL DOORS SHALL BE SET 6" OFF ADJACENT PERPENDICULAR WALL, UON. DOORS SHALL NOT BE UNDERCUT, UON. ALL LEVERS, PULLS, AND LOCKS ARE TO BE PROVIDED PER THE SCHEDULE. ALL HINGES AND OTHER MISCELLANEOUS EXPOSED HARDWARE SHALL BE IN SIMILAR AND COMPATIBLE FINISHES AS INDICATED ON HARDWARE SCHEDULE.
- GENERAL CONTRACTOR SHALL COORDINATE KEYING SYSTEM WITH OWNER (BUILDING MANAGEMENT), LANDLORD, AND ARCHITECT. GENERAL CONTRACTOR SHALL COORDINATE SECURITY SYSTEM WITH SYSTEM VENDOR AND SCHEDULED HARDWARE AND THE SUBMITTAL OF ALL SECURITY HARDWARE SPECIFICATIONS AND CUT SHEETS TO THE PROPER AUTHORITIES FOR REVIEW AND APPROVAL DURING BUILDING PERMIT PROCESS.
- 3. PROVIDE HARDWARE, DOOR PULLS, HINGES, CLOSERS, ELECTROMAGNETIC DEVICES, ETC. NEEDED TO PROVIDE A FULL AND COMPLETE INSTALLATION. PROVIDE SILENCERS AT METAL FRAME DOORS. PROVIDE FLOOR MOUNTED DOOR STOPS UNLESS EXISTING CONDITIONS REQUIRE WALL MOUNTED. ENSURE ADEQUATE BLOCKING FOR WALL MOUNTED STOPS. SUBMIT TO ARCHITECT FOR APPROVAL.
- 4. PROVIDE LOWER LOUVRE.
- 5. USE LOW PROFILE ADA COMPLIANT THRESHOLD FOR SLIDING DOOR.
- 6. PROVIDE PANIC HARDWARE.
- 7. PROVIDE TEMPERED GLAZING.
- 8. PROVIDE ACCESSIBLE DOOR SIGNAGE ON DOOR AND WALL MOUNTED ADJACENT TO THE DOOR.
- 9. PROVIDE A READILY VISIBLE DURABLE SIGN POSTED ON THE EGRESS SIDE ON OR ADJACENT TO THE DOOR STATING: THIS DOOR TO REMAIN UNLOCKED WHEN THE BUILDING IS OCCUPIED. THE SIGN SHALL BE IN LETTERS 1 INCH HIGH ON A CONTRASTING BACKGROUND.


WINDOW SCHEDULE


NO.	TYPE	S	IZE	HEAD HEIGHT		DETAIL		NOTES
		WIDTH	HEIGHT		HEAD	JAMB	SILL	
			•			•		
1	Α	3' - 0"	5' - 0"	7' - 0"	31/A-9.2	32/A-9.2	33/A-9.2	
2	Α	3' - 0"	5' - 0"	7' - 0"	31/A-9.2	32/A-9.2	33/A-9.2	
3	Α	3' - 0"	5' - 0"	7' - 0"	31/A-9.2	32/A-9.2	33/A-9.2	
4	Α	3' - 0"	5' - 0"	7' - 0"	31/A-9.2	32/A-9.2	33/A-9.2	
5	Α	3' - 0"	5' - 0"	8' - 0"	31/A-9.2	32/A-9.2	33/A-9.2	
6	Α	3' - 0"	5' - 0"	8' - 0"	31/A-9.2	32/A-9.2	33/A-9.2	
7	С	2' - 6"	6' - 6"	14' - 6"	31/A-9.2	32/A-9.2	33/A-9.2	1
8	С	2' - 6"	6' - 6"	14' - 6"	31/A-9.2	32/A-9.2	33/A-9.2	1
9	D	2' - 4 3/8"	2' - 0"	12' - 5"	31/A-9.2	32/A-9.2	33/A-9.2	1
10	D	2' - 4 3/8"	2' - 0"	2' - 5"	31/A-9.2	32/A-9.2	33/A-9.2	1
11	E	3' - 0"	1' - 6"	9' - 0"	51/A-9.2	52/A-9.2	53/A-9.2	
12	E	3' - 0"	1' - 6"	9' - 0"	51/A-9.2	52/A-9.2	53/A-9.2	
13	E	3' - 0"	1' - 6"	9' - 0"	51/A-9.2	52/A-9.2	53/A-9.2	
14	Е	3' - 0"	1' - 6"	9' - 0"	51/A-9.2	52/A-9.2	53/A-9.2	
15	F	7' - 0"	2' - 0"	12' - 5"	31/A-9.2	32/A-9.2	33/A-9.2	1
16	Α	3' - 0"	5' - 0"	8' - 0"	31/A-9.2	32/A-9.2	33/A-9.2	
17	Α	3' - 0"	5' - 0"	8' - 0"	31/A-9.2	32/A-9.2	33/A-9.2	

WINDOW NOTES

PROVIDE TEMPERED GLAZING.

DOOR TYPES

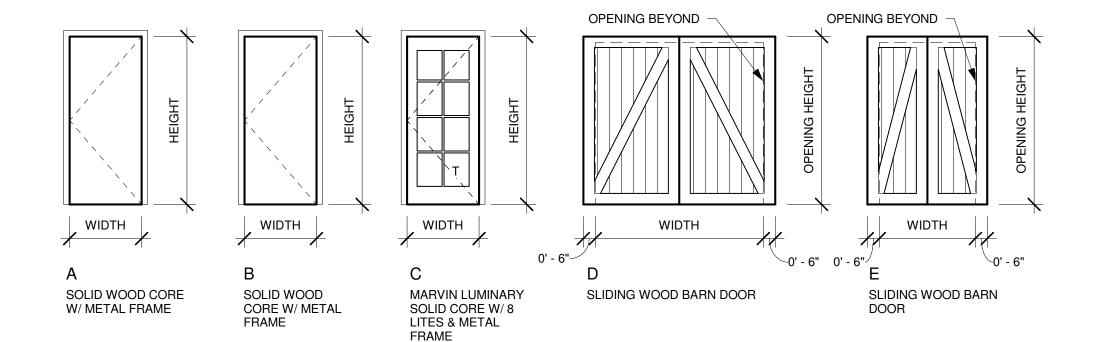


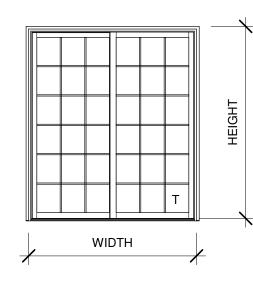

MARVIN INTEGRITY WOOD-ULTREX SLIDING FRENCH DOOR W/ LoE2

NOTE: "T" DESIGNATES TEMPERED GLAZING

WINDOW TYPES

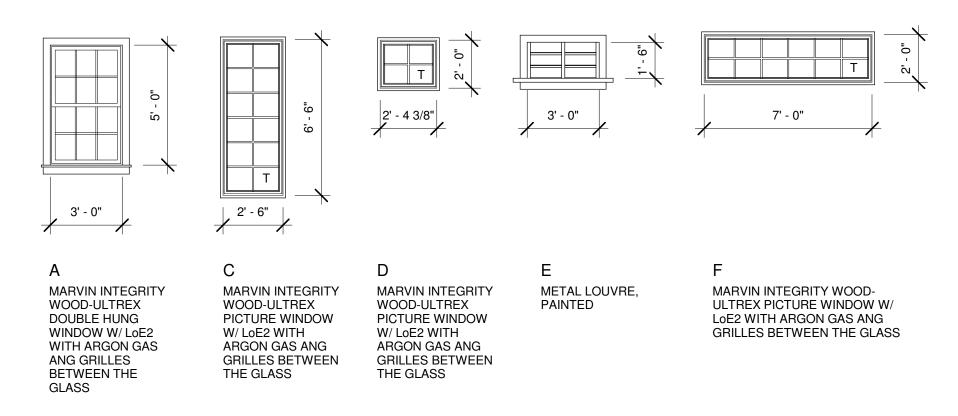

NOTE: "T" DESIGNATES TEMPERED GLAZING

GENERAL NOTES

- THE MINIMUM WIDTH OF EACH DOOR OPENING SHALL BE SUFFICIENT FOR THE OCCUPANT LOAD THEREOF AND SHALL PROVIDE A CLEAR WIDTH OF NOT LESS THAN 32 INCHES.
- THE OPENING FORCE FOR INTERIOR SIDE-SWINGING DOORS WITHOUT CLOSERS SHALL NOT EXCEED A 5-POUND FORCE. FOR OTHER SIDE-SWINGING, SLIDING AND FOLDING DOORS, THE DOOR LATCH SHALL RELEASE WHEN SUBJECTED TO A 15-POUND FORCE. THE DOOR WHALL BE SET IN MOTION WHEN SUBJECTED TO A 30-PUND FOUCE. THE DOOR SHALL SWING TO A FULL-OPEN POSITION WHEN SUBJECTED TO A 15-POUND FORCE. FORCES SHALL BE APPLIED TO THE LATCH SIDE.
- EGRESS DOORS SHALL BE READILY OPENABLE FROM THE EGRESS SIDE WITHOUT THE USE OF A KEY OR SPECIAL KNOWLEDGE OR EFFORT.
- DOOR HANDLES, PULLS, LATCHES, LOCKS AND OTHER OPERATING DEVICES ON DOORS SHALL NOT REQUIRE TIGHT GRASPING, TIGHT PINCHING OR TWISTING OF THE WRIST TO OPERATE.
- DOOR HANDLES, PULLS, LATCHES, LOCKS AND OTHER OPERATING DEVICES SHALL BE INSTALLED 34 INCHES MINIMUM AND 48 INCHES MAXIMUM ABOVE THE FINISHED FLOOR. LOCKS USED ONLY FOR SECURITY PURPOSES AND NOT USED FOR NORMAL OPERATION ARE PERMITEED AT ANY HEIGHT.
- THRESHOLD SHALL BE NOT MORE THAN 1/2" HIGH BEVELED AT 2 HORIZONTAL TO 1 VERTICAL TO A VERTICAL MAXIMUM OF 1/4".



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CENTER

NO. REVISION 1 PLAN CHECK RESUBMITTAL 05/14/10 PROJECT MANAGER CHECKED BY DATE FEBRUARY 01, 2010 PROJECT NUMBER

